



# Application for Planning Approval

## *Land Use Planning and Approvals Act 1993*

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APPLICATION NO.

**DA2026/029**

LOCATION OF AFFECTED AREA

**296 TEA TREE ROAD, BRIGHTON**

DESCRIPTION OF DEVELOPMENT PROPOSAL

### **OUTBUILDING**

A COPY OF THE DEVELOPMENT APPLICATION MAY BE VIEWED AT [www.brighton.tas.gov.au](http://www.brighton.tas.gov.au) AND AT THE COUNCIL OFFICES, 1 TIVOLI ROAD, OLD BEACH, BETWEEN 8:15 A.M. AND 4:45 P.M, MONDAY TO FRIDAY OR VIA THE QR CODE BELOW. ANY PERSON MAY MAKE WRITTEN REPRESENTATIONS IN ACCORDANCE WITH S.57(5) OF THE LAND USE PLANNING AND APPROVALS ACT 1993 CONCERNING THIS APPLICATION UNTIL 4:45 P.M. ON **17/04/2026**. ADDRESSED TO THE CHIEF EXECUTIVE OFFICER AT 1 TIVOLI ROAD, OLD BEACH, 7017 OR BY EMAIL AT [development@brighton.tas.gov.au](mailto:development@brighton.tas.gov.au). REPRESENTATIONS SHOULD INCLUDE A DAYTIME TELEPHONE NUMBER TO ALLOW COUNCIL OFFICERS TO DISCUSS, IF NECESSARY, ANY MATTERS RAISED.

**JANINE BANKS**  
**Acting Chief Executive  
Officer**



**Brighton**  
going places

# PROJECT SPECIFIC

Gary & Samantha Sutcliffe  
296 Tea Tree Road

## Brighton

Tasmanian Planning Scheme

Title Reference : Vol 187572 / Folio 02

**NCC DEEMED TO SATISFY** Mr Marcus Ralph CC1317F  
Climate Zone 7

# SITE INFORMATION


Lot: 02  
Title: 187572 folio 02  
Land Size: 1.001 Ha

Council: Brighton Council Tasmanian planning scheme  
Zoning: 11 Rural Living

Overlays: 13.0 TAS-C13.0 Bushfire Prone Area .7.0 Natural Assets Code  
Tas Veg 4.0 indicates modified land No priority Vegetation

D.A APPROVAL: Planning permit required  
BAL: Refer to report by others if Required  
WIND CLASSISIFCATION : Refer to Shed Tech certification  
CLIMATE ZONE: 7  
ENERGY RATING : Na  
BUILDING CLASSISIFCATION: 10A

Lot 02  
title Reference 187572  
1.05 Ha site area

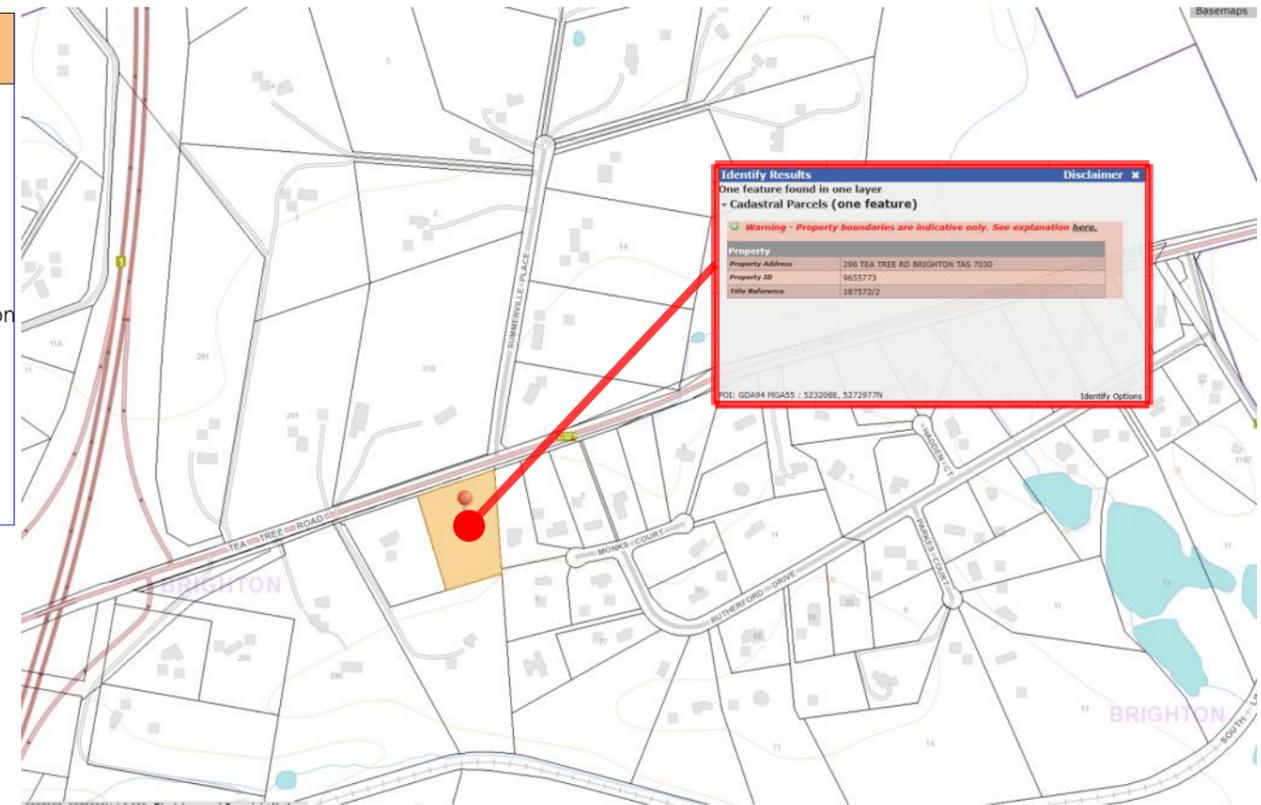

LAYOUT	DRAWING		UPDATED DATE
	ID	NAME	
1037a-00 location information	6.	DRAWING LIST (1)	19/03/2026 11:26 AM
1037a-01 Risk Register	0.	Floor Plan (64)	18/03/2026 2:40 PM
1037a-02 Site Location	0.	Floor Plan (65)	18/03/2026 1:45 PM
1037a-03 Site Plan	0.	Floor Plan (97)	18/03/2026 1:44 PM
1037a-04 Site Plan	0.	Floor Plan (58)	18/03/2026 2:41 PM
1037a-05 Part Site Plan	0.	Floor Plan (58)	18/03/2026 2:41 PM
1037a-06 Floor Plan	0.	Floor Plan (54)	18/03/2026 1:45 PM
1037a-07 Elevations	E/60	WEST ELEVATION	18/03/2026 1:17 PM
1037a-07 Elevations	E/61	WEST ELEVATION	18/03/2026 1:17 PM
1037a-08 Elevations	E/62	WEST ELEVATION	18/03/2026 12:47 PM
1037a-08 Elevations	E/63	WEST ELEVATION	18/03/2026 12:47 PM
1037a-09 Services Plan	0.	Floor Plan (98)	18/03/2026 1:45 PM

## Floor Plan

Proposed Garage 225.00 sqm  
Existing Garage 279.00 sqm  
Total Proposed site cover 561.00 sqm  
Site AREA 1.05 Ha  
Site Coverage 5.60% (less)

# PROPERTY IDENTIFICATION



**MARCUSRALPH**  
Design -architectural animation  
Building designer accreditation CC1317F  
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Richmond, Tasmania 7025  
0409 975 825 mob  
e: marcusralph@bigpond.com

**Residence / Garage**  
Gary & Samantha Sutcliffe  
296 Tea Tree Road  
Brighton

## location information

date  
05/05/2025  
designed and drawn  
**M.Ralph**  
job no:  
**2024-1037**

revision-date  
Design Drawing  
drawing no:  
**1037a-00**

ACTIVITY /PROCESS	POTENTIAL HAZZARD	(S)	(L)	(R)	PRINCIPLE OF AVOIDING / REDUCING RISK	ACTION ON REMAINING AREAS OF RISK
<b>SITE LAYOUT</b>						
SITE ACCESS / TRAFFIC	IMPACT BY MOVING VEHICLES OR PLANT	H	M	3	OPERATE TRAFFIC MANAGEMENT PLAN WITH BANKSMEN ECT.	CONTRACTOR TO DEFINE WORK AREAS AND WORK SEQUENCE THE ENTRY , EXIT ANDACCESS WAYS IN THEWORKPLACE ARE KEPT CLEAN AND CLEAR OF MATERIAL AND WASTE
SITE ADJACENT WATER/ SWIMMING POOL	DROWNING	H	L	2	BARRICADE ALL AREAS OF WATER	CONTRACTOR TO PREPARE METHOD STATEMENT IF WORKING ABOVE WATER
EXISTING SERVICES ABOVE GROUND ,(IE ELECTRICAL)	ELECTRICAL SHOCK FROM OVERHEAD LINES	H	L	2	CLEARLY IDENTIFY EXCLUSION ZONES AND APPROACH DISTANCES FROM OVERHEAD SERVICES	CONTRACTOR TO DEFINE WORKING AREAS AND ENFORCE EXCLUSION ZONES / APPROACH DISTANCES
UNSTABLE RETAINING WALLS	FAILURE / COLLAPSE OF RETAINING WALL	H	L	2	PROVIDE DESIGN RESTRICTIONS ON NEW RETAINING WALLS DO NOT APPLY EXTRA LOAD TO EXISTING RETAINING WALLS (IE EXTRA MATERIAL OR CONSTRUCTION VEHICLES BEHIND WALL ECT.)	CONTRACTOR TO CONTACT QUALIFIED ENGINEER IF UNSURE
<b>DEMOLITION</b>						
UNSTABLE STRUCTURE	FAILURE / COLLAPSE OF STRUCTURE	H	L	2	CONTRACTOR TO PROVIDE TEMPORY SUPPORT AND CONTACT QUALIFIED ENGINEER IF UNSURE	CONTRACTOR TO PREPARE METHOD STATEMENT
<b>DANGEROUS MATERIALS / SUBSTANCES</b>						
ASBESTOS	INHALATION OF ASBESTOS FIBRE OR MATERIALS CONTAINING ASBESTOS	H	L	2	CONTRACTOR TO USE LICENSED REMOVALIST	NO WORK TO BE CARRIED OUT UNTIL ASBESTOS HAS BEEN REMOVED
CHEMICAL / EXPOSURE	INHALATION OF DANGEROUS CHEMICAL OR EXPLOSION	H	L	2	AVOID USING DANGEROUS CHEMICAL OR EXPLOSIVES ON SITE	CONTRACTOR TO PREPARE METHOD STATEMENT IF CHEMICALS / EXPLOSIVES ARE SPRESENT ON SITE STORE IN A SAFE AREA
<b>EXCAVATION</b>						
EXCAVATION GENERALLY	HITTING EXISTIGN BURRIED SERVICES OR STRUCTURE	H	M	3	DIAL BEFORE YOU DIG PLAN BUILD TASMANIA IDENTIFY AND ISOLATE EXISTIGN BELOW GROUND SERVICES	CONTRACTOR TO CONTACT 'DIAL BEFORE YOU DIG'. CONTRACTOR TO CAT SCAN BEFORE DIGGING WITH DUE CARE.
DEEP EXCAVATION	INSTABILITY OF EXCAVATIONS OR COLLAPSE	H	M	3	OBTAIN AND EVALUATE DATA ON EXISTING GROUND CONDITIONS. DO NOT ENTER EXCAVATIONS DEEPER THAN 1.2m UNLESS PROPPED. MINIMISE EXCAVATION, NUMBER OF OPERATIONS AND TIME REQUIRED BELOW GROUND.	CONTRACTOR TO PREPARE METHOD STATEMENT. CONTRACTOR TO PROVIDE SHORING TO EXCAVATIONS AS NECESSARY TO PREVENT SIDES FROM COLLAPSING.
EARTH MOVING	GROUND CONTAMINATION	M	M	2	OBTAIN AND EVALUATE DATA ON EXISTING GROUND CONDITIONS.	CONTRACTOR PROVIDED WITH APPROPRIATE DATA ON GROUND CONDITIONS, I.E. SITE INVESTIGATION REPORT
EXCAVATION NEAR EXISTING STRUCTURE	INSTABILITY OF STRUCTURE/EXCAVATIONS	H	L	2	DO NOT DIG BELOW EXISTING FOOTING LEVEL OR UNDER 45 DEGREE LINE FROM UNDERSIDE OF EXISTING FOOTING WITHOUT PERMISSION FROM QUALIFIED ENGINEER	CONTRACTOR TO PREPARE METHOD STATEMENT
AUGURING	FALLS INTO OPEN BORES	M	M	2	CONCRETE OPEN BORES AS SOON AS POSSIBLE	AVOID PROLONGED OPENING OF BORES. PROTECT OPEN BORES.
WORKING IN CONFINED SPACE	LACK OF OXYGEN/IGNITION OF FLAMMABLE CONTAMINANTS	H	L	2	AVOID ENTERING CONFINED SPACE/ ONLY TRAINED WORKERS TO ENTER CONFINED SPACE.	CONTRACTOR TO PREPARE METHOD STATEMENT
<b>CONSTRUCTION</b>						
PRECAST CONCRETE ELEMENTS	INSTABILITY OF TEMPORARY STRUCTURE	H	L	2	ALL PRECAST ELEMENTS TO BE TEMPORARILY FOUNDED AND SUPPORTED UNTIL PERMANENTLY SECURED AS SPECIFIED IN DESIGN DOCUMENTATION	CONTRACTOR TO PREPARE TEMPORARY WORKS DESIGN AND METHOD STATEMENT
FALLING FROM HEIGHT	FALLS FROM GREATER THAN 2m	H	M	3	CONTRACTOR TO COMPLETE WORKS FROM GROUND LEVEL IF POSSIBLE. CONTRACTOR TO USE PASSIVE FALL PREVENTION DEVICE IF POSSIBLE (I.E. FIXED PLATFORM, CHERRY PICKERS ETC.)	WORKER TO USE FALL ARREST HARNESS SYSTEM
TEMPORARY SUPPORT	FAILURE/COLLAPSE OF STRUCTURE	H	M	3	CONTRACTOR TO SUPPLY TEMPORARY SUPPORT/BRACING TO STRUCTURE AND CONTACT QUALIFIED ENGINEER IF UNSURE	CONTRACTOR TO PREPARE METHOD STATEMENT
UNSTABLE STRUCTURE	COLLAPSE CAUSED BY CONSTRUCTION LOADS	H	L	2	PROVIDE INFORMATION ON LOAD ALLOWANCE FOR CONTRACTOR TO DESIGN BACK PROPPING	CONTRACTOR TO MAINTAIN BACK PROPS FOR SUFFICIENT TIME
LIFTING EQUIPMENT	LARGE/HEAVY OBJECTS FALLING FROM HEIGHT	H	L	2	ALL LIFT EQUIPMENT TO BE STAMPED WITH SAFE WORKING LOAD AND CERTIFICATES KEPT UP TO DATE	ONLY LIFT ITEMS WITHIN SAFE WORKING LOAD OF LIFTING EQUIPMENT
CRANES	INSTABILITY DURING OPERATION	H	L	2	AVOID SPECIFYING UNUSUALLY LARGE OR UNUSUALLY SHAPED ITEMS WHERE POSSIBLE. DO NOT SET UP CRANE IN CLOSE PROXIMITY OF BASEMENT/EXISTING SERVICES UNDERGROUND	CONTRACTOR TO PREPARE METHOD STATEMENT

## CONSTRUCTION RISK ASSESSMENT

THIS CONSTRUCTION RISK ASSESSMENT IS TO HIGHLIGHT TO THE BUILDER, SUB CONTRACTORS AND SUB CONSULTANTS THE MAIN RICK FACTORS IN UNDERTAKING THE CONSTRUCTION OF THE WORKS TO WHICH THESE NOTES FORM PART OF THE WORKING DRAWINGS.

THIS ASSESSMENT IN NOT EXHAUSTIVE AND THE BUILDER IS TO UNDERTAKE THEIR OWN SIMILAR ASSESSMENT AND MAINTAIN APPROPRIATE RISK MANAGEMENT ACTIVITIES FOR THE DURATION OF THE CONSTRUCTION PERIOD.

IT IS THE BUILDER RESPONSIBILITY TO ENSURE ALL PERSONNEL THAT ENTER THE CONSTRUCTION SITE ARE BRIEFED ON THE SPECIFIC SAFETY HAZARDS AND RISKS ASSOCIATED WITH THE DAILY ACTIVITIES.

WORKS ARE TO BE CARRIED OUT IN ACCORDANCE WITH CURRENT WORK AND WORK AND HEALTH SAFETY REQUIREMENTS. THIS SITE SPECIFIC RISK ASSESSMENT ASSIGNS A RISK RATING ACCORDING TO THE FOLLOWING MATRIX. THIS ASSIGNS THE MAIN CONSTRUCTION TASK A LIKELIHOOD (L), SEVERITY (S) AND RESULTING RISK RATING (R).

MARCUS RALPH DESIGN HAS TO THE BEST OF THEIR ABILITY, UNDERTAKEN TO IDENTIFY POTENTIAL CONSTRUCTION HAZARDS AND MINIMIZE THE RISK POTENTIAL TO THOSE INVOLVED WITH THE CONSTRUCTION OF THESE WORKS.

### RISK RATING (R)

3- HIGH RISK ACTION REQUIRED BY CONTRACTOR TO MITIGATE OR ELIMINATE RISK

2- MEDIUM RISK ACTION REQUIRED BY CONTRACTOR TO REDUCE RISK

1 - LOW RISK NO DIRECT ACTION REQUIRED BY THE CONTRACTOR

RISK RATING CALCULATOR		SEVERITY (S)			
		H	M	L	OTHER INJURY OF ILLNESS
LIKELIHOOD (L)	H	CERTAIN OR NEAR CERTAIN	1	1	2
	M	REASONABLY LIKELY	1	2	3
	L	VERY SELDOM	2	3	3

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**Residence / Garage**  
Gary & Samantha Sutcliffe  
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Brighton

**Risk Register**

date

05/05/2025

designed and drawn

revision-date

**M.Ralph**


**Design Drawing**

job no:

drawing no:

**2024-1037**

**1037a-01**

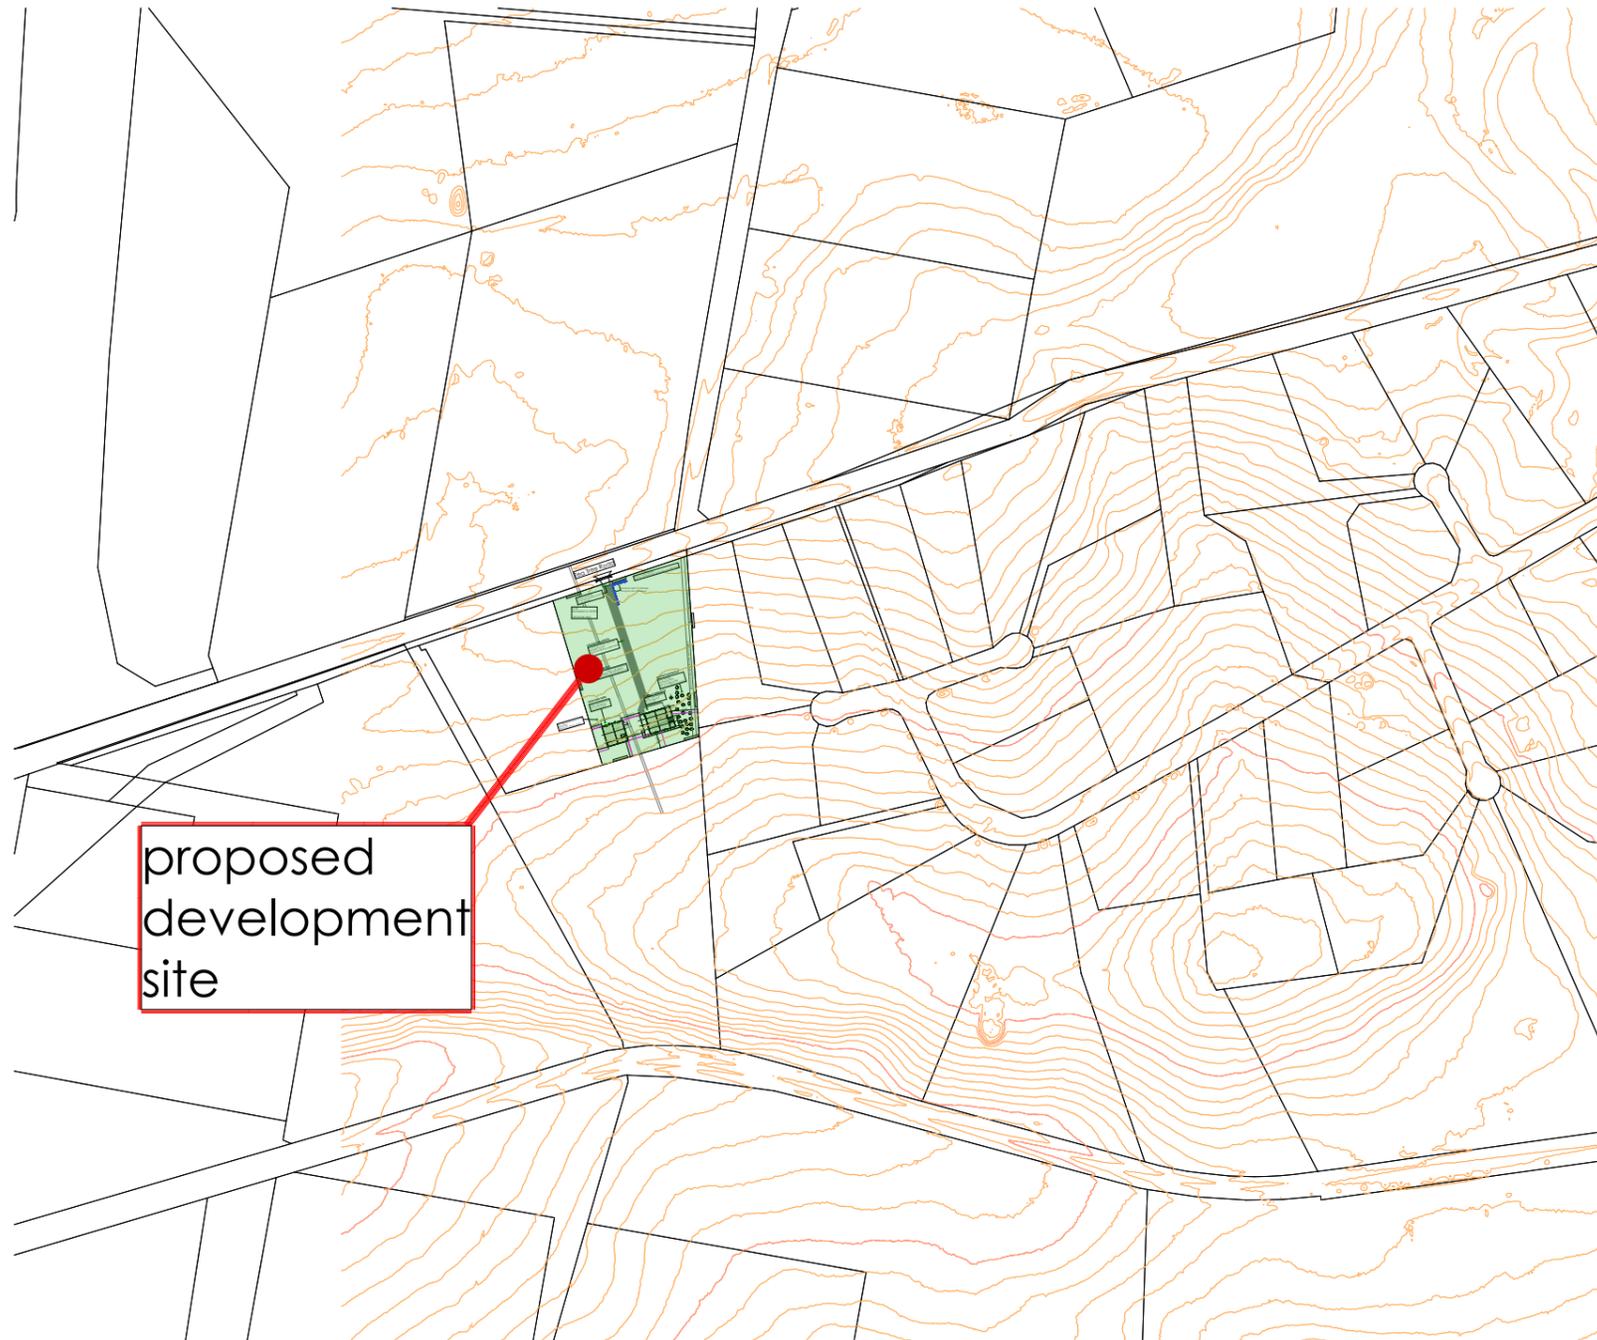

proposed  
development  
site

Lot 02  
title Reference 187572  
  
1.05 Ha site area

Floor Plan	
Proposed Garage	225.00 sqm
Existing Garage	279.00 sqm
Total Proposed site cover	561.00 sqm
Site AREA	1.05 Ha
Site Coverage	5.60% (less)


Site Plan  
scale 1:5000

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Site Location 

date	05/05/2025
designed and drawn	revision-date
<b>M.Ralph</b>	Design Drawing
job no:	drawing no:
<b>2024-1037</b>	<b>1037a-02</b>



Lot 02  
 title Reference 187572  
 1.05 Ha site area

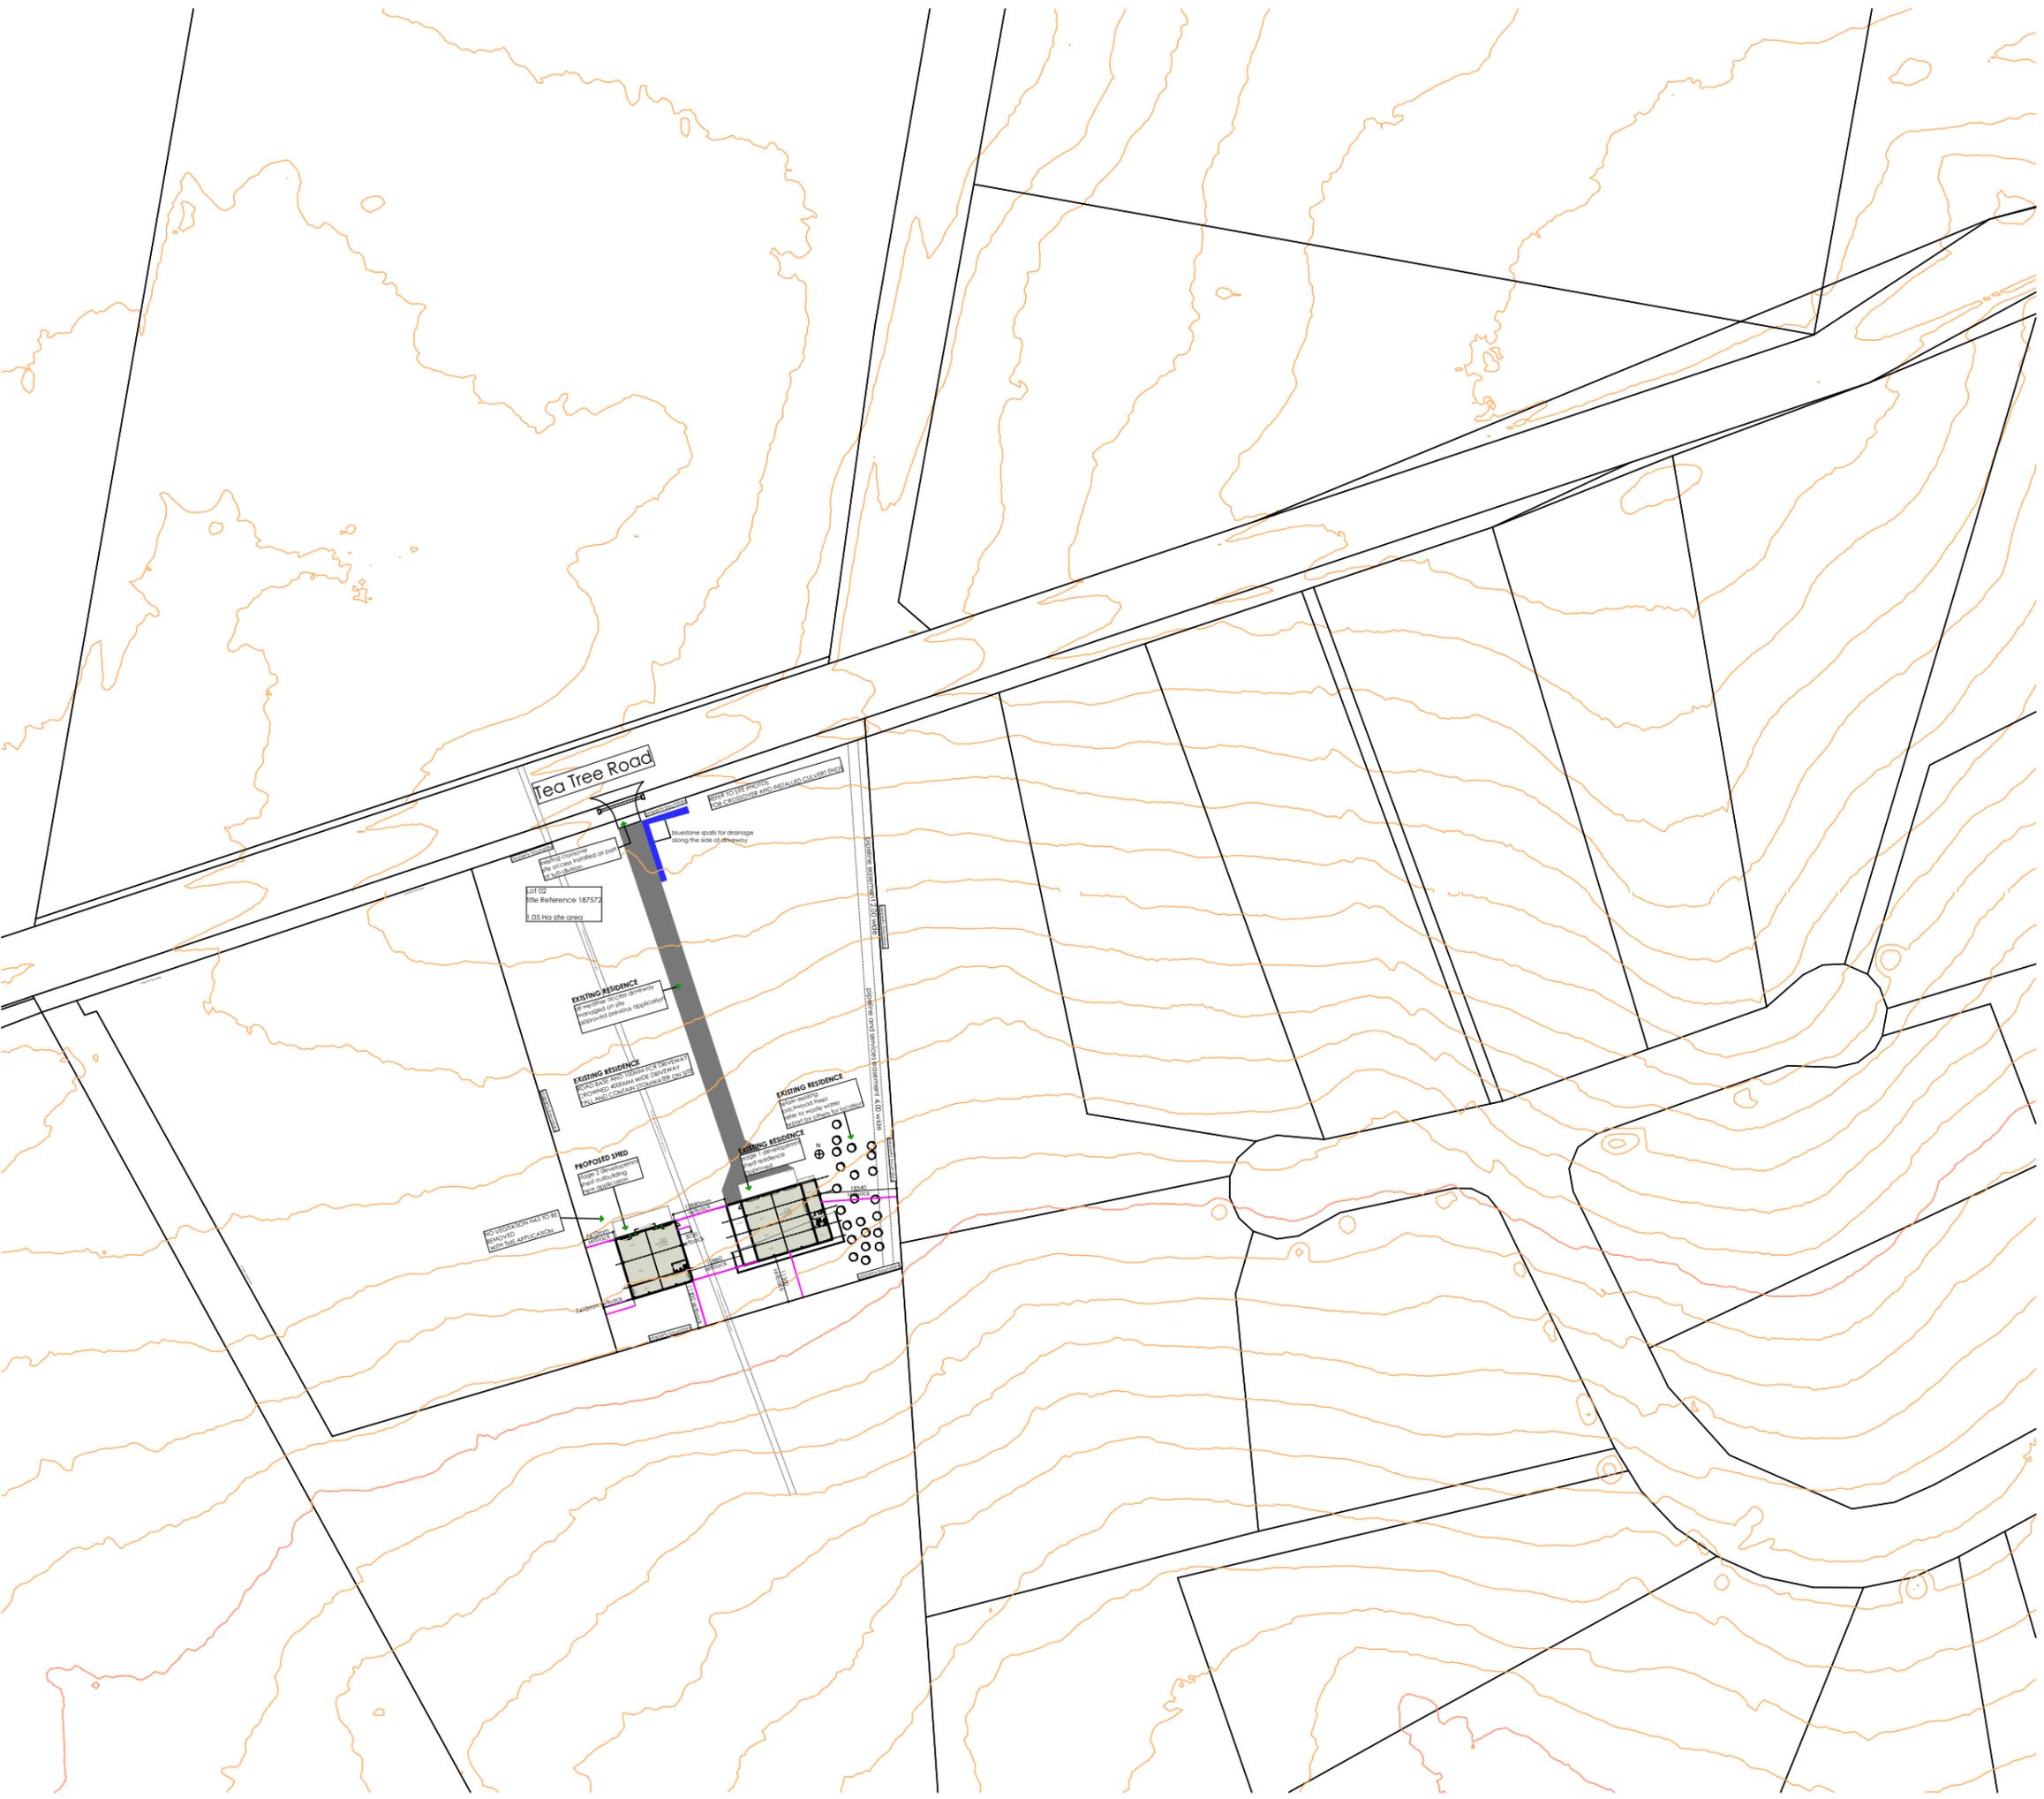
Floor Plan	
Proposed Garage	225.00 sqm
Existing Garage	279.00 sqm
Total Proposed site cover	561.00 sqm
Site AREA	1.05 Ha
Site Coverage	5.60% (less)

## Site Plan scale 1:1500

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**Residence / Garage**  
 Gary & Samantha Sutcliffe  
 296 Tea Tree Road  
 Brighton

Site Plan	
date	05/05/2025
designed and drawn	revision-date
<b>M.Ralph</b>	Design Drawing
job no:	drawing no:
<b>2024-1037</b>	<b>1037a-03</b>

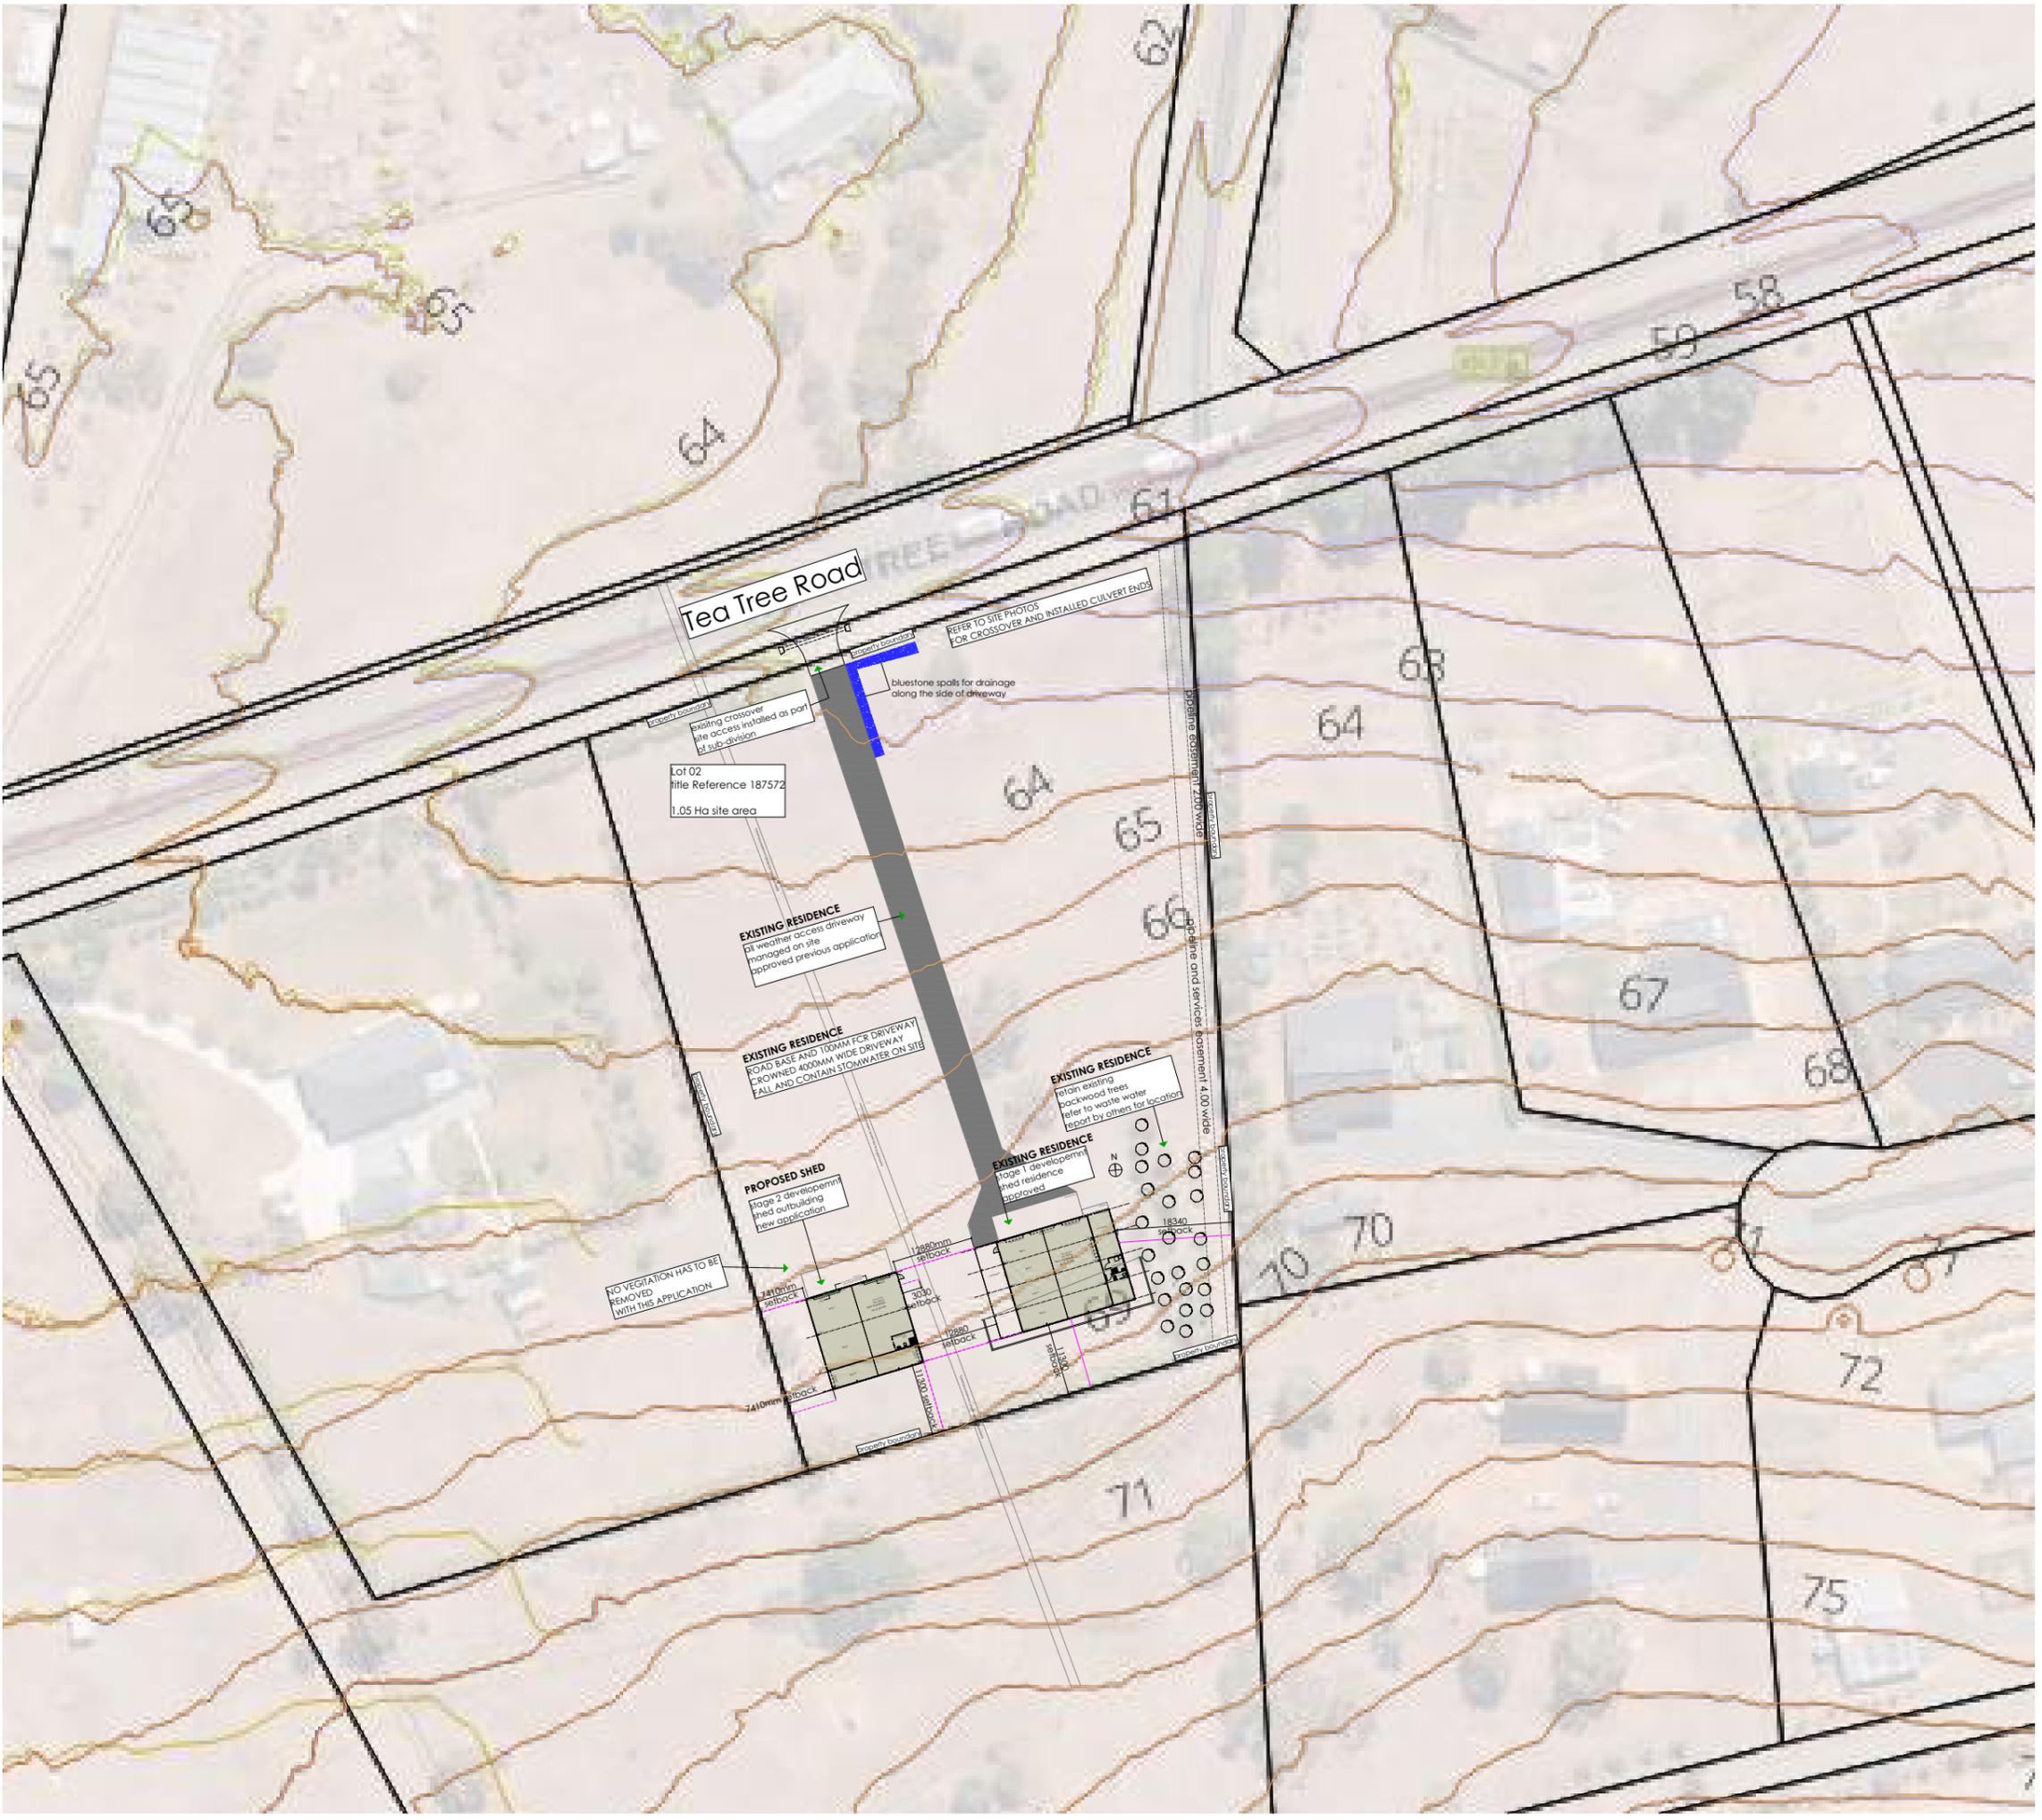

Lot 02  
 title Reference 187572

1.05 Ha site area

**Floor Plan**

Proposed Garage	225.00 sqm
Existing Garage	279.00 sqm
Total Proposed site cover	561.00 sqm
Site AREA	1.05 Ha
Site Coverage	5.60% (less)

**Site Plan**  
 scale 1:1000

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**Residence / Garage**  
 Gary & Samantha Sutcliffe  
 296 Tea Tree Road  
 Brighton

**Site Plan**

date  
 05/05/2025

designed and drawn  
**M.Ralph**

revision-date  
 Design Drawing

job no:  
**2024-1037**

drawing no:  
**1037a-04**

**EXISTING ROAD BASE AND 100 CROWNED 4000MM WIDE DRAINAGE FALL AND CONTAIN STOMWATER ON**

**EXISTING RESIDENCE**  
retain existing backwood trees refer to waste water report by others for location

**EXISTING RESIDENCE**  
stage 1 developemnt shed residence approved

**PROPOSED SHED**  
stage 2 developemnt shed outbuilding new application

Lot 02  
title Reference 187572  
1.05 Ha site area

Floor Plan	
Proposed Garage	225.00 sqm
Existing Garage	279.00 sqm
Total Proposed site cover	561.00 sqm
Site AREA	1.05 Ha
Site Coverage	5.60% (less)

**Site Plan**  
scale 1:500



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296 Tea Tree Road  
Brighton

**Part Site Plan**

date	05/05/2025
designed and drawn	revision-date
<b>M.Ralph</b>	Design Drawing
job no:	drawing no:
<b>2024-1037</b>	<b>1037a-05</b>

# PLUMBING LAYOUT

SCALE 1:100

Sewer and Stormwater lines are to be run along the underside concrete floor within compacted FCR.  
 When under a concrete slab or timber floor installation will comply with AS3500.  
 Refer to roof plan for fixing requirements of down pipes.  
 Connection to council main or treatment plant will be inspected and approved by Local council inspectors.

### PIPE SIZES RECOMENDED

#### PLUMBING LEGEND:

1. wc dn100
2. urinal dn40,50
3. sink dn50,
4. basin dn40,dn50
- 5 bath dn40, dn50
6. shower dn50, dn 65 recommended
7. trough dn40,dn50,dn65 or dn100

fwg floor waste gully primed by basin ,sink or trough  
 dn 50 or from which fixture size is priming.

soil classification requires the plumbing contractor to take necessary measures to prevent UPVC AND PVC pipework and all water connection to new rigid building structure to have flexible joint. refer to csiro advice and NCC for pipe connection details for reactive clay soils



### LEGEND

- smoke detector hard wired to electrical system
- extractor fan with heating elements optional
- DP downpipe
- AJ articulation joint
- METER BOX meter box

### LEGEND:

- dw - dishwasher
- hp - hot plates
- ubo - under bench oven
- wo - wall oven bank
- sink - stainless kitchen sink
- sh - shower
- bth - bath
- wc - toilet
- spa - spa bath
- vb - vanity basin
- tr - laundry trough
- wm - washing machine
- mh - manhole
- ds or shs-structural support

820 door door width

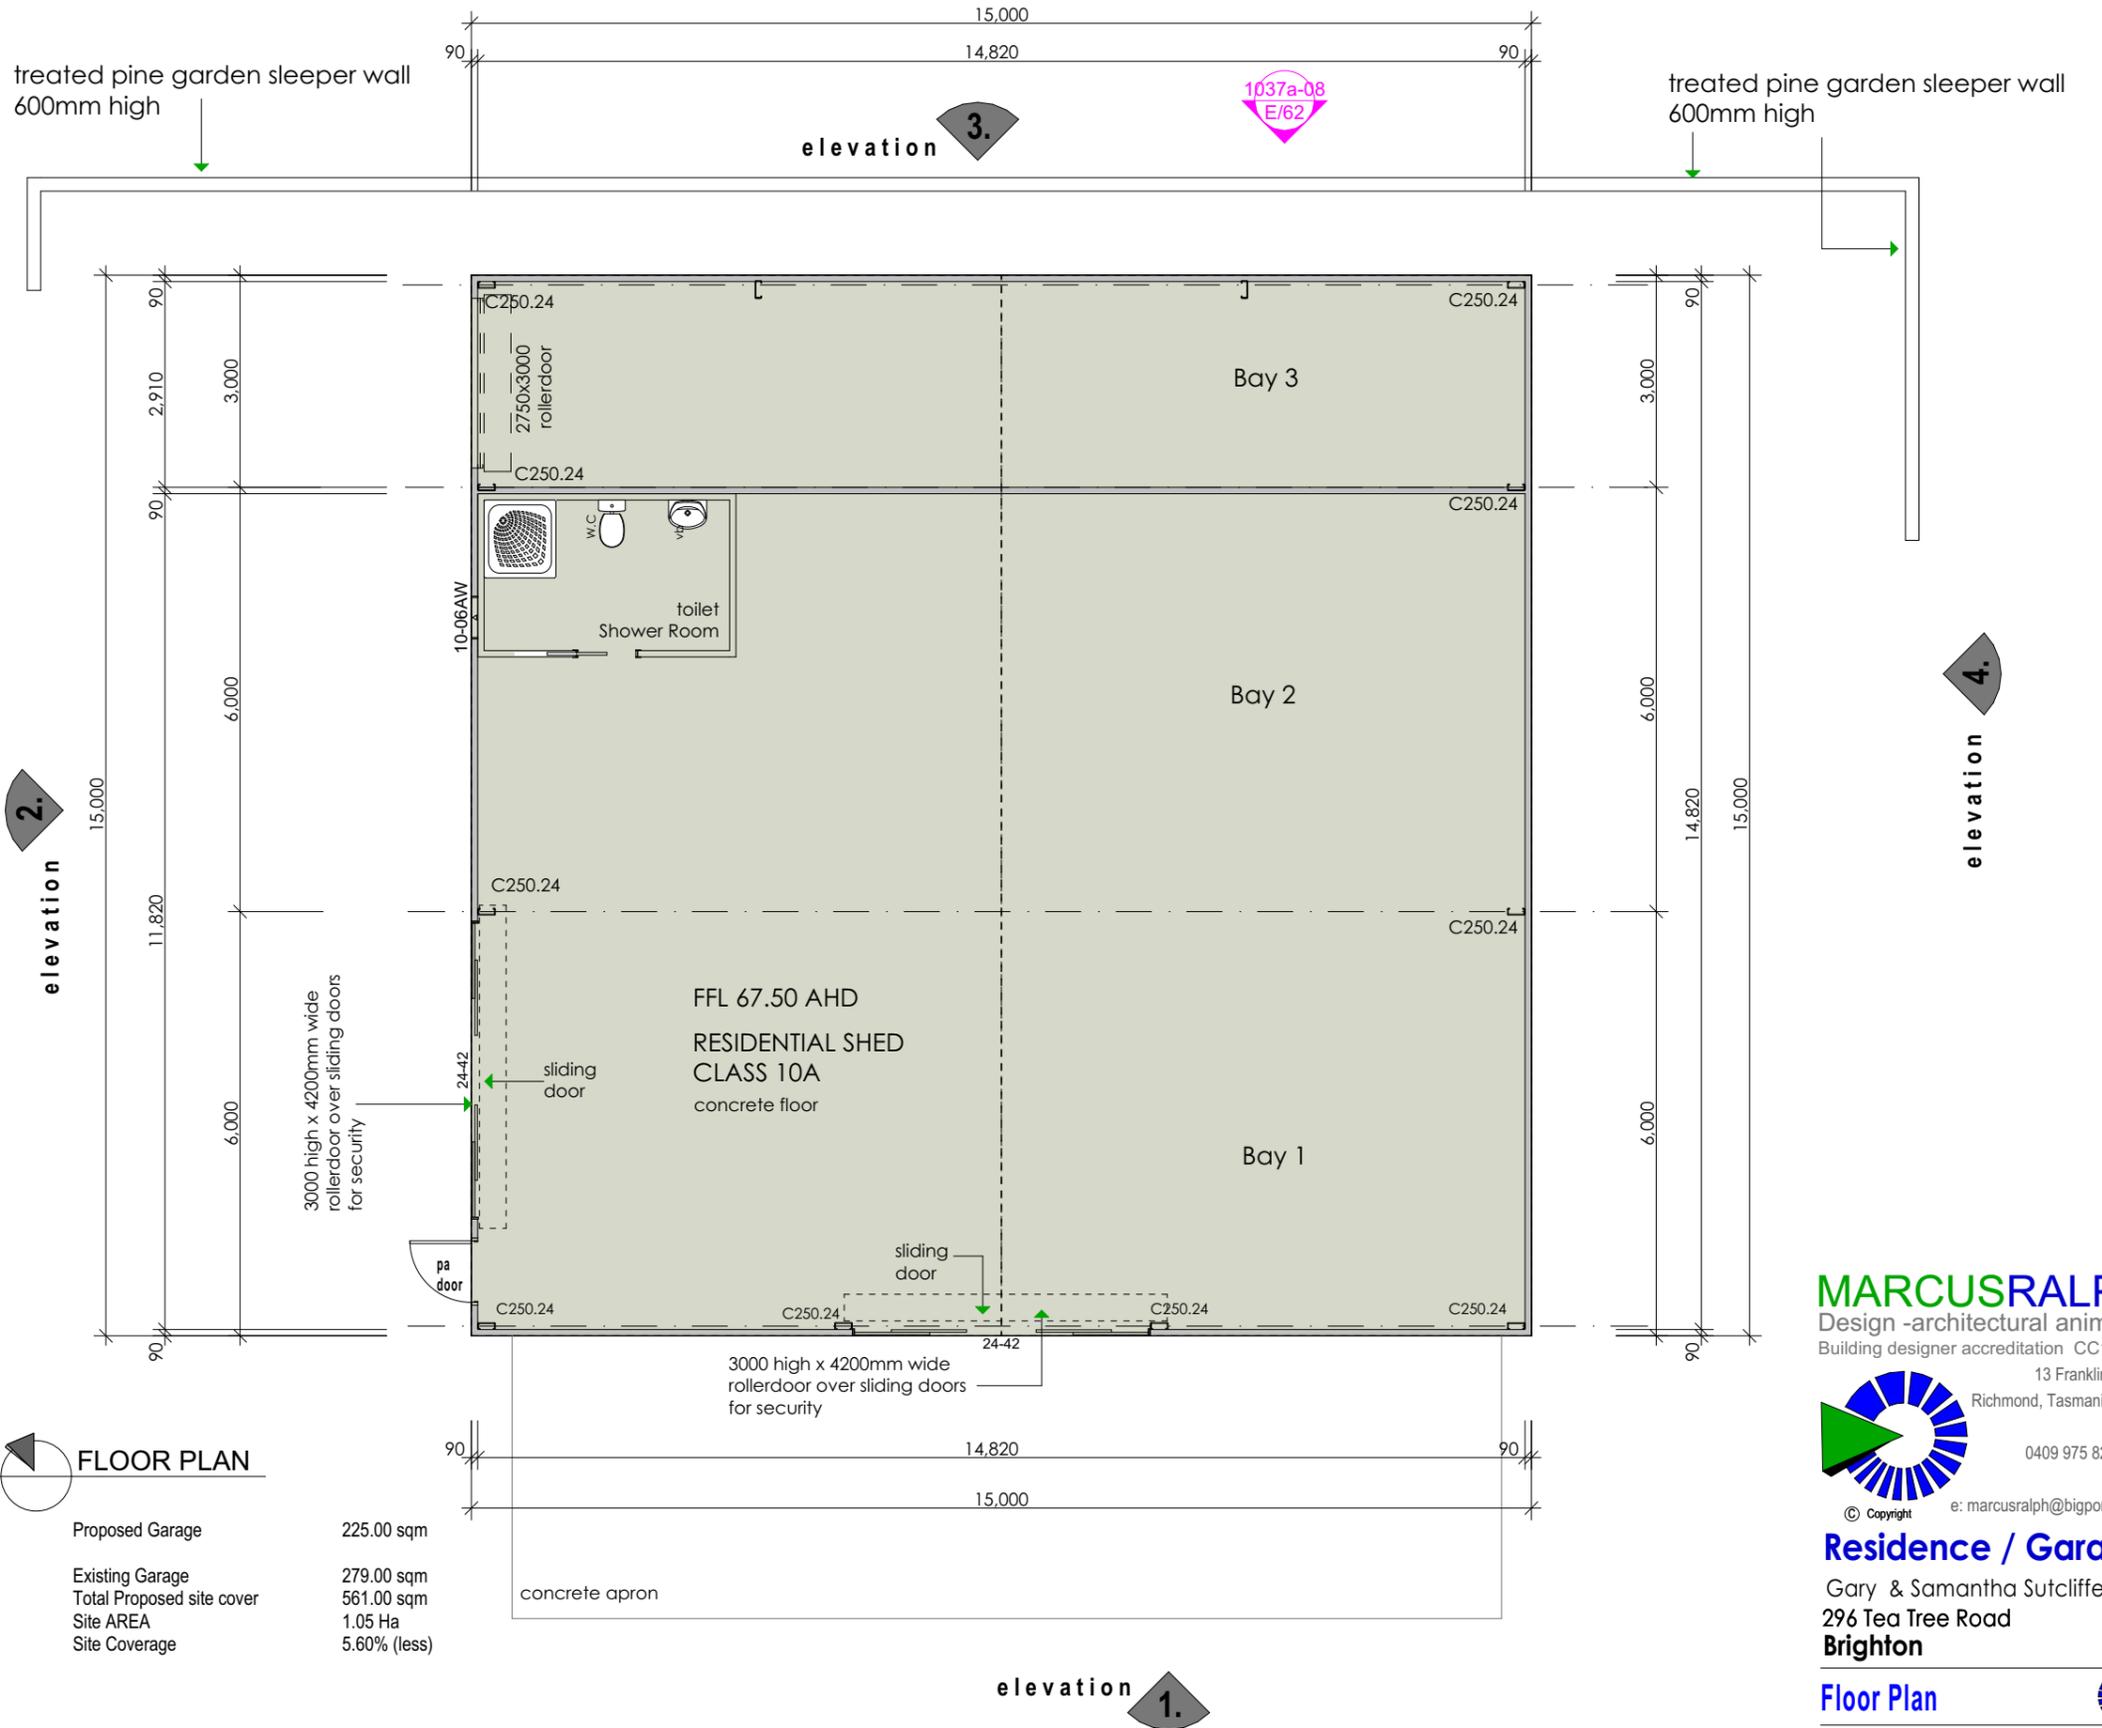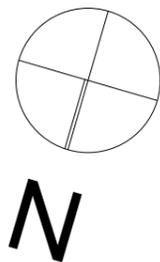

## MARCUSRALPH

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## Residence / Garage

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 296 Tea Tree Road  
 Brighton

### Floor Plan

date  
 05/05/2025

designed and drawn  
**M.Ralph**


revision-date  
 Design Drawing

job no:  
**2024-1037**

drawing no:  
**1037a-06**

**Proposed colours**

- New Roof colorbond Monument LRV Value 10
- Flashings and gutter Monument LRV Value 10
- New colorbond wall cladding Ironstone LRV Value10
- New Rollerdoors colour Monument LRV Value 10

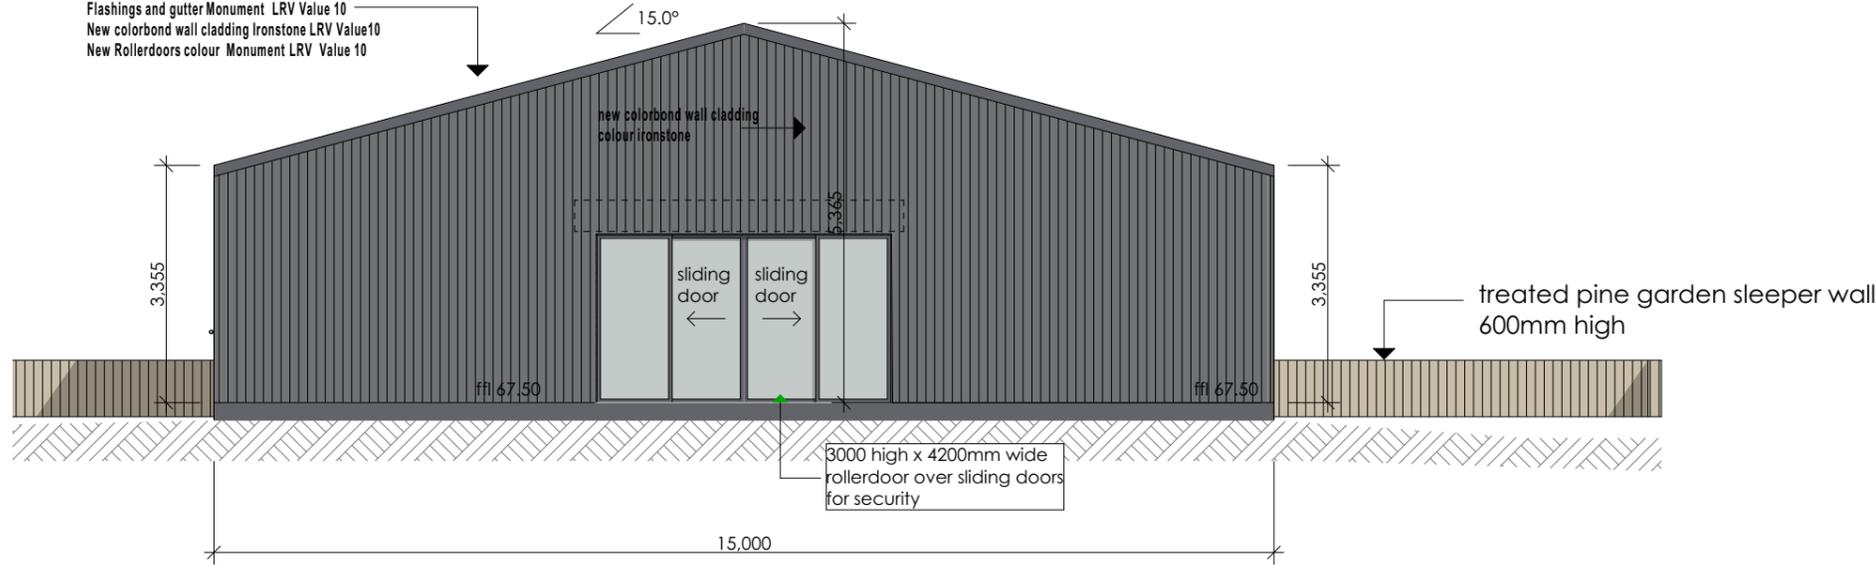


**ELEVATION 01**

NORTH ELEVATION

scale 1:100

**Proposed colours**

- New Roof colorbond Monument LRV Value 10
- Flashings and gutter Monument LRV Value 10
- New colorbond wall cladding Ironstone LRV Value10
- New Rollerdoors colour Monument LRV Value 10

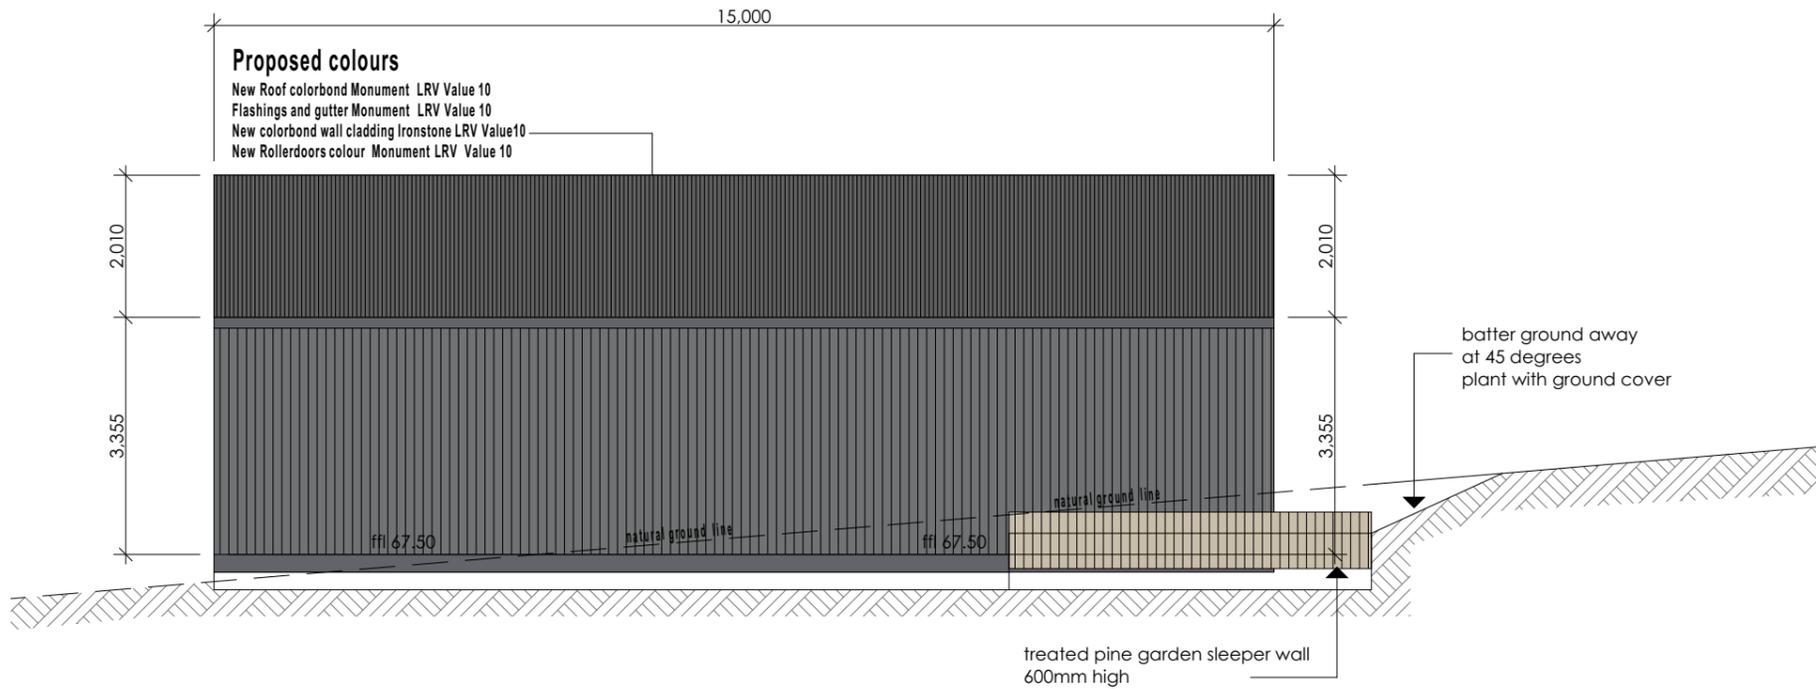

**ELEVATION 04**


WEST ELEVATION

scale 1:100

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296 Tea Tree Road  
Brighton

**Elevations**

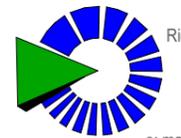

date

05/05/2025

designed and drawn

**M.Ralph**

job no:


**2024-1037**

revision-date

Design Drawing

drawing no:


**1037a-07**

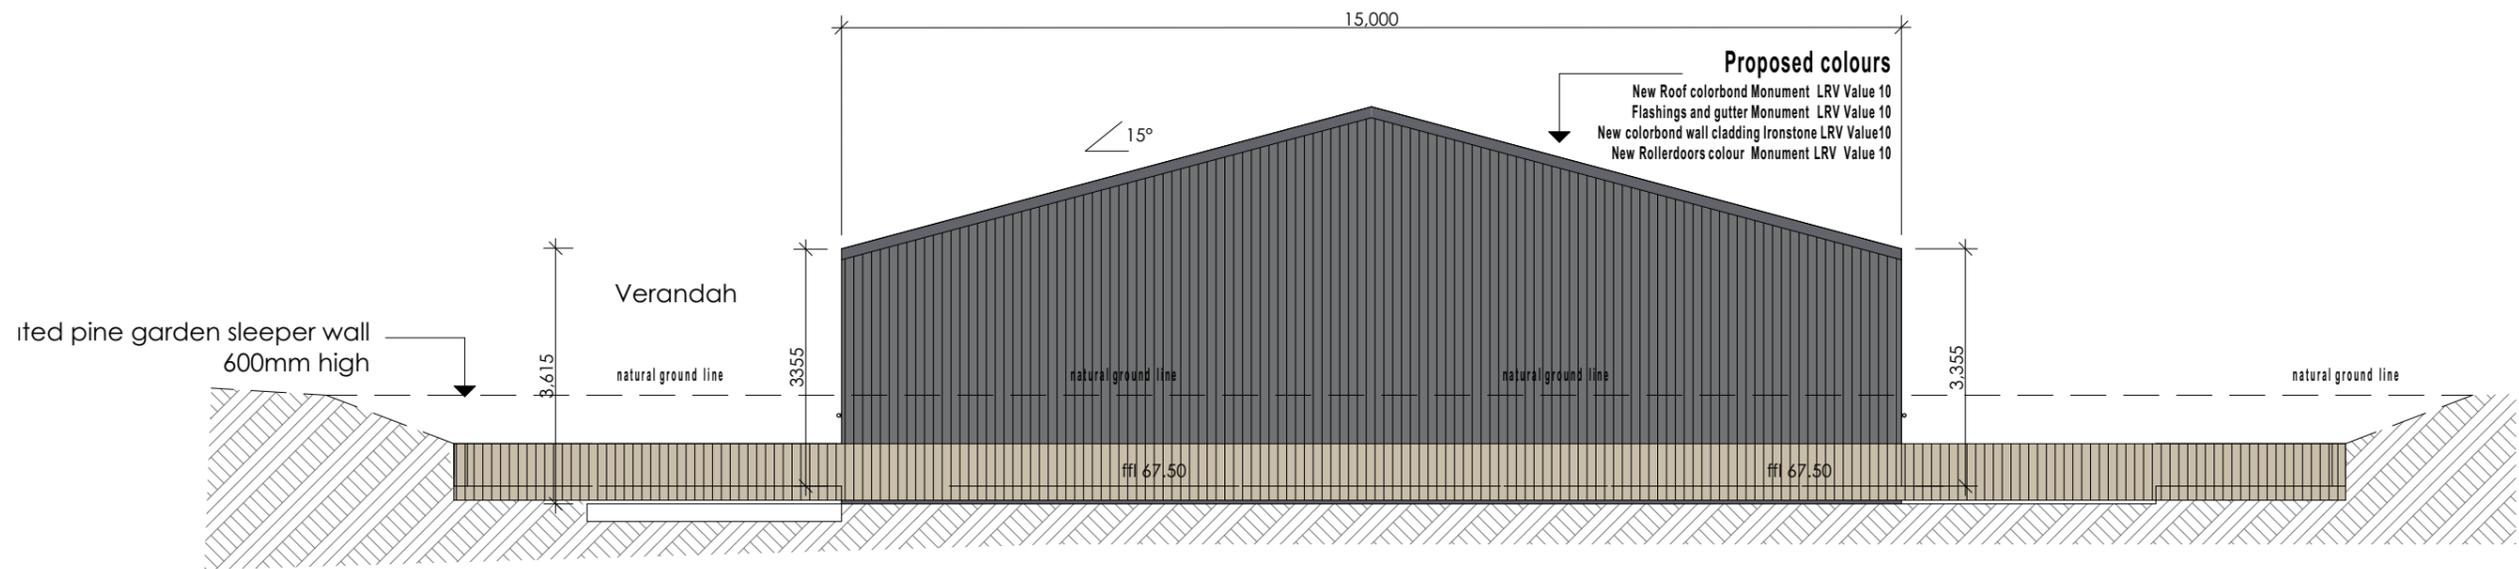

### ELEVATION 03

SOUTH ELEVATION

scale 1:100

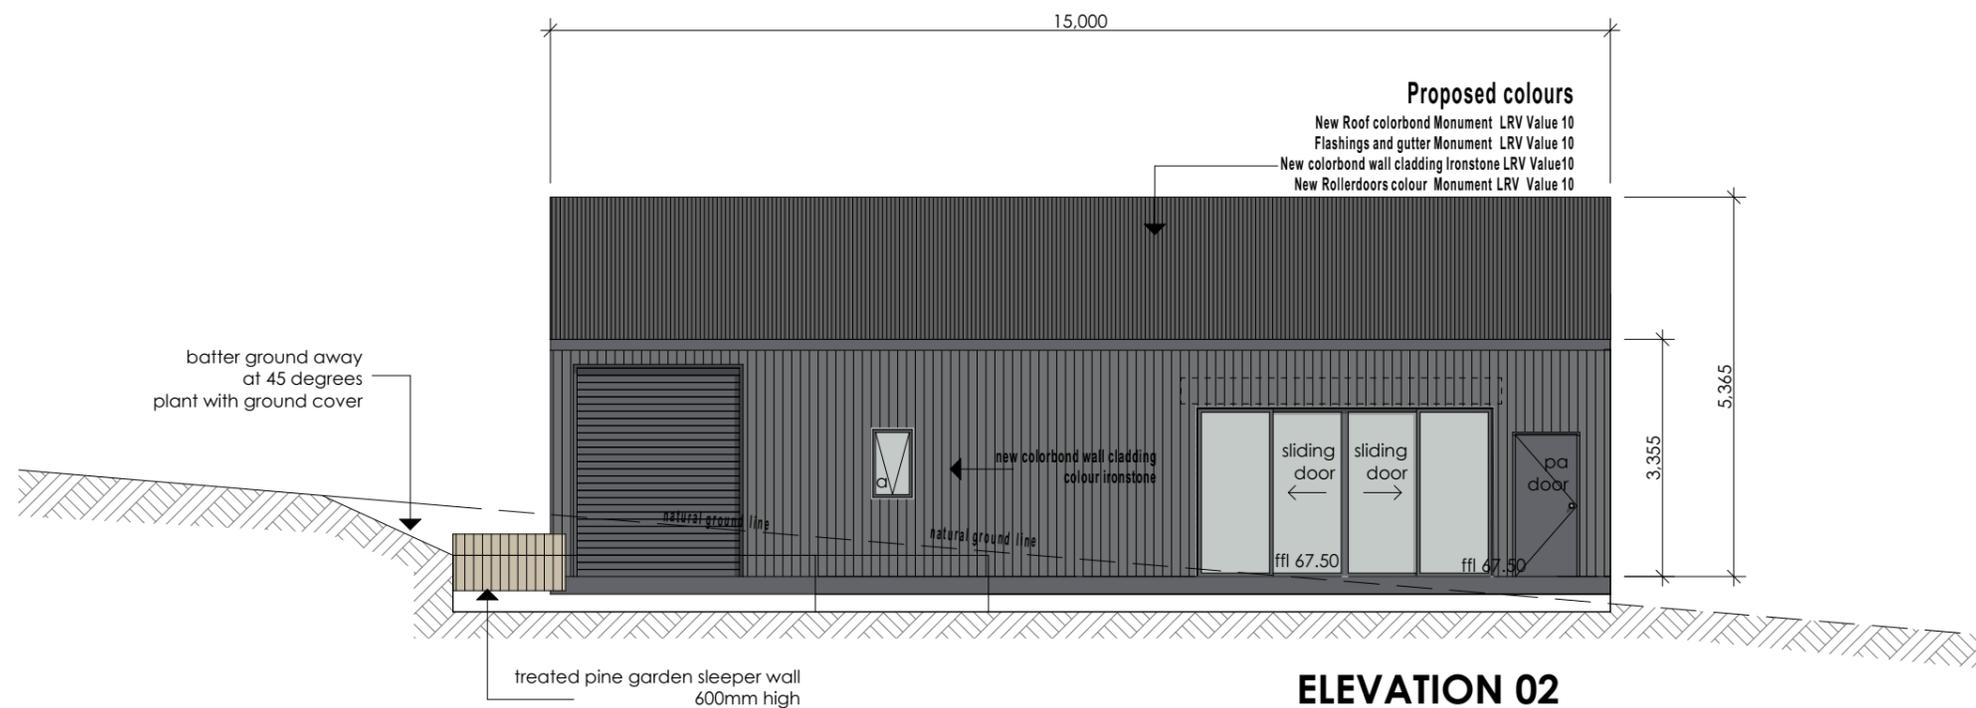

### ELEVATION 02


EAST ELEVATION

scale 1:100

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Brighton

**Elevations**

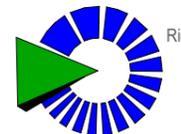

date

05/05/2025

designed and drawn

**M.Ralph**

job no:

**2024-1037**

revision-date

Design Drawing

drawing no:

**1037a-08**

# Tea Tree Road

200x300 dn 100 culvert  
 head at end of pipe  
 LOCATED INSIDE BOUNDARY LINE  
 STORMWATER TO FLOW TO SPOON DRAIN  
 LOCATED AT FRONT OF PROPERTY  
 DOWN SLOPE OF INSTALLED CULVERT

Existing dn 20 water connection  
 Meter ID 85EN0130938339  
 to be retained and existing installed water meter  
 Maximo Location ID L21461

existing crossover  
 site access installed as part  
 of sub-division

REFER TO SITE PHOTOS  
 FOR CROSSOVER AND INSTALLED CULVERT ENDS

bluestone spalls for drainage  
 along the side of driveway

ROAD BASE AND 100MM FCR DRIVEWAY  
 CROWN 400MM WIDE DRIVEWAY  
 FALL AND CONTAIN STOMWATER ON SITE

Lot 02  
 title Reference 187572  
 1.05 Ha site area

pipeline easement 2.00 wide

pipeline and services easement 4.00 wide

7410mm setback

7410mm setback

12880 setback

11300 setback

18340 setback

12000 setback

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**Services Plan**

date	05/05/2025
designed and drawn	revision-date
<b>M.Ralph</b>	Design Drawing
job no:	drawing no:
<b>2024-1037</b>	<b>1037a-09</b>

