



Application for Planning Approval

Land Use Planning and Approvals Act 1993

APPLICATION NO.

DA2025/210

LOCATION OF AFFECTED AREA

7A FORD ROAD, PONTVILLE

DESCRIPTION OF DEVELOPMENT PROPOSAL

SINGLE DWELLING

A COPY OF THE DEVELOPMENT APPLICATION MAY BE VIEWED AT www.brighton.tas.gov.au AND AT THE COUNCIL OFFICES, 1 TIVOLI ROAD, OLD BEACH, BETWEEN 8:15 A.M. AND 4:45 P.M, MONDAY TO FRIDAY OR VIA THE QR CODE BELOW. ANY PERSON MAY MAKE WRITTEN REPRESENTATIONS IN ACCORDANCE WITH S.57(5) OF THE LAND USE PLANNING AND APPROVALS ACT 1993 CONCERNING THIS APPLICATION UNTIL 4:45 P.M. ON **21/01/2026**. ADDRESSED TO THE CHIEF EXECUTIVE OFFICER AT 1 TIVOLI ROAD, OLD BEACH, 7017 OR BY EMAIL AT development@brighton.tas.gov.au. REPRESENTATIONS SHOULD INCLUDE A DAYTIME TELEPHONE NUMBER TO ALLOW COUNCIL OFFICERS TO DISCUSS, IF NECESSARY, ANY MATTERS RAISED.

JAMES DRYBURGH
Chief Executive Officer



Brighton
going places



CREATIVE HOMES HOBART, CNR OF ELWICK ROAD & BROOKER HIGHWAY, GLENORCHY 7010 PH: 03 6272 3000

PROJECT ADDRESS: 7A FORD ROAD, PONTVILLE

TITLE REFERENCE: VOLUME: 188441 FOLIO: 1

CLIENTS: GAILEEN DOYLE

DESIGNER: Inge Brown, CC 6652

DRAWINGS:

- 01 COVER PAGE
- 02 PROPOSED SITE PLAN
- 03 PROPOSED FLOOR PLAN
- 04 PROPOSED ROOF PLAN
- 05 PROPOSED ELEVATIONS
- 06 PROPOSED ELEVATIONS
- 07 SECTION A-A
- 08 TYPICAL SECTION DETAILS
- 09 WINDOW SCHEDULE

FLOOR AREAS:	FLOOR AREA:	146.7 m ²
	PORCH:	14.6 m ²
	GARAGE:	27.5 m ²
	ALFRESCO:	17.6 m ²
	TOTAL AREA:	206.5 m ²

SOIL CLASSIFICATION: --

WIND CLASSIFICATION: --

CLIMATE ZONE: 7

BUSHFIRE ATTACK LEVEL: N/A - NOT WITHIN OVERLAY

ALPINE AREA: N/A

CORROSION ENVIRONMENT: N/A

DOCUMENTATION INDEX

The documentation listed below should be read in conjunction with these drawings and form the basis of construction documentation for the project

[illegible]

GENERAL NOTES:

1. THIS PLAN HAS BEEN PREPARED BY SURVEY PLUS FROM A COMBINATION OF EXISTING RECORDS AND FIELD SURVEY FOR THE PURPOSES OF SHOWING THE PHYSICAL FEATURES OF THE LAND AND SHOULD NOT BE USED FOR ANY OTHER PURPOSE.

2. TITLE BOUNDARIES SHOWN WERE NOT VERIFIED OR MARKED BY SURVEY PLUS AT THE TIME OF THIS SURVEY.

3. SERVICES SHOWN ON THIS PLAN WERE LOCATED WHERE POSSIBLE BY FIELD SURVEY. THEY ARE NOT A COMPLETE PICTURE OF SERVICES ON SITE. ALL SERVICE LOCATIONS ARE TO BE VERIFIED BEFORE COMMENCEMENT OF ANY WORK ON SITE, IN PARTICULAR THOSE SERVICES NOT PREVIOUSLY LOCATED THROUGH FIELD SURVEY.

4. SURVEY PLUS CAN NOT ACCEPT LIABILITY WHATSOEVER FOR LOSS OR DAMAGE CAUSED TO ANY UNDERGROUND SERVICE WHETHER SHOWN BY OUR SURVEY OR NOT.

5. THIS NOTE IS AN INTEGRAL PART OF THIS PLAN/DATA. REPRODUCTION OF THIS PLAN OR ANY PART OF IT WITHOUT THIS NOTE BEING INCLUDED IN FULL WILL RENDER THE INFORMATION SHOWN ON SUCH A REPRODUCTION INVALID AND NOT SUITABLE FOR USE WITHOUT PRIOR AUTHORITY OF SURVEY PLUS.

6. HORIZONTAL DATUM IS MGA (GDA94).

7. VERTICAL DATUM IS AHD.

8. CONTOUR INTERVAL IS 0.2 METRE, INDEX IS 1.0 METRE.

9. SURVEY BY ROBOTIC TOTAL STATION AND RTK GPS.

10. IMPORTED DATA SHOWN ON THIS PLAN WAS OBTAINED FOR PUBLIC AVAILABLE DATA FROM VARIOUS GOVERNMENT AUTHORITIES. THIS INFORMATION IS PROVIDED FOR GUIDANCE ONLY. THE ACCURACY OF ANY IMPORTED DATA IS PER THE ACCURACY QUOTED BY THE SOURCE AND IS IN NO WAY GUARANTEED BY SURVEY PLUS. USERS MUST NOT RELY ON THIS DATA FOR ON-GROUND LOCATION OF BOUNDARIES AND/OR SERVICES.

LIST DATA IMPORT

- TasWater-SewerLateralLine
- TasWater-SewerMain
- TasWater-SewerMaintenanceHole
- TasWater-SewerPressurisedMain
- TasWater-WaterHydrant
- TasWater-WaterLateralLine
- TasWater-WaterMain

11. BOUNDARIES ARE COMPILED ONLY FROM SP188441 AND RELEVANT SURVEY INFORMATION OBTAINED FROM LAND TITLES OFFICE AND ARE APPROXIMATE AND SUBJECT TO SURVEY.

12. ALL WINDOWS WERE NOT ABLE TO BE LOCATED DUE TO OBSTRUCTION OF LINE OF SIGHT FROM TOTAL STATION. WINDOW LOCATIONS ARE APPROXIMATE ONLY DUE TO BEING UNABLE TO BE PERPENDICULAR TO WINDOWS WHEN LOCATING WITH TOTAL STATION.


13. 3D DATA TURNED OFF IN LAYER CONTROL.

- 3D TIN
- MAJOR CONTOUR 3D
- MINOR CONTOUR 3D

LEGEND

CLC = Communication Lot Connection
ELC = Electricity Lot Connection
FP = Fire Plug
WLC = Water Lot Connection
WM = Water Meter
MH1 = Sewer Manhole
Top RL:34.93
In Inv1 RL:33.80
In Inv2 RL:33.77
Out Inv RL:33.73
HW1 = Stormwater Headwall
Top RL:34.89
In Inv RL:34.35

BM1 = BENCH MARK
R/Set in Apron
RL:35.20
HW2 = Stormwater Headwall
Top RL:34.83
Out Inv RL:34.27

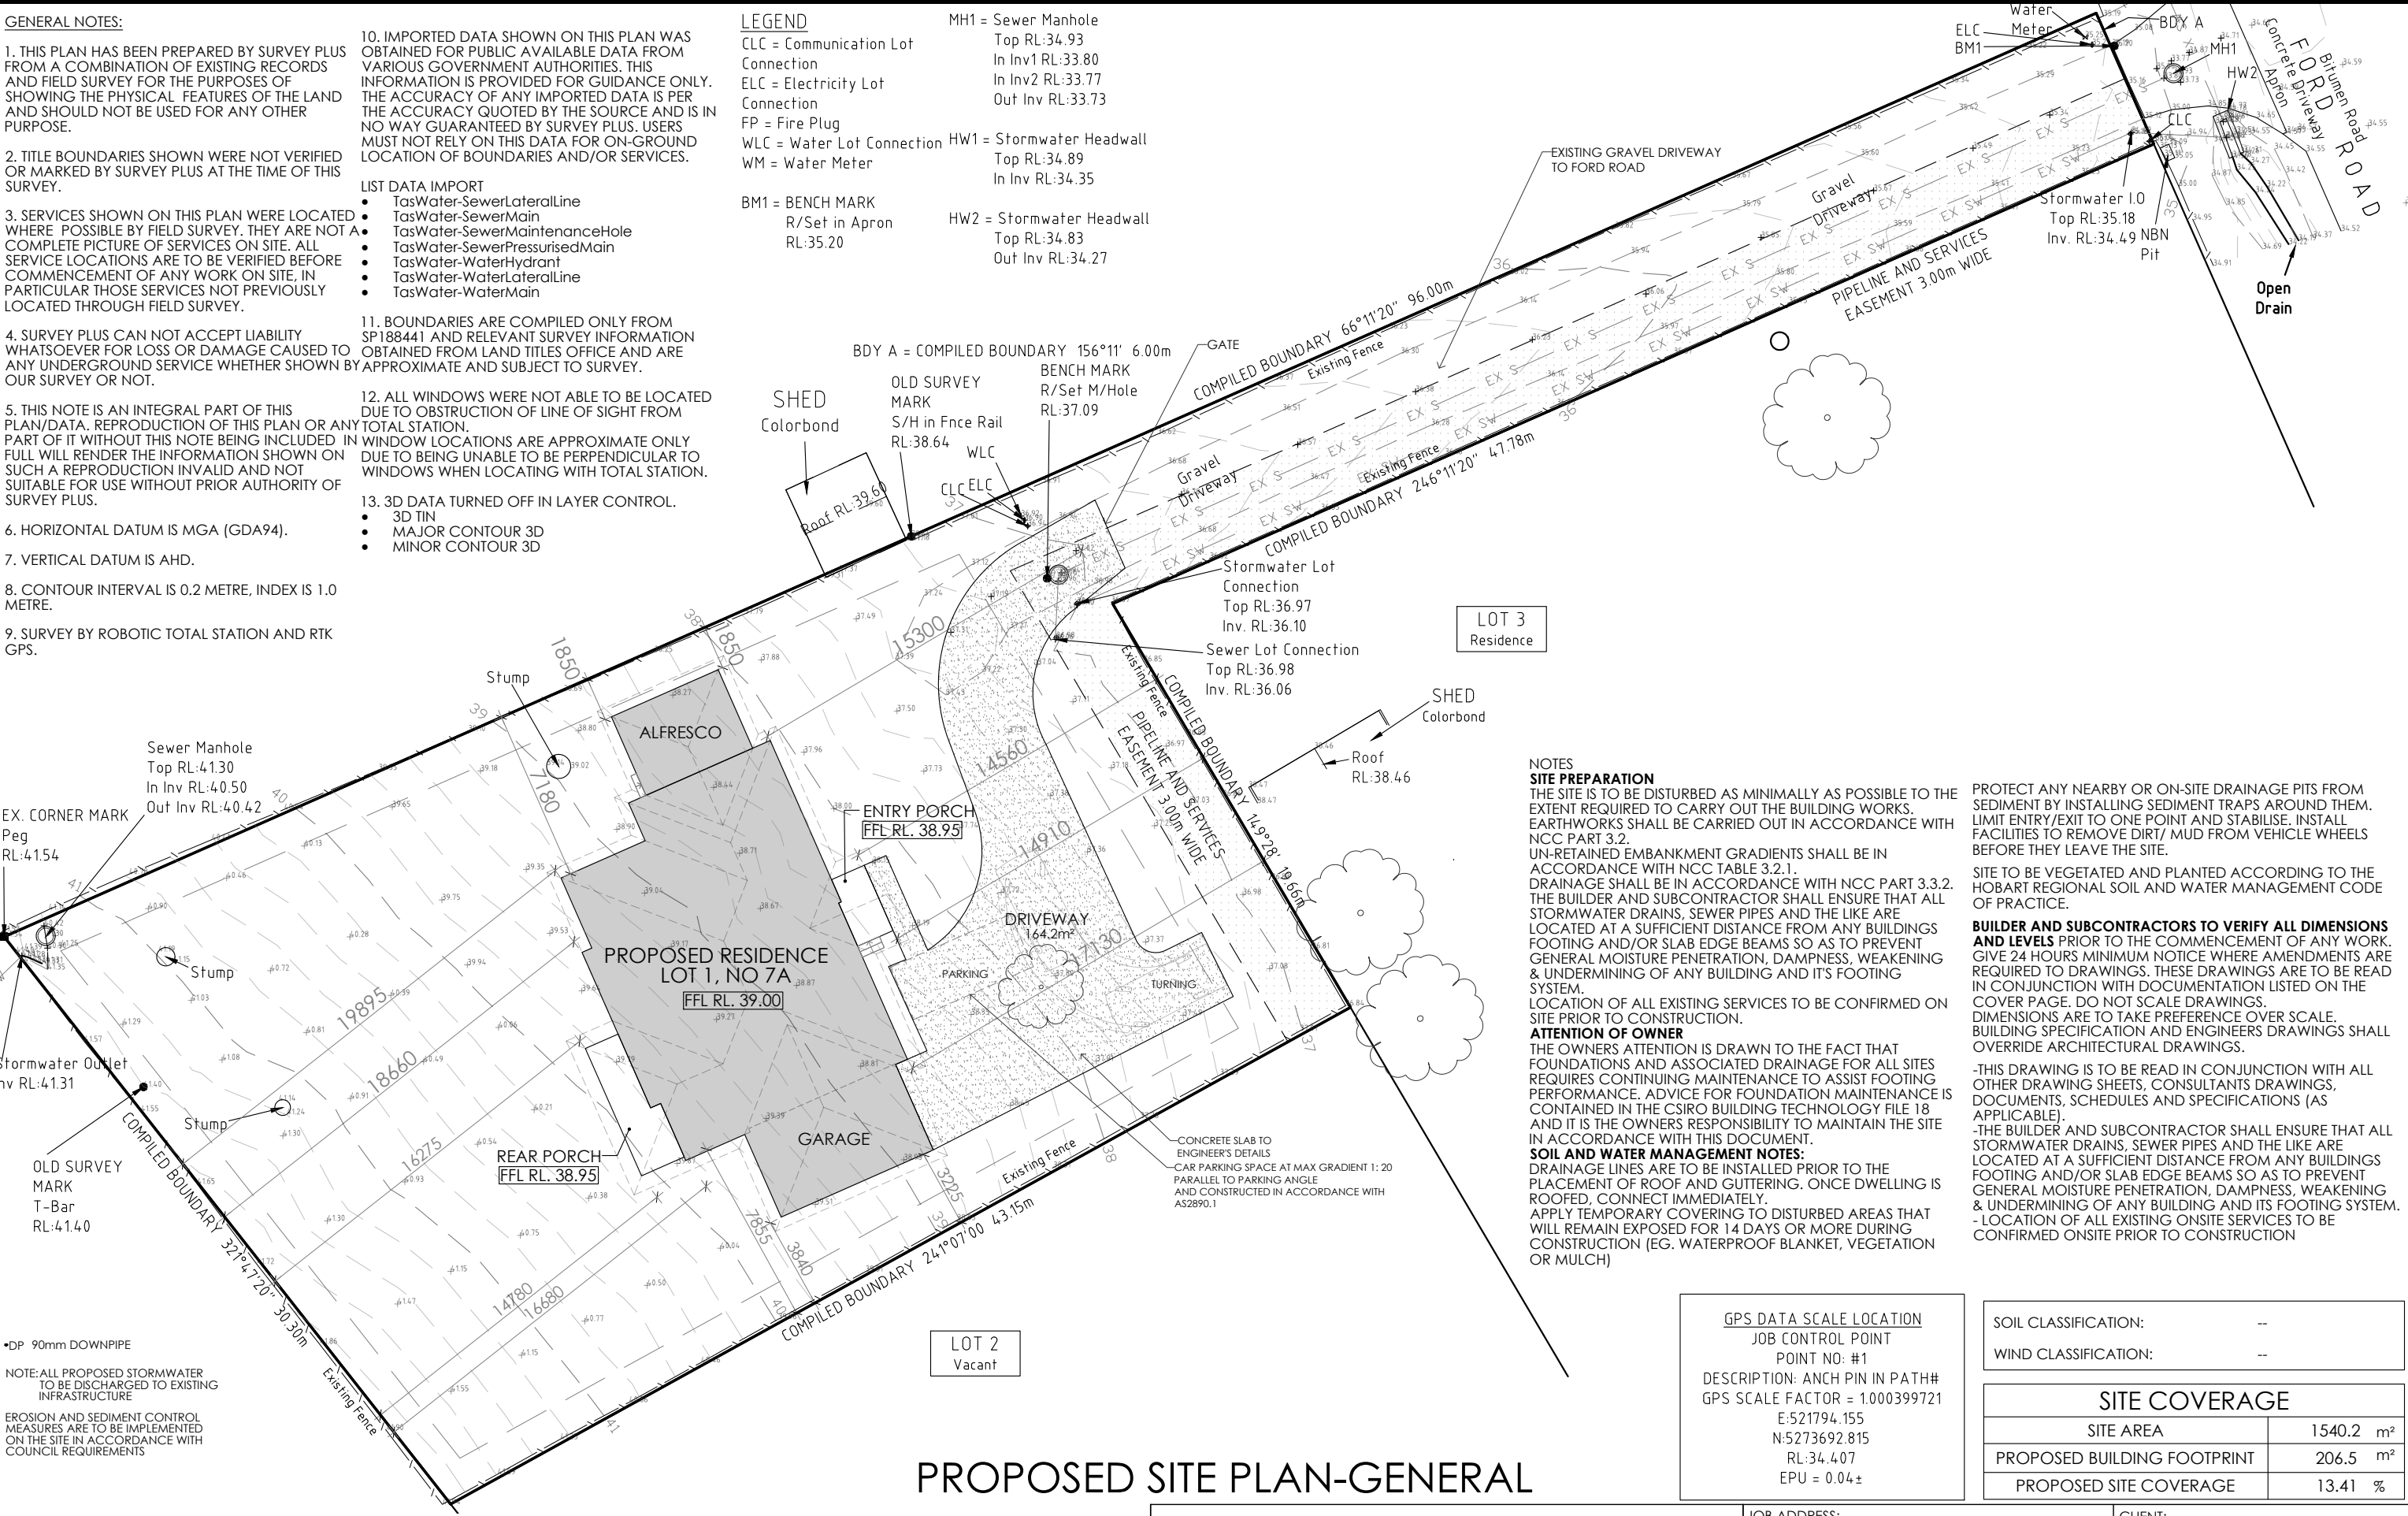

NOTES

SITE PREPARATION

THE SITE IS TO BE DISTURBED AS MINIMALLY AS POSSIBLE TO THE EXTENT REQUIRED TO CARRY OUT THE BUILDING WORKS. EARTHWORKS SHALL BE CARRIED OUT IN ACCORDANCE WITH NCC PART 3.2. UN-RETAINED EMBANKMENT GRADIENTS SHALL BE IN ACCORDANCE WITH NCC TABLE 3.2.1. DRAINAGE SHALL BE IN ACCORDANCE WITH NCC PART 3.3.2. THE BUILDER AND SUBCONTRACTOR SHALL ENSURE THAT ALL STORMWATER DRAINS, SEWER PIPES AND THE LIKE ARE LOCATED AT A SUFFICIENT DISTANCE FROM ANY BUILDINGS FOOTING AND/OR SLAB EDGE BEAMS SO AS TO PREVENT GENERAL MOISTURE PENETRATION, DAMPNES, WEAKENING & UNDERMINING OF ANY BUILDING AND ITS FOOTING SYSTEM.

LOCATION OF ALL EXISTING SERVICES TO BE CONFIRMED ON SITE PRIOR TO CONSTRUCTION.

ATTENTION OF OWNER

THE OWNERS ATTENTION IS DRAWN TO THE FACT THAT FOUNDATIONS AND ASSOCIATED DRAINAGE FOR ALL SITES REQUIRES CONTINUING MAINTENANCE TO ASSIST FOOTING PERFORMANCE. ADVICE FOR FOUNDATION MAINTENANCE IS CONTAINED IN THE CSIRO BUILDING TECHNOLOGY FILE 18 AND IT IS THE OWNERS RESPONSIBILITY TO MAINTAIN THE SITE IN ACCORDANCE WITH THIS DOCUMENT.

SOIL AND WATER MANAGEMENT NOTES:

DRAINAGE LINES ARE TO BE INSTALLED PRIOR TO THE PLACEMENT OF ROOF AND GUTTERING. ONCE DWELLING IS ROOFED, CONNECT IMMEDIATELY. APPLY TEMPORARY COVERING TO DISTURBED AREAS THAT WILL REMAIN EXPOSED FOR 14 DAYS OR MORE DURING CONSTRUCTION (EG. WATERPROOF BLANKET, VEGETATION OR MULCH)

PROTECT ANY NEARBY OR ON-SITE DRAINAGE PITS FROM SEDIMENT BY INSTALLING SEDIMENT TRAPS AROUND THEM. LIMIT ENTRY/EXIT TO ONE POINT AND STABILISE. INSTALL FACILITIES TO REMOVE DIRT/ MUD FROM VEHICLE WHEELS BEFORE THEY LEAVE THE SITE.

SITE TO BE VEGETATED AND PLANTED ACCORDING TO THE HOBART REGIONAL SOIL AND WATER MANAGEMENT CODE OF PRACTICE.

BUILDER AND SUBCONTRACTORS TO VERIFY ALL DIMENSIONS AND LEVELS PRIOR TO THE COMMENCEMENT OF ANY WORK. GIVE 24 HOURS MINIMUM NOTICE WHERE AMENDMENTS ARE REQUIRED TO DRAWINGS. THESE DRAWINGS ARE TO BE READ IN CONJUNCTION WITH DOCUMENTATION LISTED ON THE COVER PAGE. DO NOT SCALE DRAWINGS. DIMENSIONS ARE TO TAKE PREFERENCE OVER SCALE. BUILDING SPECIFICATION AND ENGINEERS DRAWINGS SHALL OVERRIDE ARCHITECTURAL DRAWINGS.

- THIS DRAWING IS TO BE READ IN CONJUNCTION WITH ALL OTHER DRAWING SHEETS, CONSULTANTS DRAWINGS, DOCUMENTS, SCHEDULES AND SPECIFICATIONS (AS APPLICABLE).
- THE BUILDER AND SUBCONTRACTOR SHALL ENSURE THAT ALL STORMWATER DRAINS, SEWER PIPES AND THE LIKE ARE LOCATED AT A SUFFICIENT DISTANCE FROM ANY BUILDINGS FOOTING AND/OR SLAB EDGE BEAMS SO AS TO PREVENT GENERAL MOISTURE PENETRATION, DAMPNES, WEAKENING & UNDERMINING OF ANY BUILDING AND ITS FOOTING SYSTEM.
- LOCATION OF ALL EXISTING ONSITE SERVICES TO BE CONFIRMED ONSITE PRIOR TO CONSTRUCTION

GPS DATA SCALE LOCATION

JOB CONTROL POINT
POINT NO: #1
DESCRIPTION: ANCH PIN IN PATH#
GPS SCALE FACTOR = 1.000399721
E:521794.155
N:5273692.815
RL:34.407
EPU = 0.04±

SOIL CLASSIFICATION: --

WIND CLASSIFICATION: --

SITE COVERAGE

SITE AREA	1540.2 m²
PROPOSED BUILDING FOOTPRINT	206.5 m²
PROPOSED SITE COVERAGE	13.41 %

PROPOSED SITE PLAN-GENERAL

PRELIMINARY

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CONTRACTOR MUST VERIFY ALL DIMENSIONS AND LEVELS AT THE JOB PRIOR TO COMMENCING ANY WORK OR MAKING ANY SHOP DRAWINGS.
DO NOT SCALE DRAWINGS. ALWAYS USE WRITTEN DIMENSIONS.

REV:	DESCRIPTION:	BY:	DATE:
SK	ISSUED FOR CLIENT REVIEW	NN	25/9/25
A	ISSUED FOR CLIENT REVIEW	NN	24/10/25
B	ADD EXISTING FENCE NOTE & ADJUST SHOWER	QT	21/11/25



CREATIVE HOMES
HOBART

CREATIVE HOMES HOBART, CNR OF ELWICK ROAD & BROOKER HIGHWAY, GLENORCHY 7010 PH: 03 6272 3000

JOB ADDRESS: 7A Ford Road Pontville	DESIGNER: I. Brown	ACCRED. NO.: CC6652	CLIENT: Gaileen Doyle
DRAWN:N. Nguyen	CHECKED:	DATE: September 2025	SHEET: 2 of 10
SCALE: 1:250	REV: B	DATE:	DESIGN TYPE: Custom
			DRAWING NO: ---


9. SURVEY BY ROBOTIC TOTAL STATION AND RTK GPS.

- 3D TIN
- MAJOR CONTOUR 3D
- MINOR CONTOUR 3D



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BY:	DATE:
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NN	24/10/25
QT	21/11/25

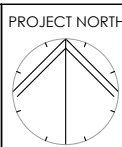

CREATIVE HOMES
— HOBART —

CREATIVE HOMES HOBART, CNR OF ELWICK ROAD & BROOKER HIGHWAY, GLENORCHY 7010 PH: 03 6272 3000

JOB ADDRESS:
7A Ford Road
Pontville

DESIGNER:	I. Brown
DRAWN:	N. Nguyen
CHECKED:	
SCALE:	1:200

ACCRED. NO.:	CC6652
DATE:	September 2025
DATE:	
REV:	B

CLIENT:
Gaileen Doyle

SHEET:	3 of 10
DESIGN TYPE:	Custom

DRAWING NO:

SOIL CLASSIFICATION:	--
WIND CLASSIFICATION:	--

SITE COVERAGE

SITE AREA	1540.2 m ²
PROPOSED BUILDING FOOTPRINT	206.5 m ²
PROPOSED SITE COVERAGE	13.41 %


IMPORTANT!
SITE INFORMATION AS DRAWN IS APPROXIMATE
ONLY. FINAL SITE INFORMATION IS SUBJECT TO A
DETAILED CONTOUR SURVEY BY LICENSED
SURVEYOR.

AREAS:	
FLOOR AREA:	146.7 m ²
PORCH:	14.6 m ²
GARAGE:	27.5 m ²
ALFRESCO:	17.6 m ²
TOTAL AREA: 206.5 m ²	

LEGEND:	
DP	DOWNPIPE LOCATION
SHR	SHOWER
WIS	WALK IN SHOWER
BTH	BATH
VB	VANITY BASIN
WC	TOILET
OHC	OVERHEAD CUPBOARDS
REF	REFRIGERATOR
P	PANTRY
RH	RANGE HOOD
UBO	UNDER BENCH OVEN
CT	COOK TOP
S	SINK
DW	DISH WASHER
T	TROUGH
WM	WASHING MACHINE
MH	MANHOLE
CSD	CAVITY SLIDING DOOR
AAW	ALUM. AWNING WINDOW
AFW	ALUM. FIXED WINDOW
ASD	ALUM. SLIDING DOOR
B/O	BEAM OVER
BAL	BALUSTRADE
BAL SELECTED BALUSTRADE TO BUILDER'S STANDARD DETAIL INSTALLED IN ACCORDANCE WITH NCC	
MASONRY ARTICULATION JOINT - LOCATION TO ENGINEER'S DETAILS	
CEILING MOUNTED INTERCONNECTED SMOKE DETECTORS, MAINS WIRED WITH BATTERY BACKUP, ALL IN ACCORDANCE WITH AS 3786.	
90mm DOWNPIPE	
NOTE: LIFT OFF HINGES TO WC TO BE INSTALLED AS REQUIRED IN ACCORDANCE WITH NCC.	

PROPOSED FLOOR PLAN

FLOOR AREA: 206.5m²

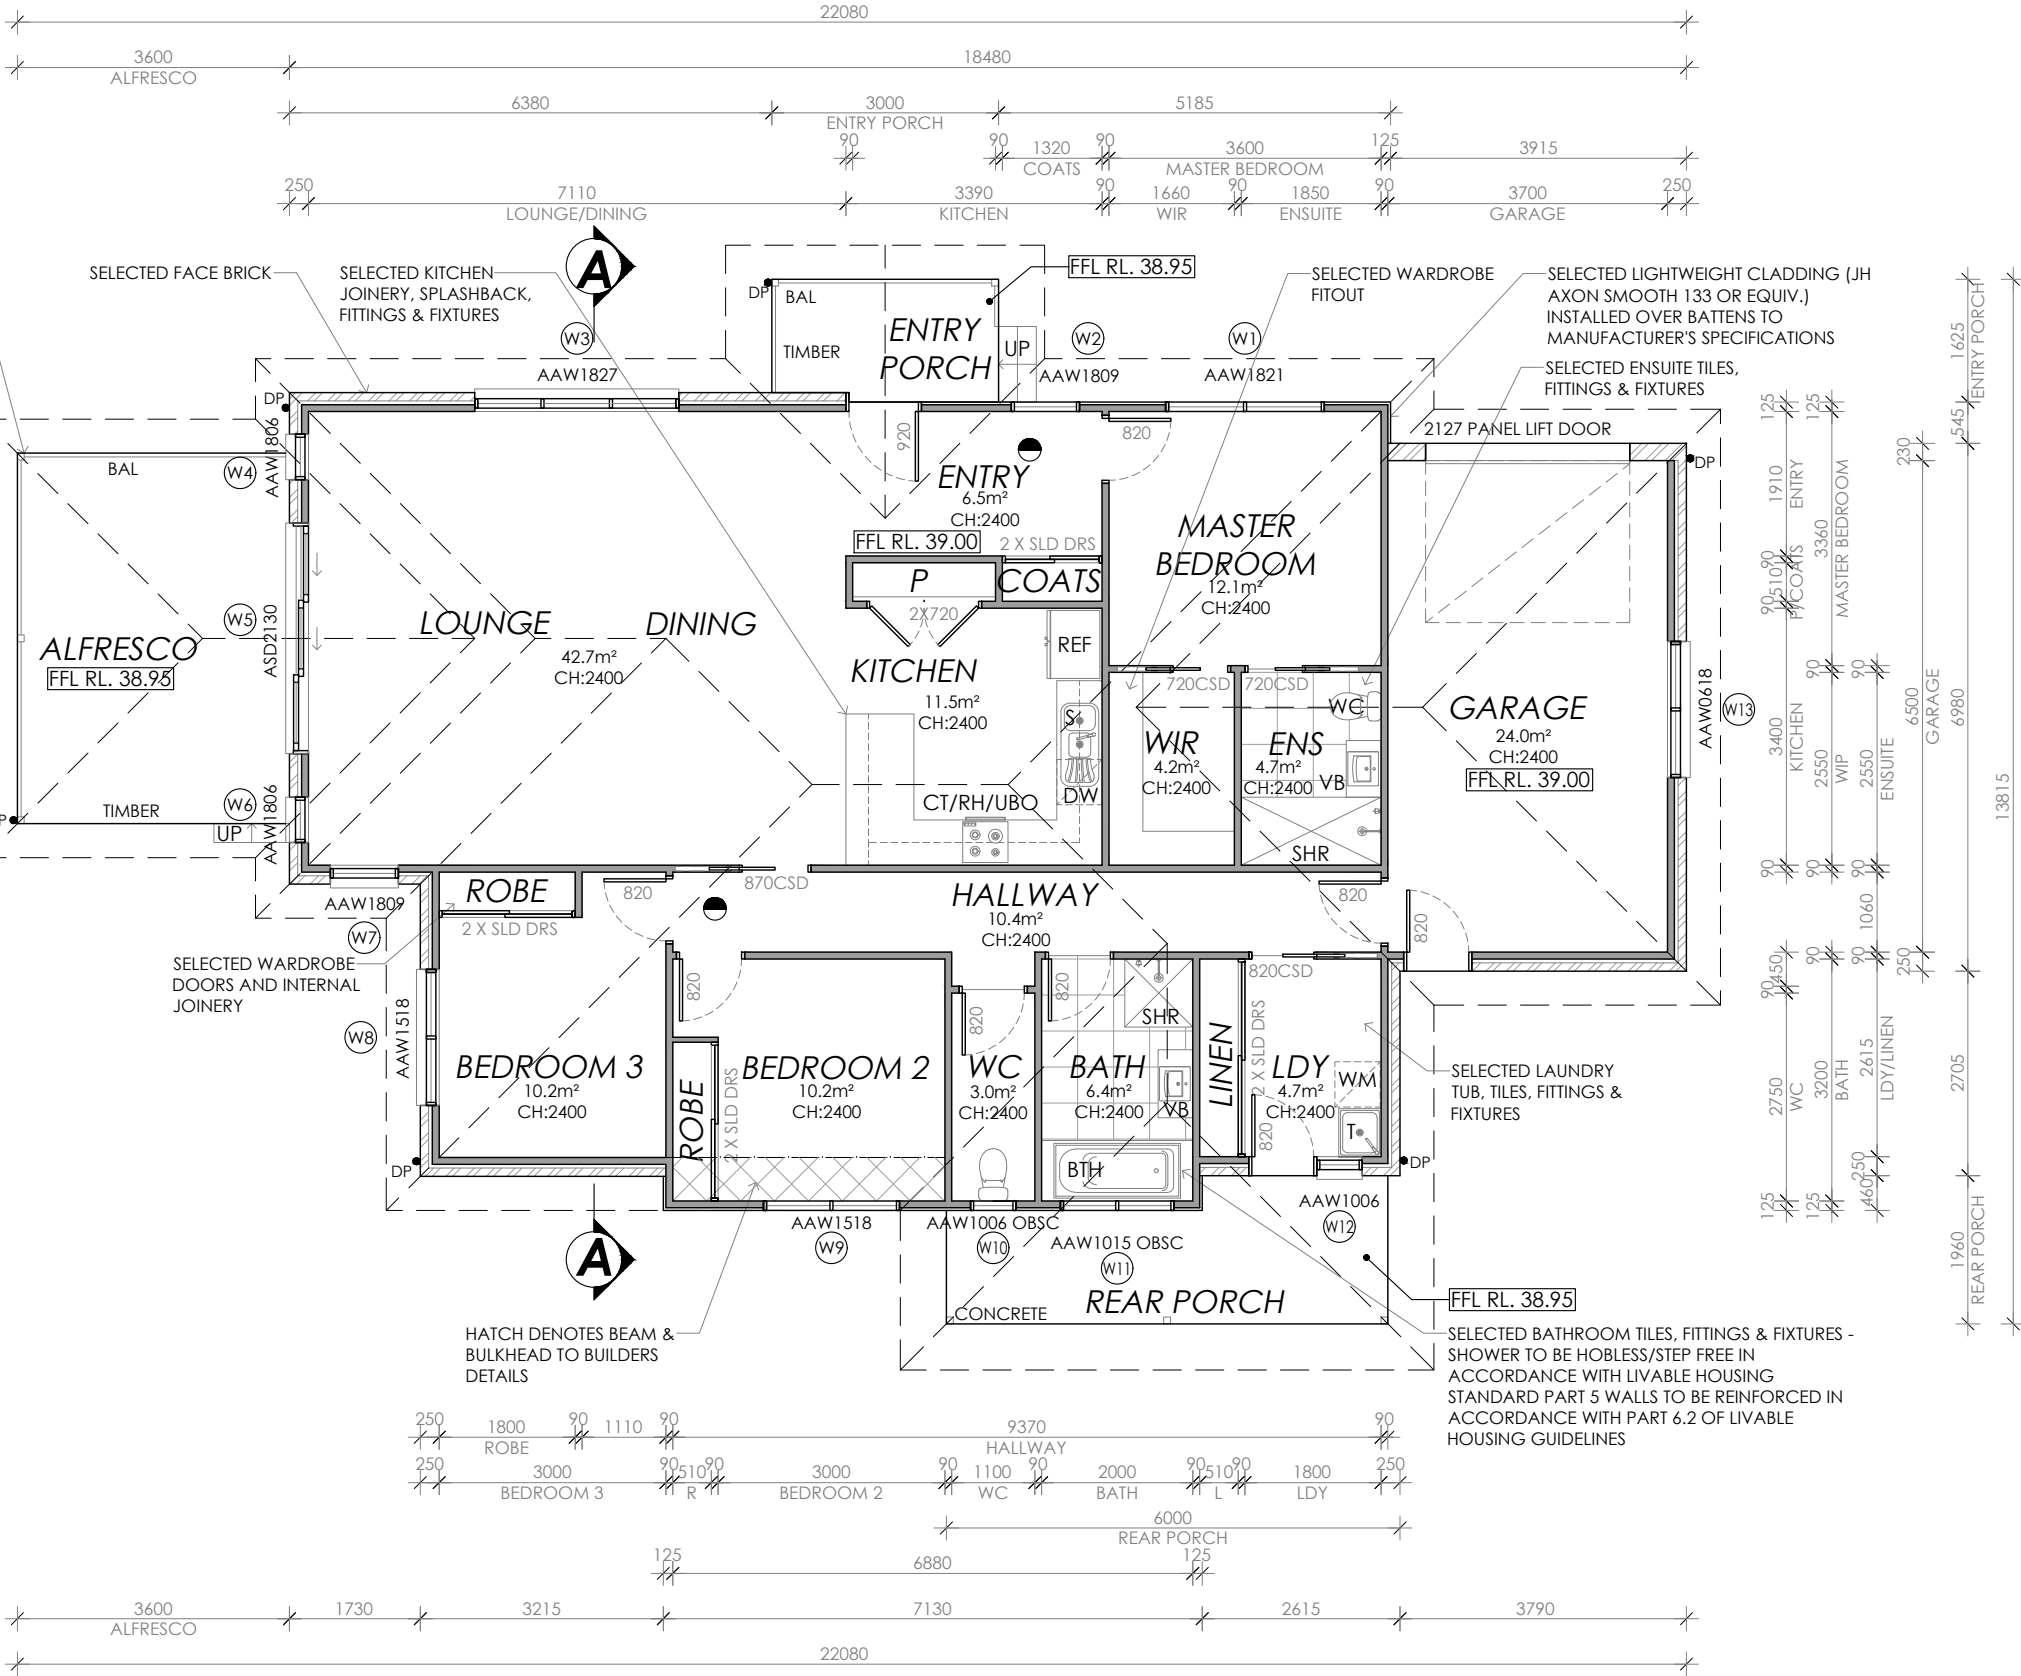

Framing NCC H1D6
All timber framing, fixing and bracing shall comply with AS 1684 and the requirements of NCC H1D6. Manufactured sizes must not be undersized to those specified, for all timber sizes, stress grades, spacing and wall bracing refer to Engineer's details. Tie-down details shall be in accordance with Engineer's details and comply with NCC H1D6 (4). Structural steel members shall comply with the requirements of clauses in NCC H1D6 (3). Refer to Engineer's details where provided.

Glazing NCC H1D8
All windows to be aluminium awning style, double glazed (obscured safety glass to bathrooms as shown on drawings) All glazing shall comply with the requirements of AS 2047 & AS 1288 and NCC H1D8.

Human impact safety requirements shall comply with NCC H1D8 (3) and Part 8.4 of the ABCB Housing provisions.

Note:
Builder and subcontractors to verify all dimension and levels prior to the commencement of any work. Give 24hrs minimum notice where amendments are required to design of working drawings. These drawings are to be read in conjunction with Engineer's and Surveyor's drawings and notes. Do not scale drawings. Dimensions are to take preference over scale. Building specification and Engineer's drawings shall override architectural drawings. All construction work shall be carried out in accordance with the state building regulations, local council by-laws and relevant NCC and AS codes.

Important notice for attention of Owners:
the Owners attention is drawn to the fact that foundations and associated drainage in all sites requires continuing maintenance to assist footing performance. Advice for foundation maintenance is contained in the CSIRO building technology file 18 and it is the Owners responsibility to maintain the site in accordance with this document.

Energy efficiency:
Insulation must comply with AS/NZS4859.1 and be installed in accordance with ABCB housing provisions Part 13.2.2 and comply with minimum R values for climate zone 7.
Bulk insulation between external studs to be insulated with min R2.0. (Ensure batts fit within cavity without compression making sure that there is at least 25mm gap from the reflective surface). External walls are to be clad with vapour permeable reflective foil over the outside of the timber frame. Ceiling to be insulated with R4.0 and vapour permeable sarking. Floor to be insulated with Min R1.7 batts where applicable. Seal exhaust fans to Ensuite, Bathroom, Laundry and Kitchen. All downlights to be IC rated. Construction of the external walls, floor and roof for compliance with building sealing requirements shall comply with BCA 2019 Part 3.12

General:
All flashings, weep holes and damp proof coursing to be in accordance with NCC Housing provisions Part 5.7. Fibre cement sheet in accordance with NCC Housing provisions Part 7.5. Block construction in accordance NCC Housing provisions Part 5. Plasterboard linings to internal walls and ceilings with selected cornice. (see below for wet areas)

Wet areas: All wet areas shall comply with the requirements of ABCB Housing provisions Part 10.2. Provide waterproof plasterboard sheeting to all walls and ceilings. Provide ceramic tiles or other approved water resistant lining in accordance with Part 10.2.9 to a minimum height of 1800mm to shower walls and to a height of min 150mm behind baths, basins, sinks, troughs, washing machines and wall fixtures.

For construction of floor wastes refer to NCC ABCB Housing provisions part 10.2.12. For typical installation requirements for substrate preparation, penetrations, flashings/ junctions, membranes, screeds, hobs, baths, showers, door jambs and screens refer to ABCB Housing provisions part 10.2.14-32.

PRELIMINARY

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CREATIVE HOMES
HOBART

CREATIVE HOMES HOBART, CNR OF ELWICK ROAD & BROOKER HIGHWAY, GLENORCHY 7010 PH: 03 6272 3000

JOB ADDRESS: 7A Ford Road Pontville		CLIENT: Gaileen Doyle
DESIGNER: I. Brown	ACCRED. NO.: CC6652	SHEET: 4 of 10
DRAWN: N. Nguyen	DATE: September 2025	DESIGN TYPE: Custom
CHECKED:	DATE:	DRAWING NO: ---
SCALE: 1:100	REV: B	

Framing NCC H1D6
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Glazing NCC H1D8
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Human impact safety requirements shall comply with NCC H1D8 (3) and Part 8.4 of the ABCB Housing provisions.

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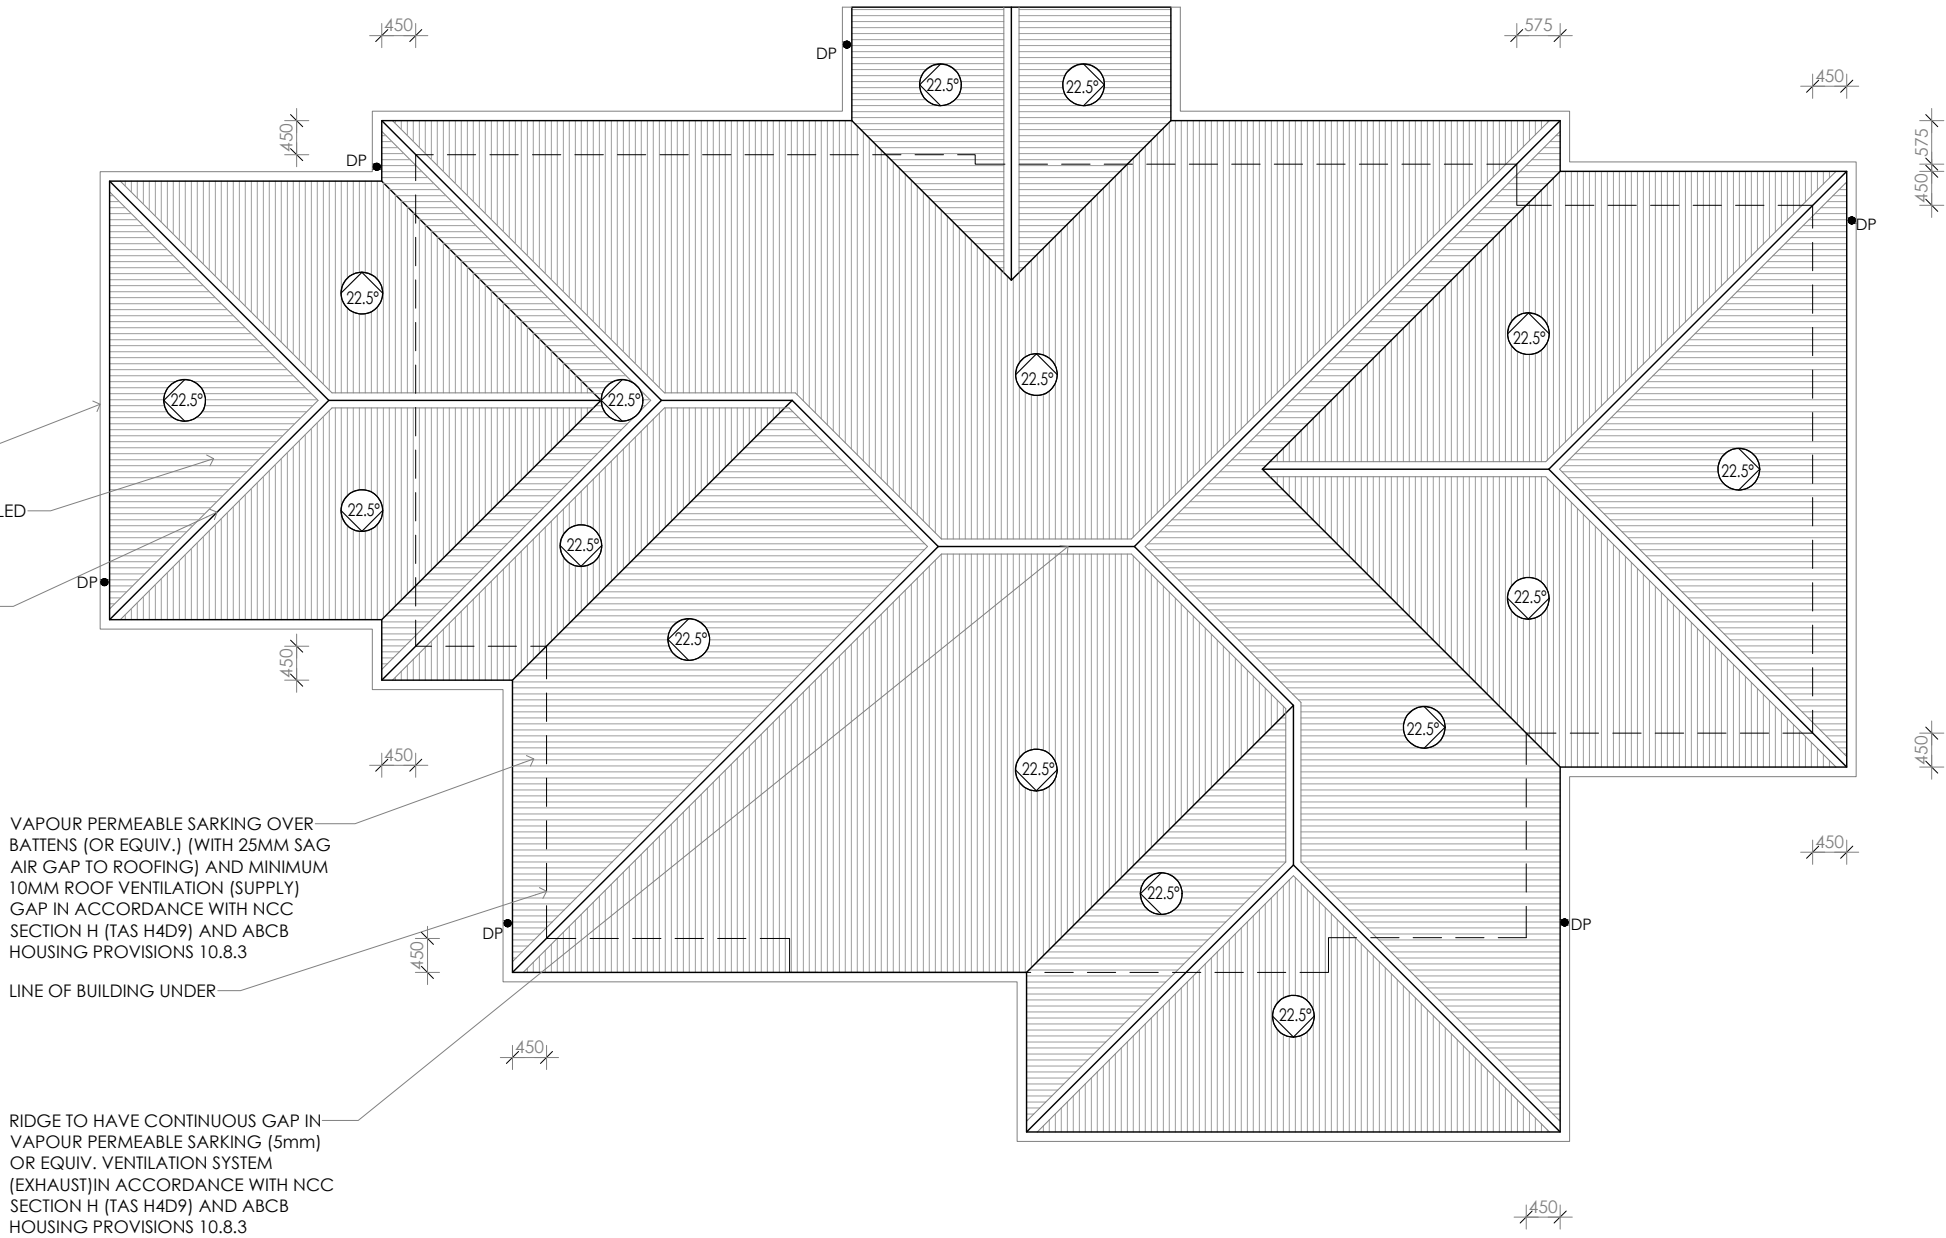
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Wet areas: All wet areas shall comply with the requirements of ABCB Housing provisions Part 10.2. Provide waterproof plasterboard sheeting to all walls and ceilings. Provide ceramic tiles or other approved water resistant lining in accordance with Part 10.2.9 to a minimum height of 1800mm to shower walls and to a height of min 150mm behind baths, basins, sinks, troughs, washing machines and wall fixtures.

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● DP 90mm DOWNPIPE



PROPOSED ROOF PLAN

PRELIMINARY


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05		CONTRACTOR MUST VERIFY ALL DIMENSIONS AND LEVELS AT THE JOB PRIOR TO COMMENCING ANY WORK OR MAKING ANY SHOP DRAWINGS. DO NOT SCALE DRAWINGS. ALWAYS USE WRITTEN DIMENSIONS.	REV:	DESCRIPTION:	BY:	DATE:
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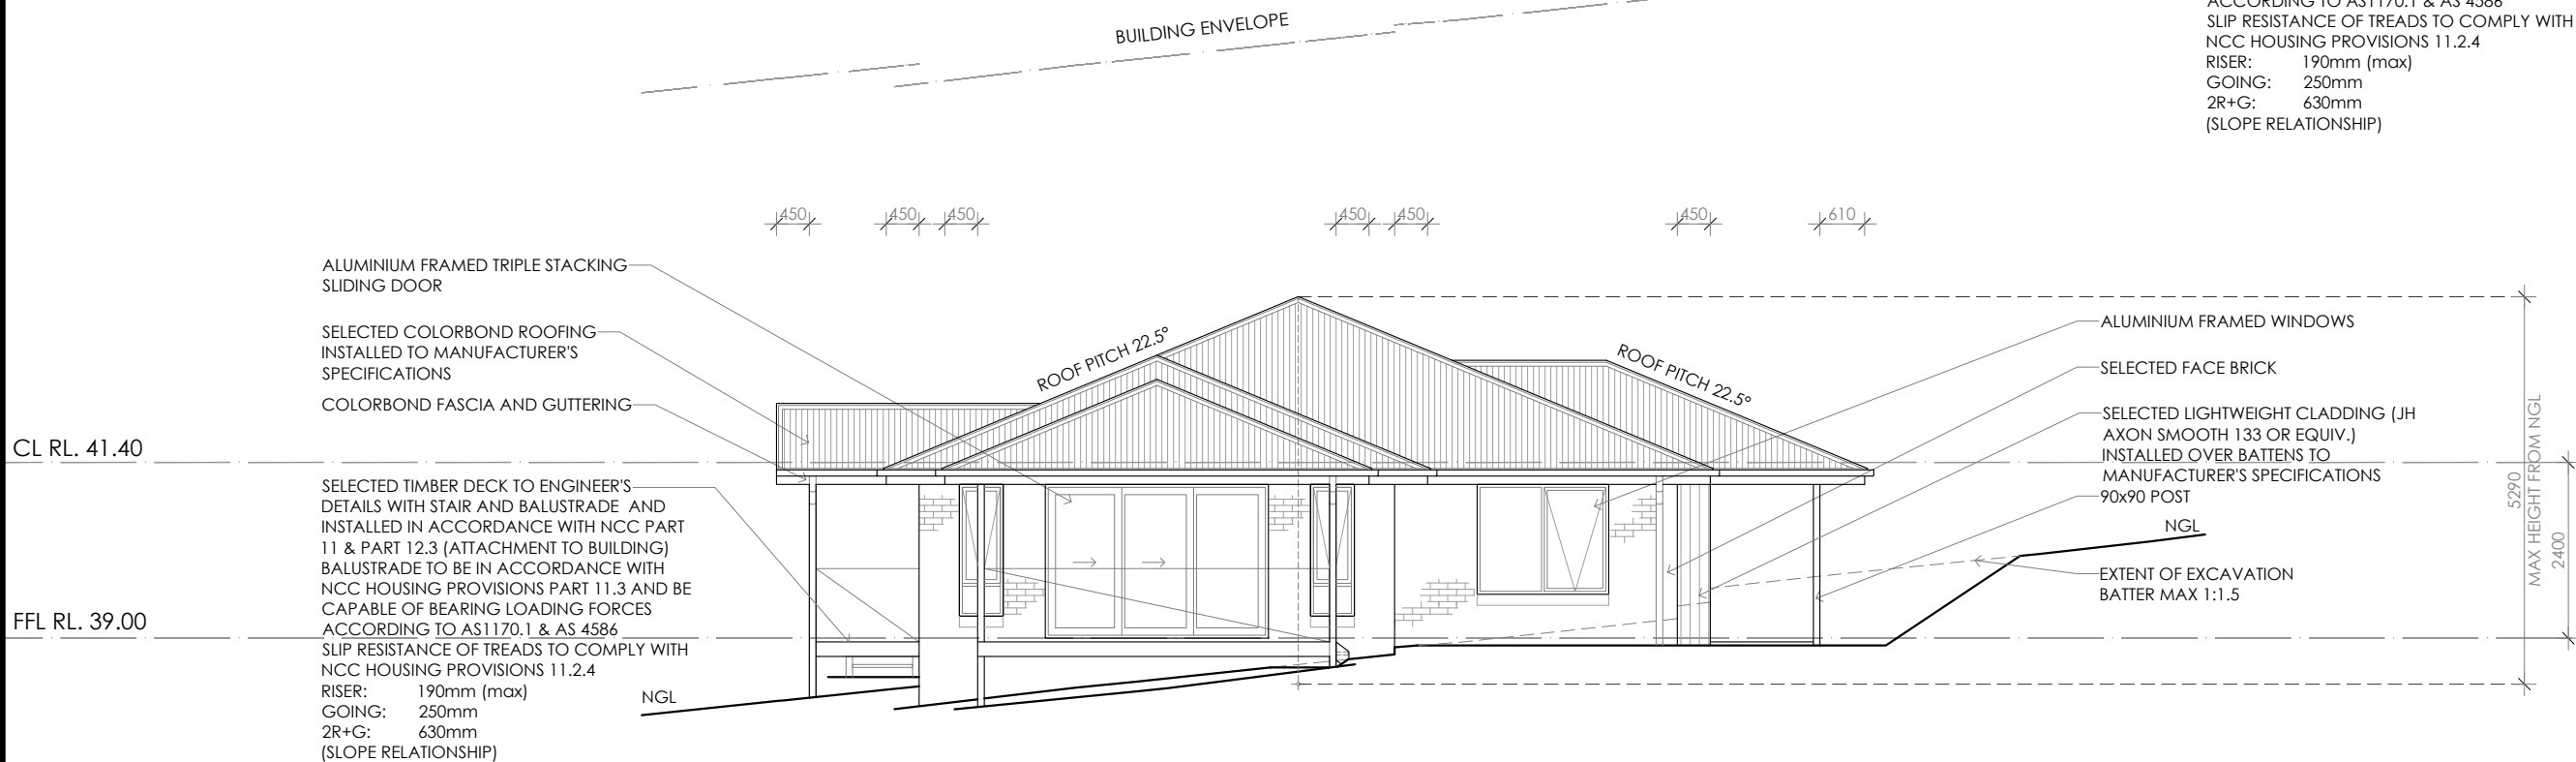
CREATIVE HOMES
HOBART

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NORTH EASTERN ELEVATION



NORTH WESTERN ELEVATION

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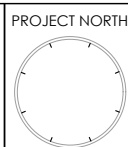
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PRELIMINARY
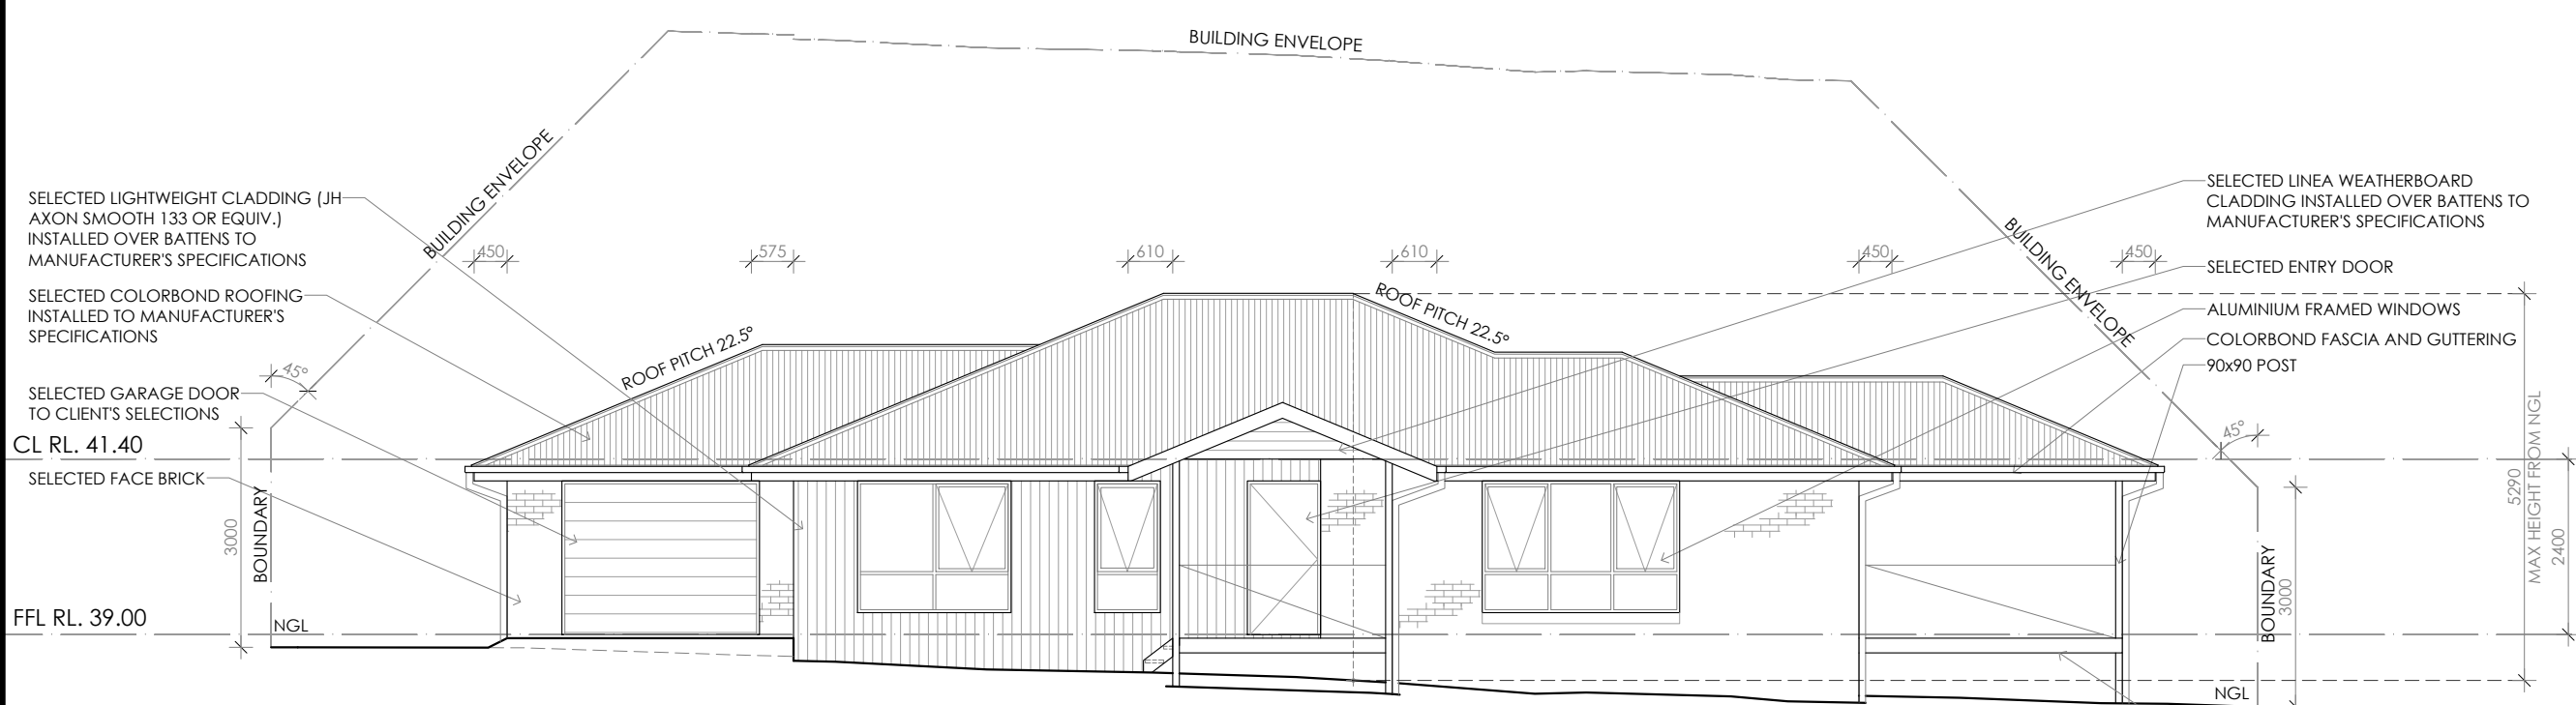
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PROJECT NORTH
CONTRACTOR MUST VERIFY ALL DIMENSIONS AND LEVELS AT THE JOB PRIOR TO COMMENCING ANY WORK OR MAKING ANY SHOP DRAWINGS.
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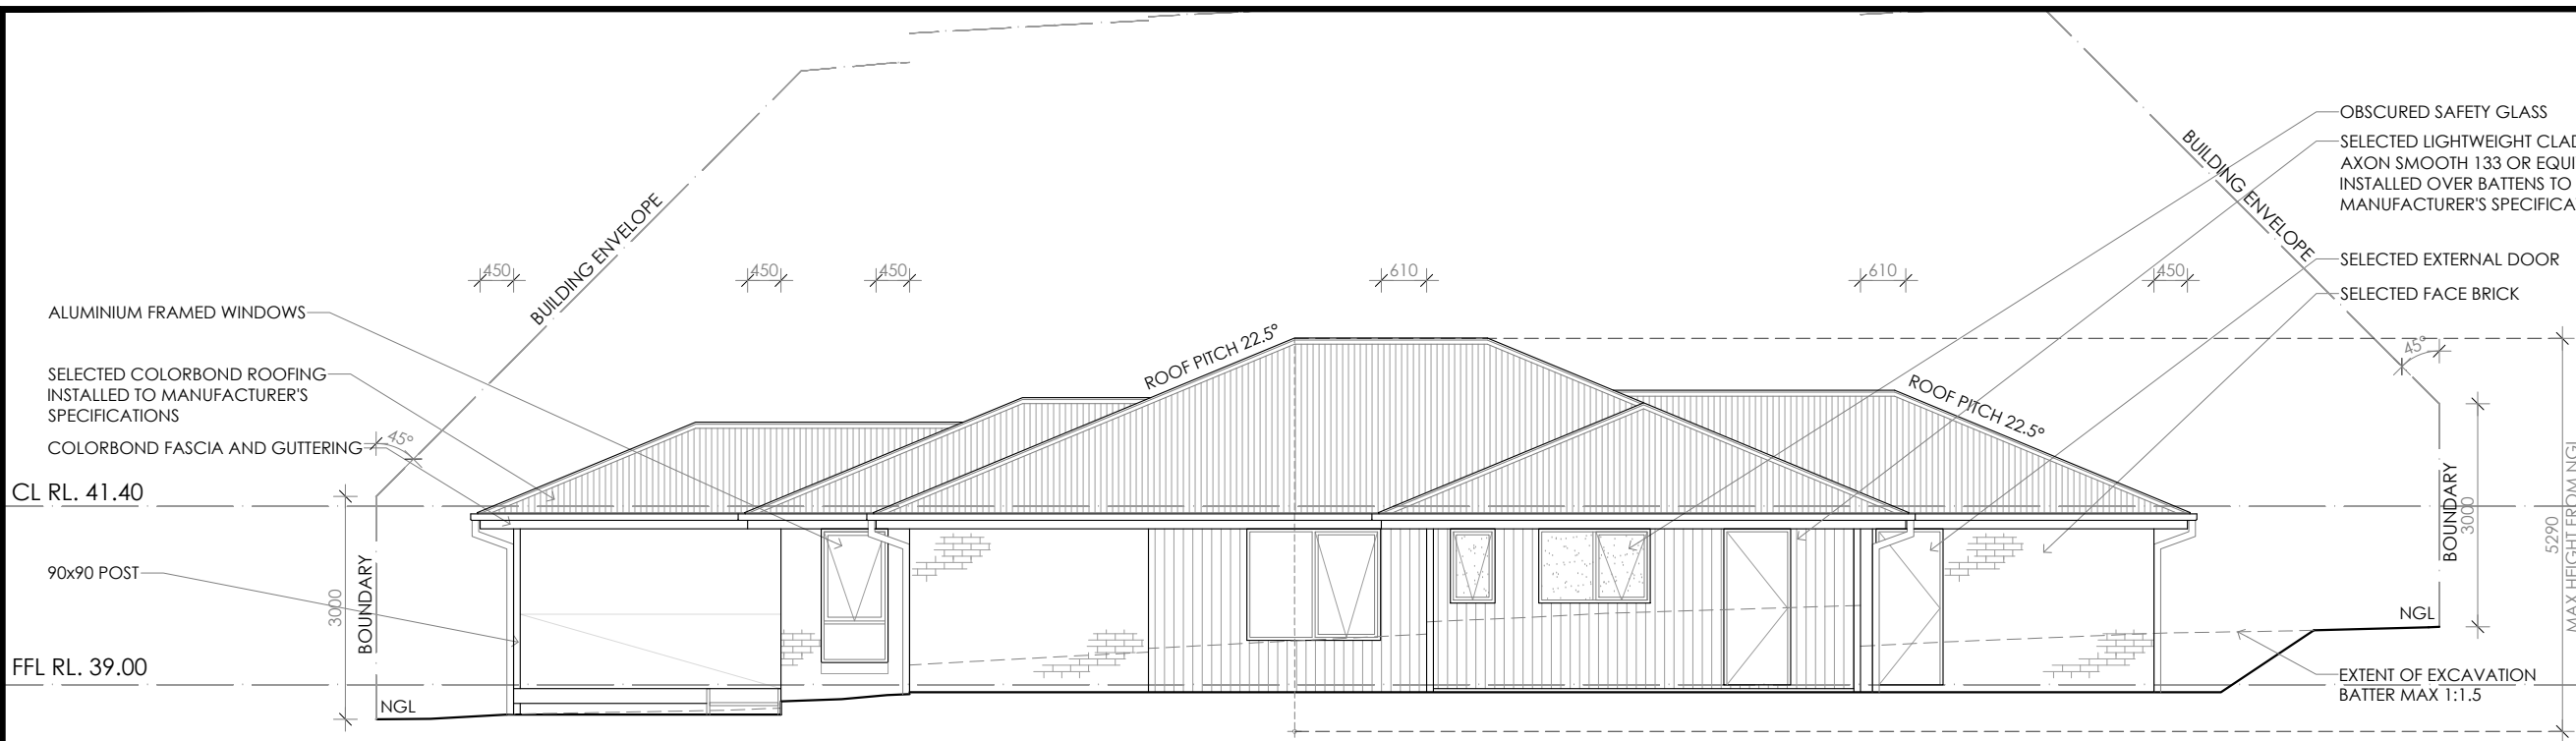
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B	ADD EXISTING FENCE NOTE & ADJUST SHOWER	QT	21/11/25




CREATIVE HOMES
HOBART

CREATIVE HOMES HOBART, CNR OF ELWICK ROAD & BROOKER HIGHWAY, GLENORCHY 7010 PH: 03 6272 3000

JOB ADDRESS: 7A Ford Road Pontville		CLIENT: Gaileen Doyle	
DESIGNER: I. Brown	ACCRED. NO.: CC6652	SHEET: 6 of 10	
DRAWN: N. Nguyen	DATE: September 2025	DESIGN TYPE: Custom	
CHECKED:	DATE:	DRAWING NO:	
SCALE: 1:100	REV: B	---	



SOUTH WESTERN ELEVATION

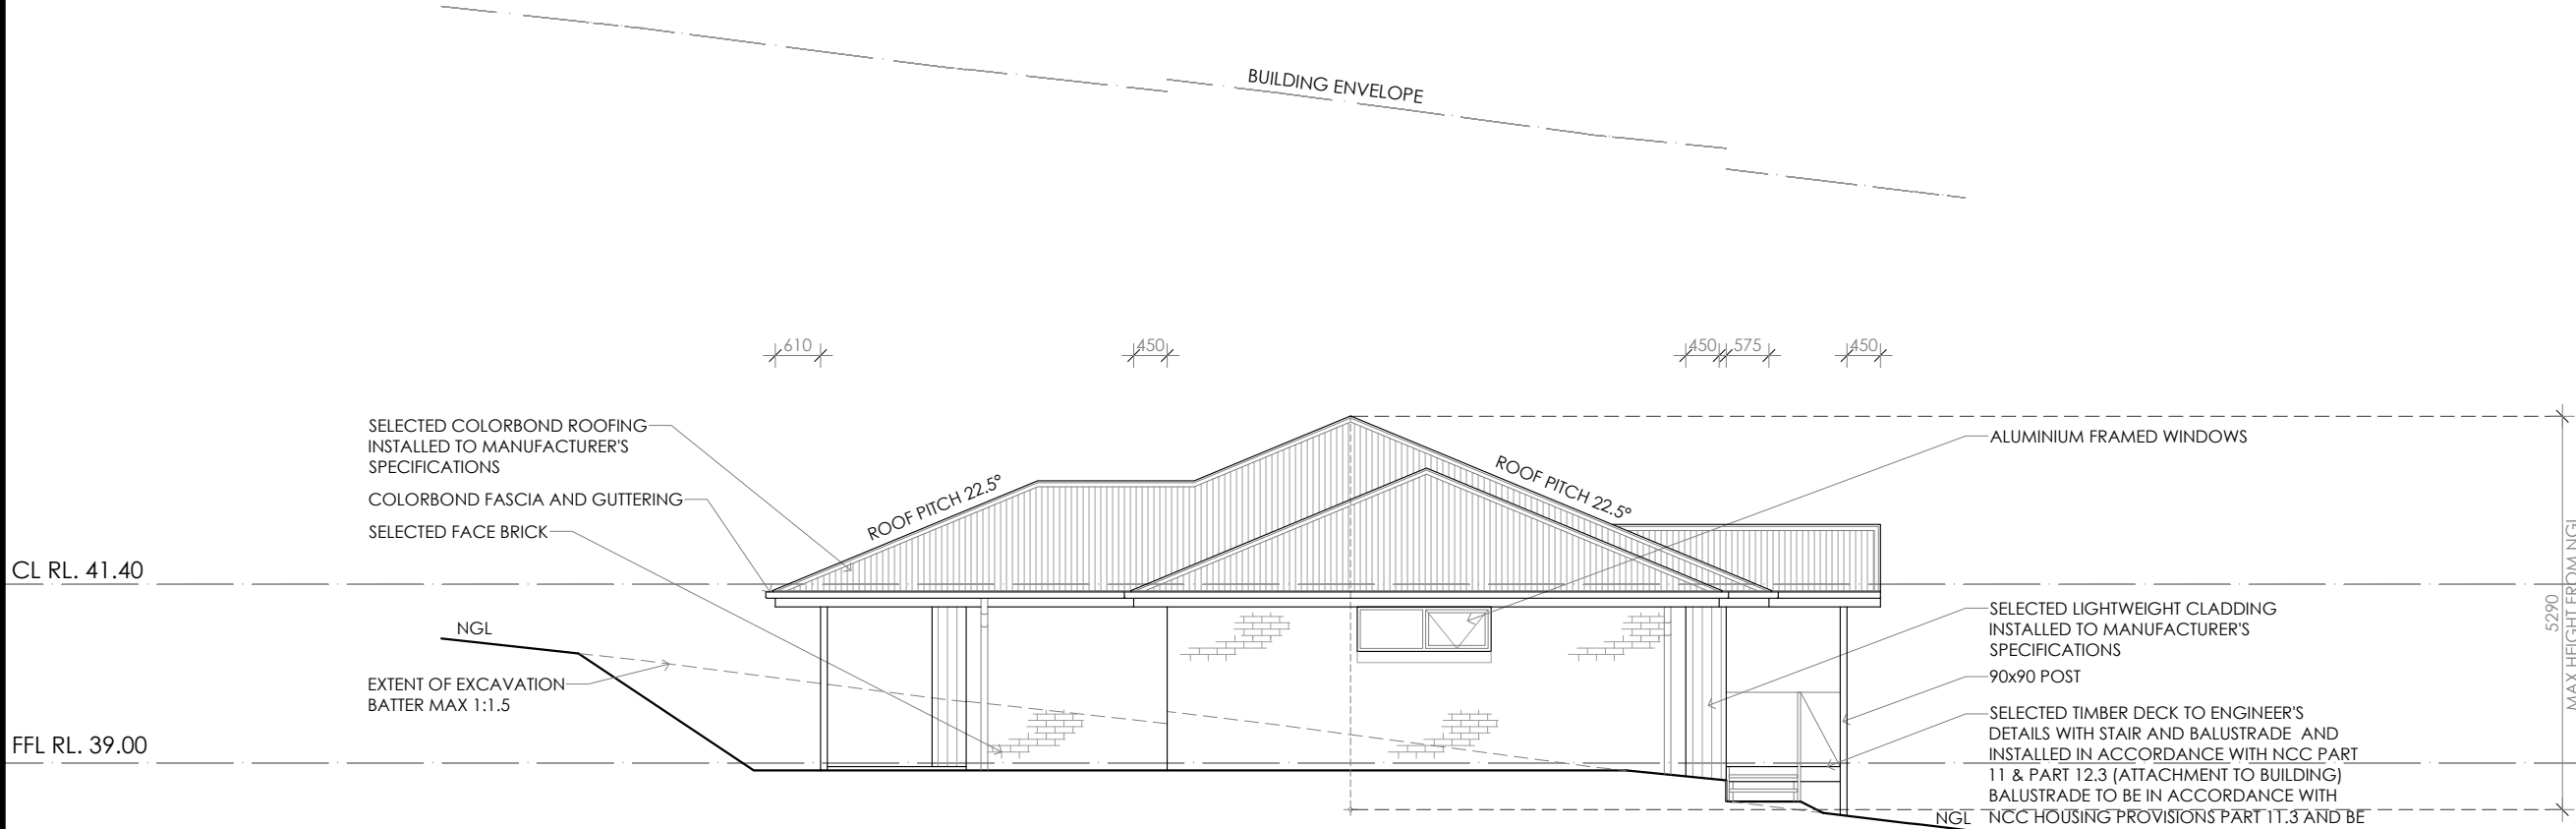

SOUTH EASTERN ELEVATION

Framing NCC H1D6
All timber framing, fixing and bracing shall comply with AS 1684 and the requirements of NCC H1D6. Manufactured sizes must not be undersized to those specified, for all timber sizes, stress grades, spacing and wall bracing refer to Engineer's details. Tie-down details shall be in accordance with Engineer's details and comply with NCC H1D6 (4). Structural steel members shall comply with the requirements of clauses in NCC H1D6 (3). Refer to Engineer's details where provided.

Glazing NCC H1D8
All windows to be aluminium awning style, double glazed (obscured safety glass to bathrooms as shown on drawings) All glazing shall comply with the requirements of AS 2047 & AS 1288 and NCC H1D8.

Human impact safety requirements shall comply with NCC H1D8 (3) and Part 8.4 of the ABCB Housing provisions.

Note:
Builder and subcontractors to verify all dimension and levels prior to the commencement of any work. Give 24hrs minimum notice where amendments are required to design of working drawings. These drawings are to be read in conjunction with Engineer's and Surveyor's drawings and notes. Do not scale drawings. Dimensions are to take preference over scale. Building specification and Engineer's drawings shall override architectural drawings. All construction work shall be carried out in accordance with the state building regulations, local council by-laws and relevant NCC and AS codes.

Important notice for attention of Owners:
The Owners attention is drawn to the fact that foundations and associated drainage in all sites requires continuing maintenance to assist footing performance. Advice for foundation maintenance is contained in the CSIRO building technology file 18 and it is the Owners responsibility to maintain the site in accordance with this document.

Energy efficiency:
Insulation must comply with AS/NZS4859.1 and be installed in accordance with ABCB housing provisions Part 13.2.2 and comply with minimum R values for climate zone 7.
Bulk insulation between external studs to be insulated with min R2.0. (Ensure batts fit within cavity without compression, making sure that there is at least 25mm gap from the reflective surface). External walls are to be clad with vapour permeable reflective foil over the outside of the timber frame. Ceiling to be insulated with R4.0 and vapour permeable sarking. Floor to be insulated with Min R1.7 batts where applicable. Seal exhaust fans to Ensuite, Bathroom, Laundry and Kitchen. All downlights to be IC rated. Construction of the external walls, floor and roof for compliance with building sealing requirements shall comply with BCA 2019 Part 3.12


General:
All flashings, weep holes and damp proof coursing to be in accordance with NCC Housing provisions Part 5.7. Fibre cement sheet in accordance with NCC Housing provisions Part 7.5. Block construction in accordance NCC Housing provisions Part 5. Plasterboard linings to internal walls and ceilings with selected cornice. (see below for wet areas)


Wet areas: All wet areas shall comply with the requirements of ABCB Housing provisions Part 10.2. Provide waterproof plasterboard sheeting to all walls and ceilings. Provide ceramic tiles or other approved water resistant lining in accordance with Part 10.2.9 to a minimum height of 1800mm to shower walls and to a height of min 150mm behind baths, basins, sinks, troughs, washing machines and wall fixtures.

For construction of floor wastes refer to NCC ABCB Housing provisions part 10.2.12. For typical installation requirements for substrate preparation, penetrations, flashings/ junctions, membranes, screeds, hobs, baths, showers, door jambs and screens refer to ABCB Housing provisions part 10.2.14-32.

PRELIMINARY

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07		CONTRACTOR MUST VERIFY ALL DIMENSIONS AND LEVELS AT THE JOB PRIOR TO COMMENCING ANY WORK OR MAKING ANY SHOP DRAWINGS. DO NOT SCALE DRAWINGS. ALWAYS USE WRITTEN DIMENSIONS.	REV:	DESCRIPTION:	BY:	DATE:
			SK	ISSUED FOR CLIENT REVIEW	NN	25/9/25
			A	ISSUED FOR CLIENT REVIEW	NN	24/10/25
			B	ADD EXISTING FENCE NOTE & ADJUST SHOWER	QT	21/11/25



CREATIVE HOMES
HOBART

CREATIVE HOMES HOBART, CNR OF ELWICK ROAD & BROOKER HIGHWAY, GLENORCHY 7010 PH: 03 6272 3000

JOB ADDRESS: 7A Ford Road Pontville		CLIENT: Gaileen Doyle	
DESIGNER: I. Brown	ACCRED. NO.: CC6652	SHEET: 7 of 10	
DRAWN: N. Nguyen	DATE: September 2025	DESIGN TYPE: Custom	
CHECKED:	DATE:	DRAWING NO: ---	
SCALE: 1:100	REV: B		

Framing NCC H1D6
All timber framing, fixing and bracing shall comply with AS 1684 and the requirements of NCC H1D6. Manufactured sizes must not be undersized to those specified, for all timber sizes, stress grades, spacing and wall bracing refer to Engineer's details. Tie-down details shall be in accordance with Engineer's details and comply with NCC H1D6 (4). Structural steel members shall comply with the requirements of clauses in NCC H1D6 (3). Refer to Engineer's details where provided.

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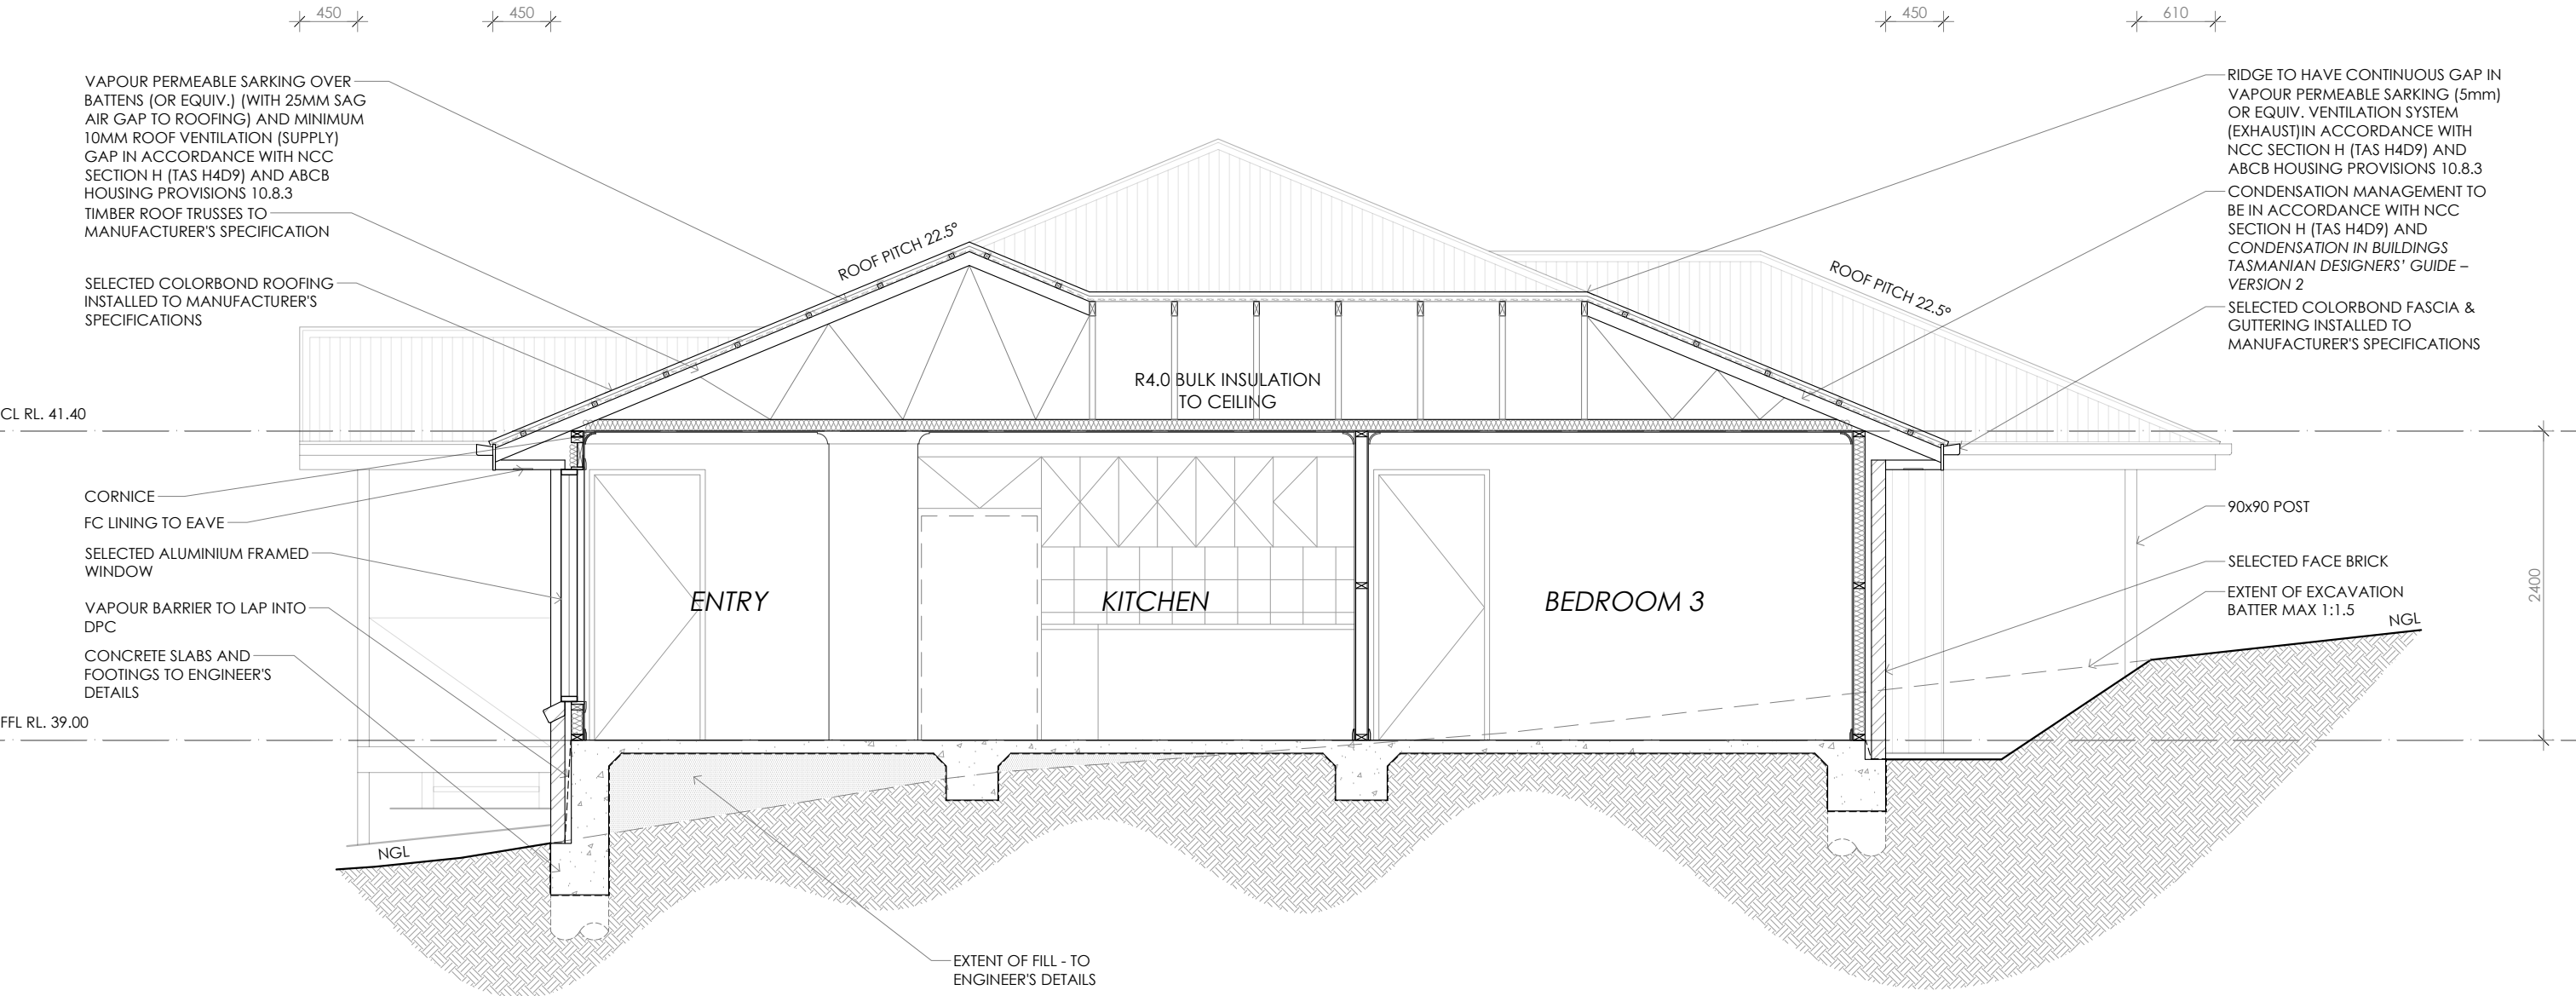
Energy efficiency:
Insulation must comply with AS/NZS4859.1 and be installed in accordance with ABCB housing provisions Part 13.2.2 and comply with minimum R values for climate zone 7.
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vapour permeable sarking. Floor to be insulated with Min R1.7 batts where applicable. Seal exhaust fans to Ensuite, Bathroom, Laundry and Kitchen. All downlights to be IC rated. Construction of the external walls, floor and roof for compliance with building sealing requirements shall comply with BCA 2019 Part 3.12

General:
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SECTION A-A

PRELIMINARY

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08



CONTRACTOR MUST VERIFY ALL DIMENSIONS AND LEVELS AT THE JOB PRIOR TO COMMENCING ANY WORK OR MAKING ANY SHOP DRAWINGS.


DO NOT SCALE DRAWINGS. ALWAYS USE WRITTEN DIMENSIONS.

REV:	DESCRIPTION:	BY:	DATE:
SK	ISSUED FOR CLIENT REVIEW	NN	25/9/25
A	ISSUED FOR CLIENT REVIEW	NN	24/10/25
B	ADD EXISTING FENCE NOTE & ADJUST SHOWER	QT	21/11/25




CREATIVE HOMES HOBART, CNR OF ELWICK ROAD & BROOKER HIGHWAY, GLENORCHY 7010 PH: 03 6272 3000


JOB ADDRESS: 7A Ford Road Pontville		CLIENT: Gaileen Doyle
DESIGNER: I. Brown	ACCRED. NO.: CC6652	SHEET: 8 of 10
DRAWN: N. Nguyen	DATE: September 2025	DESIGN TYPE: Custom
CHECKED:	DATE:	DRAWING NO: ---
SCALE: 1:50	REV: B	

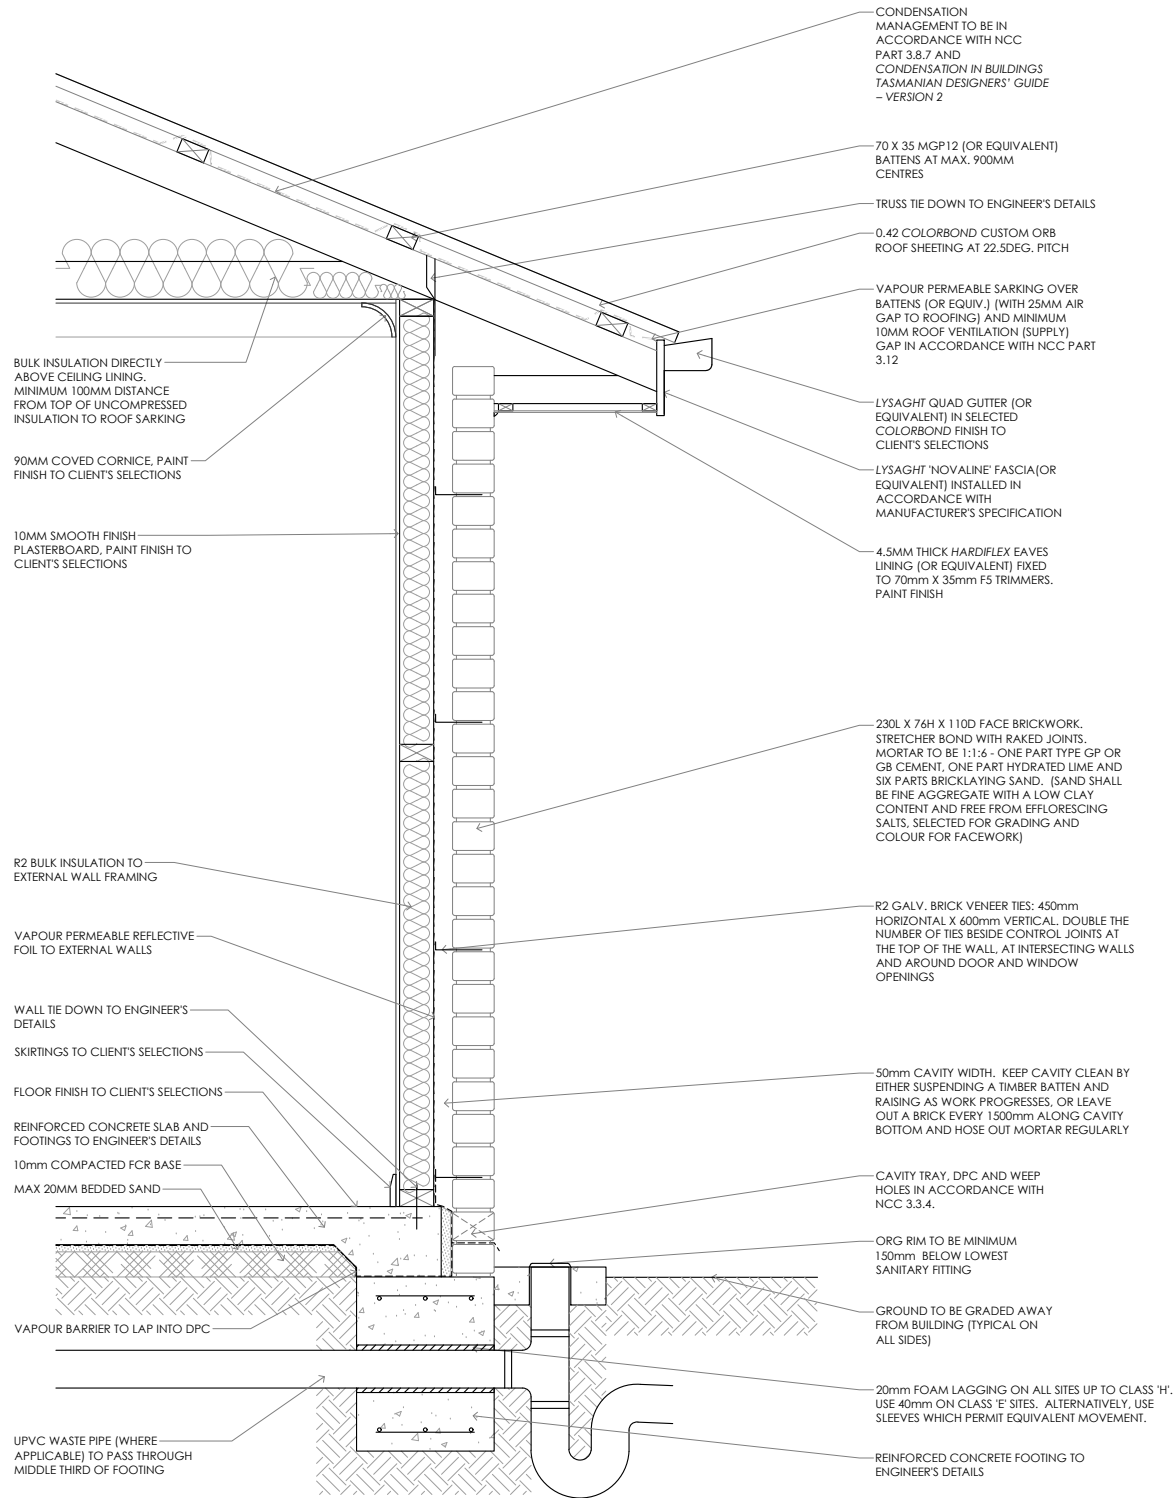

FLOOR, WALL & ROOF DETAIL SCALE 1:20

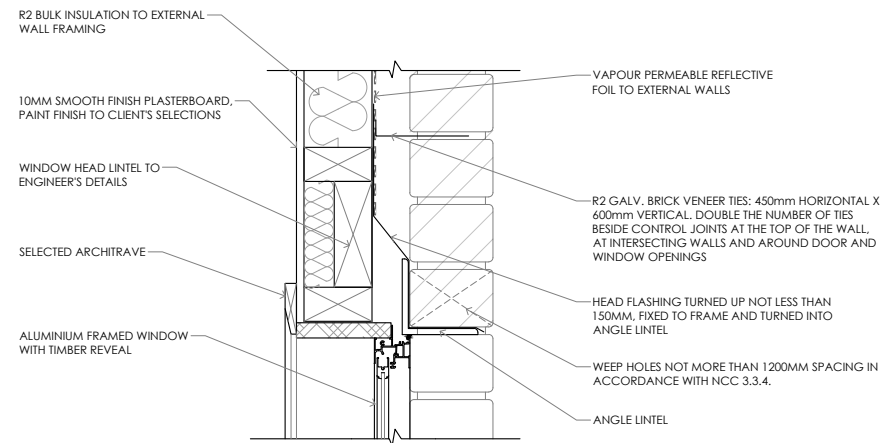

WINDOW HEAD DETAIL SCALE 1:10

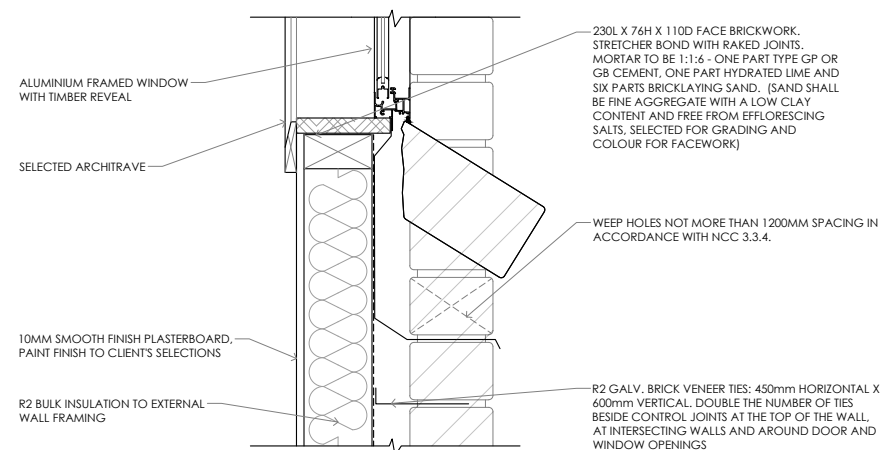


WINDOW SILL DETAIL SCALE 1:10

TYPICAL SECTION DETAILS

PRELIMINARY

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09		CONTRACTOR MUST VERIFY ALL DIMENSIONS AND LEVELS AT THE JOB PRIOR TO COMMENCING ANY WORK OR MAKING ANY SHOP DRAWINGS. DO NOT SCALE DRAWINGS. ALWAYS USE WRITTEN DIMENSIONS.	REV:	DESCRIPTION:	BY:	DATE:
			SK	ISSUED FOR CLIENT REVIEW	NN	25/9/25
			A	ISSUED FOR CLIENT REVIEW	NN	24/10/25
			B	ADD EXISTING FENCE NOTE & ADJUST SHOWER	QT	21/11/25

 CREATIVE HOMES HOBART <small>CREATIVE HOMES HOBART, CNR OF ELWICK ROAD & BROOKER HIGHWAY, GLENORCHY 7010 PH: 03 6272 3000</small>		JOB ADDRESS: 7A Ford Road Pontville		CLIENT: Gaileen Doyle	
		DESIGNER: I. Brown	ACCRED. NO.: CC6652	SHEET: 9 of 10	
		DRAWN: N. Nguyen	DATE: September 2025	DESIGN TYPE: Custom	
		CHECKED:	DATE:	DRAWING NO:	
		SCALE: AS SHOWN	REV: B	---	



Framing NCC H1D6
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
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WINDOW SCHEDULE

fg FIXED GLAZING

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10		CONTRACTOR MUST VERIFY ALL DIMENSIONS AND LEVELS AT THE JOB PRIOR TO COMMENCING ANY WORK OR MAKING ANY SHOP DRAWINGS. DO NOT SCALE DRAWINGS. ALWAYS USE WRITTEN DIMENSIONS.	REV:	DESCRIPTION:			BY:	DATE:		
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CREATIVE HOMES
HOBART

CREATIVE HOMES HOBART, CNR OF ELWICK ROAD & BROOKER HIGHWAY, GLENORCHY 7010 PH: 03 6272 3000

JOB ADDRESS: 7A Ford Road Pontville		CLIENT: Gaileen Doyle	
DESIGNER: I. Brown	ACCRED. NO.: CC6652	SHEET: 10 of 10	
DRAWN: N. Nguyen	DATE: September 2025	DESIGN TYPE: Custom	
CHECKED:	DATE:	DRAWING NO:	
SCALE: 1:50	REV: B	---	