

Land Use Planning and Approvals Act 1993

APPLICATION NO.

DA2025/192

LOCATION OF AFFECTED AREA

45A GLEN LEA ROAD, PONTVILLE

DESCRIPTION OF DEVELOPMENT PROPOSAL

SINGLE DWELLING

A COPY OF THE DEVELOPMENT APPLICATION MAY BE VIEWED AT www.brighton.tas.gov.au AND AT THE COUNCIL OFFICES, 1 TIVOLI ROAD, OLD BEACH, BETWEEN 8:15 A.M. AND 4:45 P.M, MONDAY TO FRIDAY OR VIA THE QR CODE BELOW. ANY PERSON MAY MAKE WRITTEN REPRESENTATIONS IN ACCORDANCE WITH S.57(5) OF THE LAND USE PLANNING AND APPROVALS ACT 1993 CONCERNING THIS APPLICATION UNTIL 4:45 P.M. ON 26/11/2025. ADDRESSED TO THE CHIEF EXECUTIVE OFFICER AT 1 TIVOLI ROAD, OLD BEACH, 7017 OR BY EMAIL

AT

development@brighton.tas.gov.au.

REPRESENTATIONS SHOULD INCLUDE A DAYTIME TELEPHONE NUMBER TO ALLOW COUNCIL OFFICERS TO DISCUSS, IF NECESSARY, ANY MATTERS RAISED.

JAMES DRYBURGH
Chief Executive Officer





MAIN DWELLING, GROUND FLOOR 135.31 PORCH 1.85 137.16 m²

TOTAL FLOOR AREAS

ON SITE WASTEWATER TREATMENT REQUIRED. REFER TO REPORT PREPARED BY GES (TBC)

ON SITE STORMWATER MANAGEMENT. REFER TO REPORT PREPARED BY **GES/FLUSSIG (TBC)**

AS & NCC COMPLIANCE


ALL CONSTRUCTION TO BE IN ACCORDANCE WITH NCC 2022 AND APPLICABLE AUSTRALIAN STANDARDS AT TIME OF APPROVAL

- SLAB IN ACCORDANCE WITH AS 2870. REFER TO ENGINEERS DETAILS FOR ALL SLAB DETAILS BRICK CONTROL JOINTS PROVIDED IN ACCORDANCE WITH NCC 2022.
- ALL STEEL FRAMING TO BE DESIGNED TO AS 4100-2020 OR AS/NZS
- INSULATION TO BE INSTALLED IN ACCORDANCE WITH NCC 2022 AND ALL APPLICABLE AUSTRALIAN STANDARDS.
- TERMITE PROTECTION IN ACCORDANCE WITH AS 3660 AND NCC 2022. GLAZING IN ACCORDANCE WITH AS 1288 AND NCC 2022.
- SMOKE ALARMS IN ACCORDANCE WITH AS 3786 AND NCC 2022. INTERNAL WATERPROOFING IN ACCORDANCE WITH NCC 2022 HOUSING PROVISIONS PART 10.2.
- EXTERNAL WATERPROOFING IN ACCORDANCE WITH AS 3740 AND AS WET AREA FLOORS TO FALL TO FLOOR WASTES AT MIN. 1:80 AND MAX.
- 1:50 GRADE (IF APPLICABLE). CONDENSATION MANAGEMENT IN ACCORDANCE WITH NCC 2022
- HOUSING PROVISIONS PART 10.8.
 BUILDING SEALING IN ACCORDANCE WITH NCC 2022.
- SERVICES IN ACCORDANCE WITH NCC 2022. EARTHWORKS IN ACCORDANCE WITH AS 3798-2007.
- EXTERNAL WALL WRAP (SARKING) IN ACCORDANCE WITH NCC 2022 (IF
- EXHAUST FANS DUCTED TO OUTSIDE AIR (IF APPLICABLE).

_		
-	SITE SPECIFIC CONT	ROLS
1	CONTROL	DETAILS
1	ACID SULPHATE SOIL	NO
	BIODIVERSITY	NO
	BUILDING ENVELOPE	NO
	BUSHFIRE	BAL-12.5
7	CLIMATE ZONE (NCC)	ZONE 7 - COOL TEMPERATE
١	DESIGN WIND CLASSIFICATION	N2 (EXPOSED TBC)
1	ESTATE/DEVELOPER GUIDELINES	NO
4	FLOOD OVERLAY	NO
4	HERITAGE	NO
2	LANDSLIP HAZARD	NO
_	MINIMUM FLOOR LEVEL	NO
	NATURAL ASSET CODE	NO
	NOISE ATTENUATION	NO
	SALINE SOIL	NO
	SHIELDING FACTOR	PS - PARTIAL SHIELDING
	SITE CLASSIFICATION	M
	SPECIFIC AREA PLAN OVERLAY	YES
	URBAN RURAL INTERFACE SPEC	CIFIC AREA PLAN
	TERRAIN CATEGORY	TC2.5
	TOPOGRAPHIC CLASSIFICATION	T1
	WATERWAY & COASTAL OVERLAY	NO
	WIND REGION	A - NORMAL
	WITHIN 1km CALM SALT WATER	NO
	WITHIN 50km BREAKING SURF	30.00km
	ZONING	RURAL LIVING

BUILDING CONTROLS	& COMPLIA	NCE				
CONTROL	REQUIRED	PROPOSED				
SETBACKS						
FRONT	MIN. 20,000mm	20,627mm				
SIDE A	MIN. 10,000mm	16,583mm				
SIDE B	MIN. 10,000mm	27,041mm				
REAR	MIN. 10,000mm	36,371mm				
BULK & SCALE						
SITE AREA	5,000m²					
SITE COVERAGE	MAX. 8%	2.74%				
LANDSCAPE						
NO APPLICABLE CONTROLS						
EARTHWORKS						
CUT DEPTH	MAX. 2,000mm	191mm				
FILL DEPTH	MAX. 800mm	435mm				
ACCESS & AMENITY						
PARKING SPACES	MIN. 2 SPACES	2 SPACES				

3D PERSPECTIVE

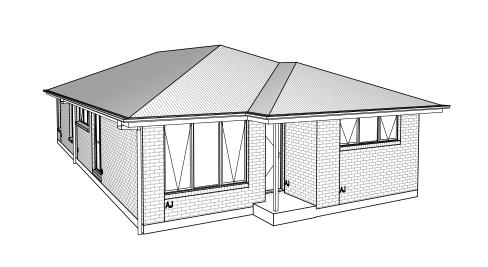

NOTE TO OWNER

THESE PLANS MAY FEATURE WORKS THAT ARE EXCLUDED FROM THE SCOPE OF WORKS WITH THE BUILDER, BUT THEY HAVE BEEN INCLUDED IN THESE DRAWINGS TO ASSIST IN THE OVERALL PLANNING AND ASSESSMENT OF THE BUILDING PROJECT. EXAMPLES OF SOME REGULARLY EXCLUDED WORKS INCLUDE DRIVEWAYS, RETAINING WALLS, SOLAR PANEL SPACING AND SITE DRAINAGE, PLEASE REFER TO YOUR SCOPE OF WORKS AND COLOUR SELECTIONS DOCUMENTATION FOR DETAILS OF INCLUDED WORKS. SOME DETAILS ARE INDICATIVE ONLY FOR EXAMPLE FLOORING, TILING, BRICKWORK AND CLADDING (EXPANSION JOINTS, ORIENTATION AND LAYOUT) AND ARE SUBJECT TO CHANGE.

LOCATION MAP



BUILDING INFORMATION

GROUND FLOOR TOP OF WALL HEIGHT(S) 2595mm NOTE: CEILING HEIGHT 45mm LOWER THAN TOP OF WALL ROOF PITCH (U.N.O.) SINGLE PHASE ELECTRICITY SUPPLY GAS SUPPLY NONE ROOF MATERIAL SHEET METAL ROOF COLOUR N/A BRICK VENEER WALL MATERIAL SLAB CLASSIFICATION

INSULATION MIN. 60mm FOIL FACED BLANKET UNDER ROOFING

CEILING	R4.1 BATTS (EXCL. GARAGE & PATIO)
EXT. WALLS	R2.0 BATTS (EXCL. GARAGE) WALL WRAP TO ENTIRE HOUSE
INT. WALLS	R2.0 BATTS ADJACENT TO GARAGE AND AS PER PLAN
FLOOR	BIAX SLAB R0.60

NCC 2022 LIVABLE HOUSING COMPLIANCE

ACCESSIBLE SANITARY COMPARTMENT: ENS ACCESSIBLE SHOWER LOCATION: ENS

GENERAL NOTES:

- THRESHOLD OF ACCESSIBLE SHOWER ENTRY TO BE MAX 5MM
- 1 EXTERIOR DOOR NOMINATED AS 870 OR GREATER TO ACHIEVE MIN 820MM CLEAR OPENING
- REFER TO APPLICABLE WET AREA PLANS AND INTERIOR ELEVATIONS OR LOCATIONS OF REQUIRED WALL REINFORCEMENT FOR FUTURE GRAB RAIL INSTALLATION.

BUSHFIRE REQUIREMENTS - BAL-12.5 THE BUILDER USES MATERIALS THAT COMPLY WITH AS 3959-2018 OR

HAVE BEEN TESTED TO AS 1530.8.1 IN ACCORDANCE WITH AS 3959-2018

- PROVIDE FOIL FACED BLANKET INSULATION TO ALL COLORBOND SHEET ROOFING.
- PROVIDE SARKING TO ALL TILED ROOFING INCLUDING PRESSTITE TO VALLEYS.
- PROVIDE BAL-12.5 RATED DEKTITE TO ALL AIR VENTS ON ROOF. PROVIDE BAL-12.5 RATED ALUMINIUM MESH TO ALL SOFFIT AND EAVE
- PROVIDE BAL-12.5 RATED ALUMINIUM MESH TO ALL EXHAUST VENTS.

VALLS, POSTS AND BEAMS:

PROVIDE SPARK ARRESTORS TO ALL EXTERNAL BRICKWORK. EXTERNAL TIMBER POSTS WITHIN 400mm OF ADJACENT FINISHED FLOOR LEVEL TO BE BUSHFIRE-RESISTING TIMBER UNLESS MOUNTED ON STIRRUPS TO PROVIDE MIN. 75mm CLEARANCE ABOVE ADJACENT FINISHED FLOOR LEVEL

/INDOWS AND DOORS: PROVIDE FLYSCREENS WITH CORROSION RESISTANT MESH TO ALL

- OPERABLE WINDOW SASHES (NO REQUIREMENT TO SCREEN BI-FOLD FRENCH / SLIDING / STACKER DOORS).
- PROVIDE BAL-12.5 RATED ALUMINIUM WINDOWS AND EXTERNAL GLASS SLIDING / STACKER DOORS.
- SPECIFIED ALUMINIUM FRENCH DOORS HAVE BEEN TESTED TO AS 1530.8.1 WITHOUT SCREENS.
- SPECIFIED ALUMINIUM WINDOWS HAVE BEEN TESTED TO AS 1530.8.1 WITHOUT SCREENS TO FIXED PANELS.
- PROVIDE ALUMINIUM DOOR JAMBS TO ALL EXTERNAL TIMBER DOORS.
 PROVIDE SAFETY SCREENS WITH CORROSION RESISTANT MESH TO EXTERNAL TIMBER HUNG DOORS (IF REQUIRED)
- PROVIDE SEAL TO ALL GARAGE PANELIFT / ROLLER DOORS.

PROVIDE COPPER WATER PIPES FROM WATER TANK TO HOUSE.

THE OWNERS ACKNOWLEDGE THAT THESE CONTRACT PLANS MAY NOT REFLECT ALL THE SELECTIONS THAT HAVE BEEN MADE OR CHANGES REQUESTED. THE OWNERS AGREE THAT FOLLOWING THE COLOUR SELECTIONS VARIATION OR UPDATING OF PLANS, THEY WILL BE PROVIDED WITH CONSTRUCTION PLANS FOR SIGNATURE PRIOR TO COMMENCEMENT OF CONSTRUCTION.

SIGNATURE: DATE:

SUBJECT TO NCC 2022 (1 MAY 2023)

WATERPROOFING & PLUMBING **CONDENSATION MANAGEMENT**

PLAN ACCEPTANCE BY OWNER SIGNATURE: DATE: SIGNATURE: DATE:

PLEASE NOTE THAT VARIATIONS WILL NOT BE ACCEPTED AFTER THIS PLAN ACCEPTANCE HAS BEEN SIGNED


PRELIMINARY PLAN SET

N	No.	AMENDMENT	SHEET	DATE	DRAWN	CHECK
3	3	PRELIMINARY PLAN SET - INITIAL ISSUE	ALL	2025.10.07	KPH	-

© 2025 WILSON HOMES PTY LTD (ABN 96 126 636 897). THIS DRAWING IS AN ORIGINAL ARTISTIC WORK WITHIN THE MEANING OF THE COPYRIGHT ACT 1968 (CTH). WILSON HOMES PTY LTD IS THE OWNER OF COPYRIGHT IN THIS DRAWING. YOU HEREBY AGREE AND UNDERTAKE THAT YOU WILL NOT

	3
WILSON	[
MIT9011	(
IIOMFC	0
ПППГ2	

SPECIFICATION:	REVISION		DRAWN	CLIENT:	HOUSE DESIGN:	HOUSE CODE:	DO NOT SCALE DRAWINGS, USE
DISCOVERY	1 DRAFT SALE PLAN - CT1	НМІ	12/09/2025	BENJAMIN ADAM SHOOBRIDGE	YORK 14	H-WDCYOR10SA	FIGURED DIMENSIONS ONLY. CHECK AND VERIFY DIMENSIONS AND
COPYRIGHT:	2 DRAFT SALE PLAN - CT1 UPDATE	HMI	1 25/09/2025	ADDRESS:	FACADE DESIGN:	FACADE CODE:	COMMENCEMENT OF ANY WORK. ALL
© 2025	3 PRELIM PLANS - INITIAL ISSUE	KPH	07/10/2025	45 GLEN LEA ROAD, PONTVILLE TAS 7030	CLASSIC	F-WDCYOR10CLASA	DISCREPANCIES TO BE REPORTED 1.2 TO THE DRAFTING OFFICE.
				LOT / SECTION / CT: COUNCIL:	SHEET TITLE:	SHEET No.: SCALES:	744044
				2 / - / 189251 BRIGHTON	COVER SHEET	1 / 23 1:100	714341

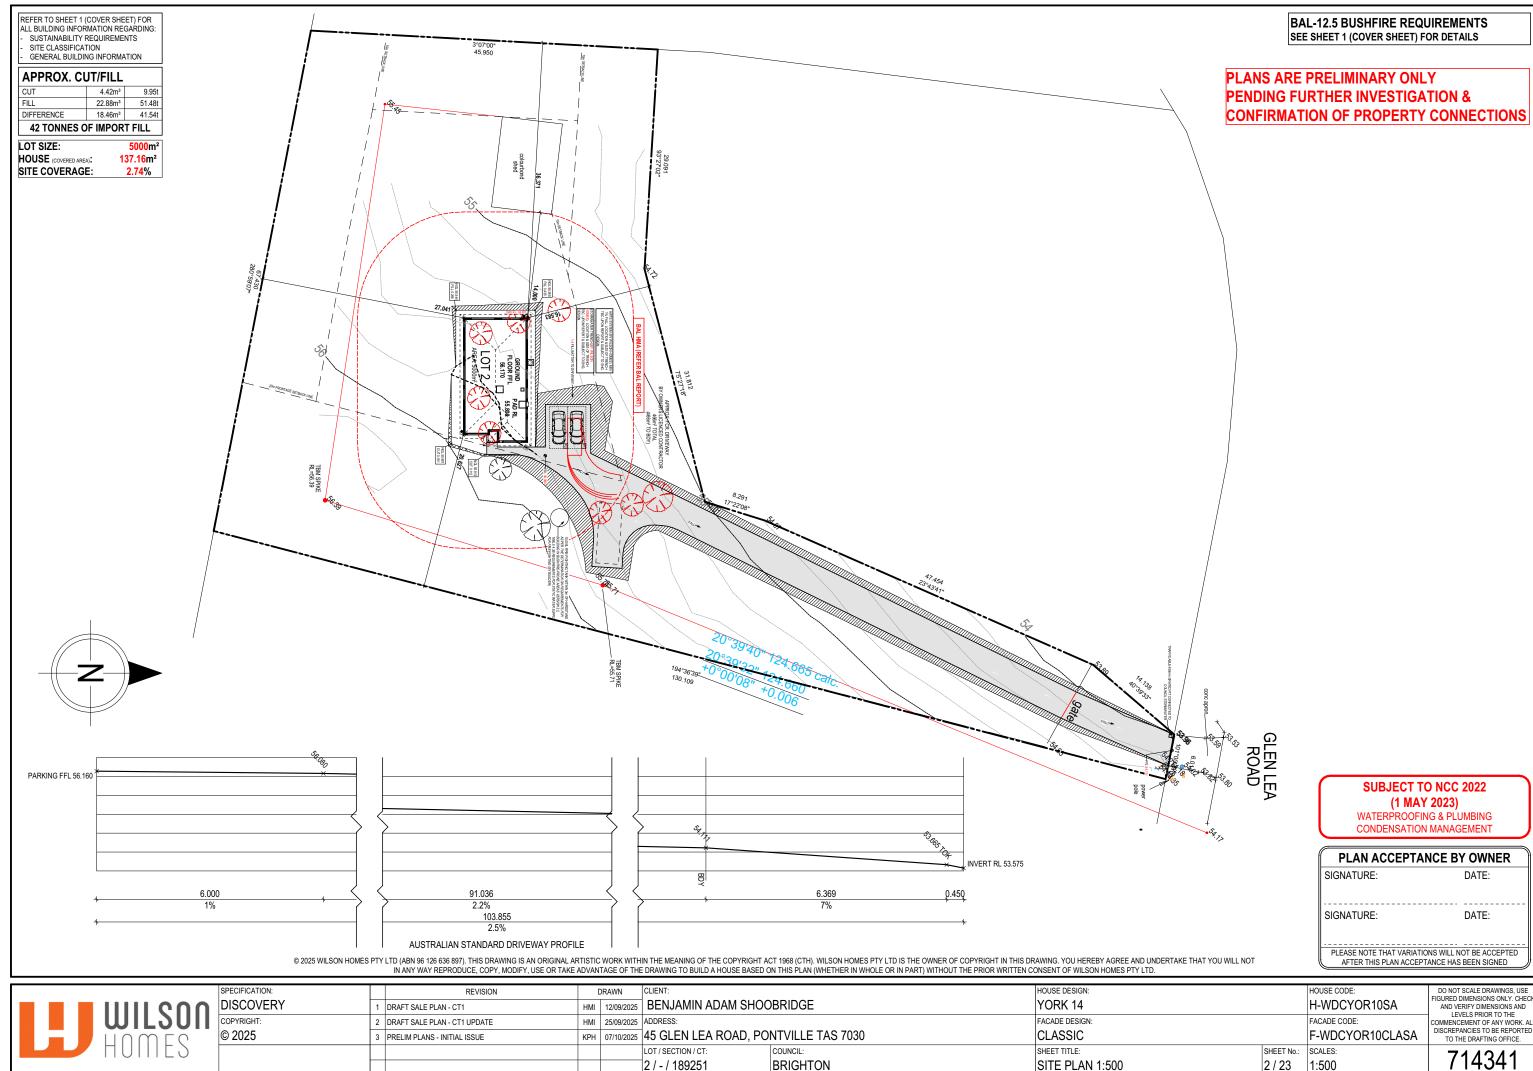


2 / - / 189251

BRIGHTON

SITE PLAN 1:500

2 / 23

1:500

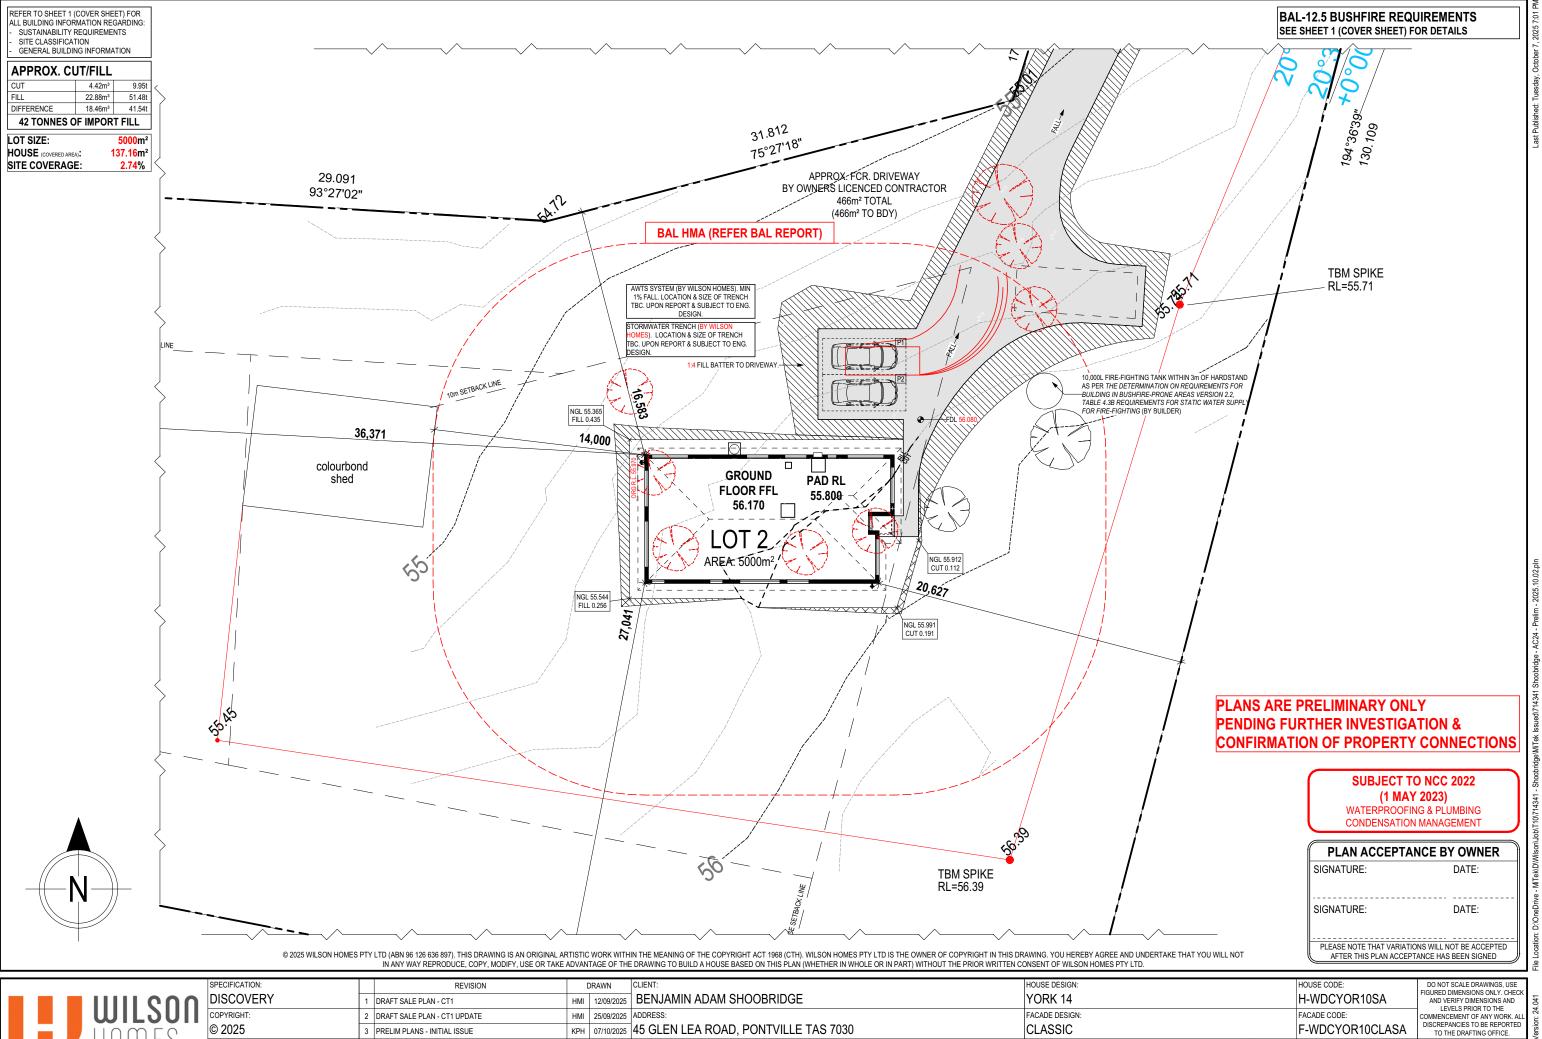

		SPECIFICATION:	REVISION	DF	RAWN CLIENT:		HOUSE DESIGN:		HOUSE CODE:
		DISCOVERY	1 DRAFT SALE PLAN - CT1	НМІ	12/09/2025 BENJAMIN ADAM SHOO	BRIDGE	YORK 14		H-WDCYOR10SA
	OILOUII	COPYRIGHT:	2 DRAFT SALE PLAN - CT1 UPDATE		25/09/2025 ADDRESS:		FACADE DESIGN:		FACADE CODE:
	IIUWEC	© 2025	3 PRELIM PLANS - INITIAL ISSUE	KPH	07/10/2025 45 GLEN LEA ROAD, PON	NTVILLE TAS 7030	CLASSIC		F-WDCYOR10CLASA
	UUIIIE)				LOT / SECTION / CT:	COUNCIL:	SHEET TITLE:	SHEET No.:	SCALES:
					2 / - / 189251	BRIGHTON	SITE PLAN 1:250	3 / 23	1:250

ALL VEGETATION OUTSIDE THE BUILDING ZONE WILL BE MAINTAINED.

OWNER TO STABILISE THE SITE ON COMPLETION OF THE BUILD WITH TURF LAWNS, GRASS SEEDS, NATIVE GROUND COVERS AND/ OR MULCH SPREAD TO A DEPTH OF 75-100mm

THE FOLLOWING IS A STANDARD APPROACH. SEDIMENT AND EROSION CONTROL MEASURES WILL BE REVIEWED PRIOR TO COMMENCING WORK AND INSTALLED BASED ON THE OUTCOME OF THAT REVIEW.

1. ALL EROSION AND SEDIMENT CONTROL STRUCTURES TO BE INSPECTED EACH WORKING DAY AND MAINTAINED IN GOOD WORKING ORDER.

- 2. ALL GROUND COVER VEGETATION OUTSIDE THE IMMEDIATE BUILDING AREA TO BE PRESERVED DURING THE BUILDING
- 3. ALL EROSION AND SEDIMENT CONROL MEASURES TO BE INSTALLED PRIOR TO COMMENCEMENT OF MAJOR EARTHWORKS.
- 4. STOCKPILES OF CLAYEY MATERIAL TO BE COVERED WITH AN IMPERVIOUS SHEET. 5. ROOF WATER DOWNPIPES TO BE CONNECTED TO THE PERMAMENT UNDERGROUND STORMWATER DRAINAGE SYSTEM AS SOON AS PRACTICAL AFTER

THE ROOF IS LAID.

50 x 25 x 1000

STAR PICKET


NATURAL SURFACE

DOWNHILL OF MEMBRANE

NOT TO BE DISTURBED

STAKE OR

6. DIVERSION DRAINS ARE TO BE CONNECTED TO A LEAGAL DISCHARGE POINT (COUNCIL STORMWATER SYSTEM, WATERCOURSE OR ROAD DRAIN). 7. SEDIMENT RETENTION TRAPS INSTALLED AROUND THE INLETS TO THE STORMWATER SYSTEM TO PREVENT SEDIMENT & OTHER DEBRIS BLOCKING THE DRAINS.

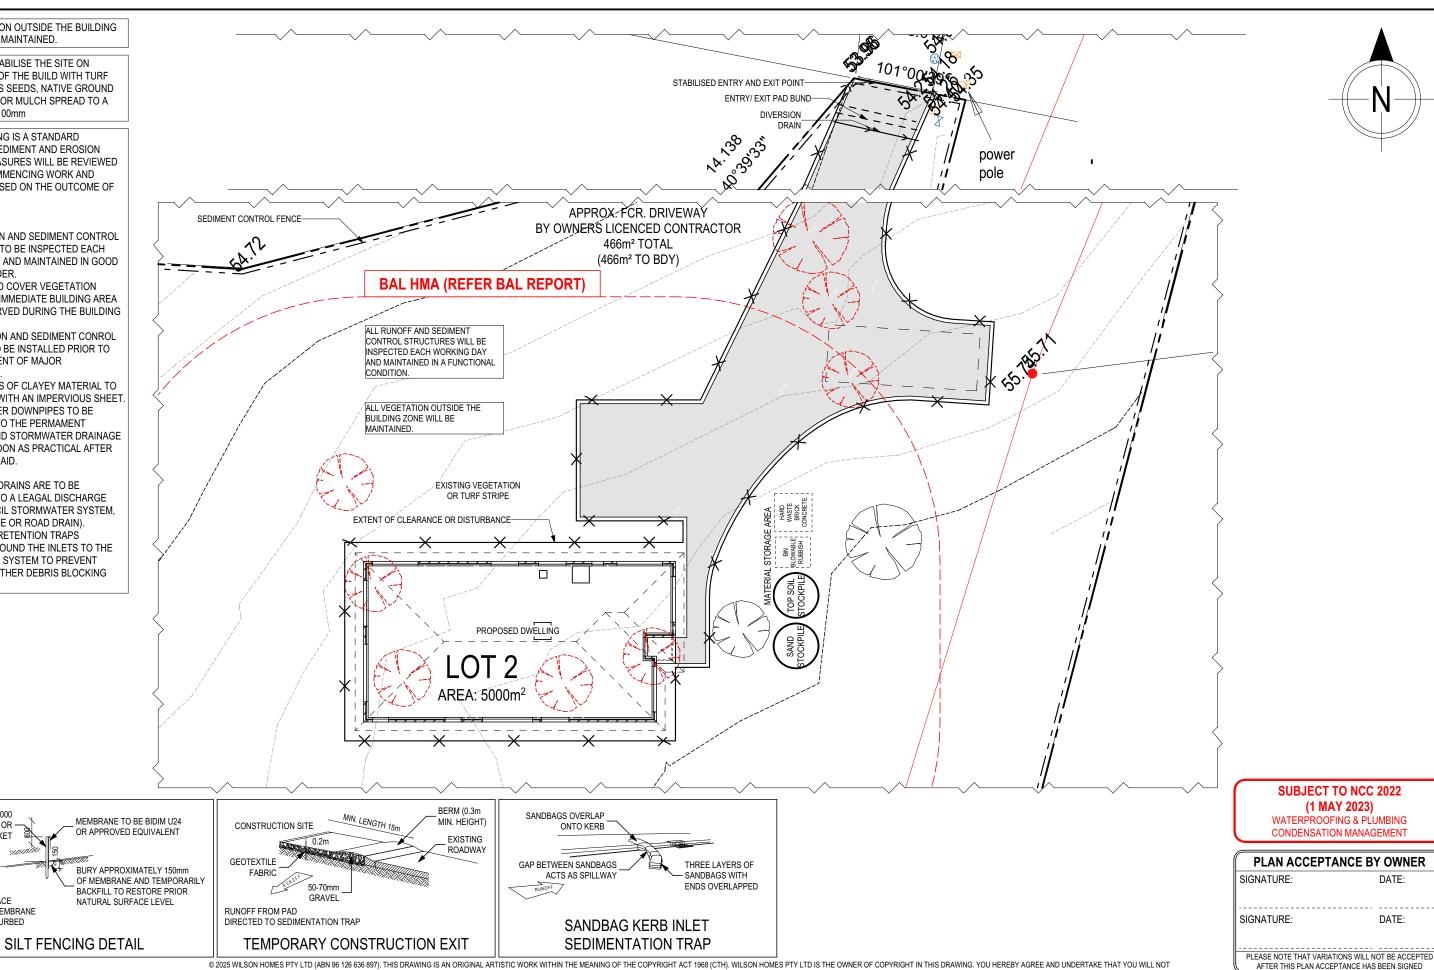



		IN ANT WAT INCIDENCE, OUT I, MODIL I, OUL OIL TAIN	LADVANTAGE OF THE DIVAMING TO BOILD A HOUGE BAGED C	SIN THIS I EAR (WHE THER IN WHOLE OR IN FART) WITHOUT THE I RIGIR WRITTEN	ONOLINI OI WILOON TIOMILOTTI ETD.		ü	Ē
	SPECIFICATION:	REVISION	DRAWN CLIENT:		HOUSE DESIGN:	HOUSE CODE:	DO NOT SCALE DRAWINGS, USE	
n	DISCOVERY	1 DRAFT SALE PLAN - CT1	HMI 12/09/2025 BENJAMIN ADAM SHOO	DBRIDGE	YORK 14	H-WDCYOR10SA	FIGURED DIMENSIONS ONLY. CHECK AND VERIFY DIMENSIONS AND	<u> </u>
		2 DRAFT SALE PLAN - CT1 UPDATE	HMI 25/09/2025 ADDRESS:		FACADE DESIGN:	FACADE CODE:	LEVELS PRIOR TO THE COMMENCEMENT OF ANY WORK. ALL	.≓ 1.
<u> </u>	© 2025	3 PRELIM PLANS - INITIAL ISSUE	крн 07/10/2025 45 GLEN LEA ROAD, PO	NTVILLE TAS 7030	CLASSIC	F-WDCYOR10CLASA	DISCREPANCIES TO BE REPORTED TO THE DRAFTING OFFICE.	/ersin
)				COUNCIL:	SHEET TITLE:	SHEET No.: SCALES:	71/2/1	ate
			2 / - / 189251	BRIGHTON	SOIL & WATER MANAGEMENT PLAN	4 / 23 1:200	714341	声

IN ANY WAY REPRODUCE CODY, MODIEY LISE OR TAKE ADVANTAGE OF THE DRAWING TO RUIL DIA HOUSE RASED ON THIS DIAM (WHETHER IN WHOLE OR IN DART) WITHOUT THE DRIOR WRITTEN CONSENT OF WILSON HOMES DAY UT

REFER TO SHEET 1 (COVER SHEET) FOR

ALL BUILDING INFORMATION REGARDING:
- SUSTAINABILITY REQUIREMENTS
- SITE CLASSIFICATION GENERAL BUILDING INFORMATION

ALL MECHANICAL VENTILATION TO BE DISCHARGED TO OUTDOOR AIR AS PER NCC 2022 REQUIREMENTS

FIRE RESISTANT PLASTERBOARD TO BE INSTALLED BEHIND COOKTOP

ALL GROUND FLOOR BULKHEAD AND SQUARE SET OPENING FRAMES TO BE 2155 ABOVE FFL UNLESS NOTED OTHERWISE

REFER TO WINDOW AND DOOR SCHEDULES FOR FULL DETAILS OF ALL WINDOWS AND DOORS. PLEASE NOTE WINDOW AND DOOR SIZES ARE BASED ON MANUFACTURERS SPECIFICATIONS AT DEPOSIT STAGE AND MAY DIFFER SLIGHTLY TO THE SIZES NOMINATED IN THE SCOPE OF WORKS DUE TO MANUFACTURING CHANGES AT THE TIME OF CONSTRUCTION.

FINAL WINDOW AND EXTERIOR DOOR LOCATIONS MAY BE ADJUSTED ON SITE TO SUIT BRICKWORK GAUGE

UNLESS NOTED OTHERWISE ALL ROOMS ARE REFERENCED AS FOLLOWS:



LEGEND

HS / WS HOB SPOUT / WALL SPOUT

FACE BRICK / COMMON BRICK

SOUND INSULATION

BRICK ARTICULATION JOINT SDP STANDARD DOWNPIPE

CDP CHARGED DOWNPIPE

3D L.B.W

MECHANICAL VENTILATION LOAD BEARING WALL

DENOTES DRAWER SIDE

PB PLASTERBOARD

FC FIBRE CEMENT

THIS DOOR OPENS FIRST **I**

SMOKE ALARM LIFT OFF HINGE

WATER POINT

+


GAS BAYONET


MAIN DWELLING, GROUND FLOOR

135.31 LIVING PORCH 1.85 137.16 m² ANY PART OF THE FASCIA, GUTTERING OR DOWNPIPE THAT IS WITHIN 450mm OF ANY BOUNDARY IS TO BE NON-COMBUSTIBLE IN ACCORDANCE WITH NCC 2022

ALL EXTERIOR SLABS TO BE GRADED BY CONCRETER TO ACHIEVE APPROX. 1:100 FALL TO OUTSIDE EDGE WITH MAXIMUM CROSSFALL OF 30mm OVER ENTIRE SLAB.

16,500 2,850 BED 2 90_{**} 1,930 BATH 90_{**} 1,830 ENS 90_{**} 2,965 DINING 90₊₁1,020 REF₊₁90 1,435 90,60,90 PANTRY P0 3,300 BED 1 5,750 KITCHEN / DINING 90129 1,550 ROBE ,90 1,000 ,90 1,930 <u>,,90 1,830 WIR</u> 90

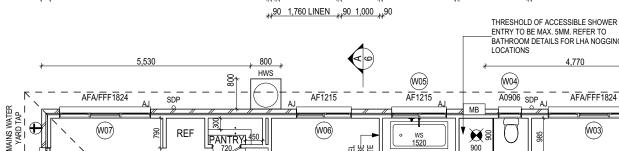

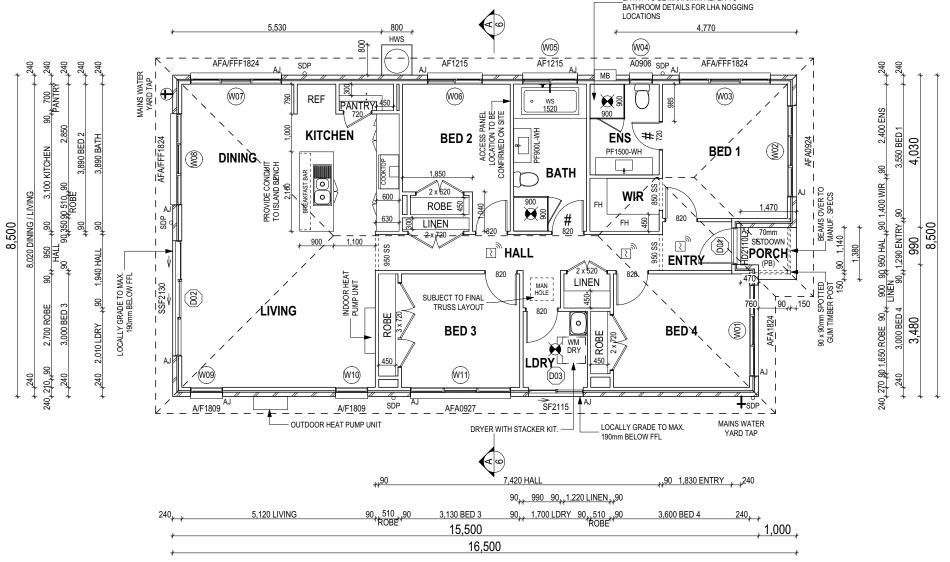

(1 MAY 2023) WATERPROOFING & PLUMBING

SUBJECT TO NCC 2022

CONDENSATION MANAGEMENT

PLAN ACCEPTA	NCE BY OWNER	
SIGNATURE:	DATE:	
SIGNATURE:	DATE:	
PLEASE NOTE THAT VARIATION AFTER THIS PLAN ACCEP	ONS WILL NOT BE ACCEPTED TANCE HAS BEEN SIGNED	

ALL DIMENSIONS ARE FRAME DIMENSIONS

© 2025 WILSON HOMES PTY LTD (ABN 96 126 636 897). THIS DRAWING IS AN ORIGINAL ARTISTIC WORK WITHIN THE MEANING OF THE COPYRIGHT ACT 1968 (CTH). WILSON HOMES PTY LTD IS THE OWNER OF COPYRIGHT IN THIS DRAWING. YOU HEREBY AGREE AND UNDERTAKE THAT YOU WILL NOT IN ANY WAY REPRODUCE, COPY, MODIFY, USE OR TAKE ADVANTAGE OF THE DRAWING TO BUILD A HOUSE BASED ON THIS PLAN (WHETHER IN WHOLE OR IN PART) WITHOUT THE PRIOR WRITTEN CONSENT OF WILSON HOMES PTY LTD.



-		IN AIRT WAT REPRODUCE, OUP 1, MODIF 1, USE ON TAKE ADVANTAGE OF THE DRAWING TO BUILD A HOUSE BASED ON THIS PLAN (WHETHER IN WHOLE ON THE PRIOR WRITTEN CONSENT OF WILSON HOUSES PT LTD.												
7	SPECIFICATION:	$_{1}$	REVISION	$\overline{}$	DRAWN	CLIENT:			HOUSE DESIGN:		HOUSE CODE:	DO NOT SCALE DRAWINGS, USE		
. !	DISCOVERY	11	DRAFT SALE PLAN - CT1	HMI	12/09/2025	BENJAMIN ADAM SHOOI	JBRIDGE		YORK 14		H-WDCYOR10SA	FIGURED DIMENSIONS ONLY. CHECK AND VERIFY DIMENSIONS AND		
1	1	12	P DRAFT SALE PLAN - CT1 UPDATE	HMI	25/09/2025	ADDRESS:			FACADE DESIGN:		FACADE CODE:	LEVELS PRIOR TO THE COMMENCEMENT OF ANY WORK. ALL		
- 1	© 2025	3	PRELIM PLANS - INITIAL ISSUE	KPH	07/10/2025	45 GLEN LEA ROAD, PON	NTVILLE TAS 7030		CLASSIC		F-WDCYOR10CLASA	DISCREPANCIES TO BE REPORTED TO THE DRAFTING OFFICE.	/ersio	
1		$_{1}$				LOT / SECTION / CT:	COUNCIL:		SHEET TITLE:	SHEET N	No.: SCALES:	744944	ate \	
- 1	, F	1		1		2 / - / 189251	BRIGHTON		GROUND FLOOR PLAN	5 / 23	1:100	714341	Temp	

EXISTING GROUND LEVEL

EAST ELEVATION SCALE: 1:100

90 x 90mm SPOTTED GUM TIMBER POST-

RL 60.677 - RIDGE LEVEL COLORBOND CORRUGATED / CUSTOM ORB METAL ROOFING +-FOIL FACED BLANKET RL 58.765 - TOP OF WALL RL 56.170 - GROUND FLOOR RL 55.800 - PAD LEVEL -ARTICULATED FACE BRICKWORK 1:2 FILL BATTER EXISTING GROUND LEVEL -ALUMINIUM STACKER DOOR-PAINTED FC SHEET OVER DOOR

> WEST ELEVATION SCALE: 1:100

REFER TO SHEET 1 (COVER SHEET) FOR ALL BUILDING INFORMATION REGARDING: SUSTAINABILITY REQUIREMENTS

SITE CLASSIFICATION GENERAL BUILDING INFORMATION


SOME DETAILS ON THIS SHEET ARE INDICATIVE ONLY FOR EXAMPLE BRICKWORK AND CLADDING (EXPANSION JOINTS, ORIENTATION AND LAYOUT) AND ARE SUBJECT TO CHANGE.

SH = SNAP HEADER SILL

BEDROOM WINDOW OPENINGS ABOVE 2m OFF THE SURFACE BENEATH TO BE RESTRICTED AS REQUIRED BY NCC 11.3.7 (VOLUME TWO)

ROOMS OTHER THAN BEDROOM WINDOW OPENINGS ABOVE 4m OFF THE SURFACE BENEATH TO BE RESTRICTED AS REQUIRED BY NCC 11.3.7 (VOLUME TWO)


REFER TO THE FOLLOWING DETAILS: BRICK COURSING W-BRIC-001

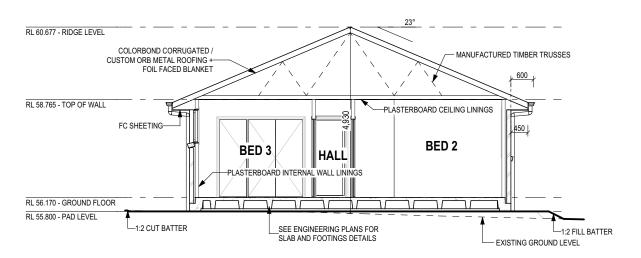


SECTION A-A SCALE: 1:100

SUBJECT TO NCC 2022 (1 MAY 2023)

WATERPROOFING & PLUMBING CONDENSATION MANAGEMENT

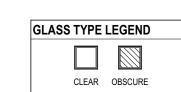

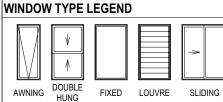

PLAN ACCEPTANCE BY OWNER SIGNATURE: DATE: SIGNATURE: DATE: PLEASE NOTE THAT VARIATIONS WILL NOT BE ACCEPTED


AFTER THIS PLAN ACCEPTANCE HAS BEEN SIGNED

© 2025 WILSON HOMES PTY LTD (ABN 96 126 636 897). THIS DRAWING IS AN ORIGINAL ARTISTIC WORK WITHIN THE MEANING OF THE COPYRIGHT ACT 1968 (CTH). WILSON HOMES PTY LTD IS THE OWNER OF COPYRIGHT IN THIS DRAWING. YOU HEREBY AGREE AND UNDERTAKE THAT YOU WILL NOT

WILSON
HOMES

	IN ANY WAY REPRODUCE, COPY, MODIFY, USE OR TAKE ADVANTAGE OF THE DRAWING TO BUILD A HOUSE BASED ON THIS PLAN (WHE THEK IN WHOLE OR IN PART) WITHOUT THE PRIOR WRITTEN CONSENT OF WILSON HOMES PTY LID.										
	SPECIFICATION:	REVISION	DRAWN CLIENT:		HOUSE DESIGN:		HOUSE CODE:	DO NOT SCALE DRAWINGS, USE FIGURED DIMENSIONS ONLY. CHECK			
\cap	DISCOVERY	1 DRAFT SALE PLAN - CT1	HMI 12/09/2025 BENJAMIN ADAM	1 SHOOBRIDGE	YORK 14	YORK 14		AND VERIFY DIMENSIONS AND LEVELS PRIOR TO THE	<u>4</u>		
Ш	COPYRIGHT:		HMI 25/09/2025 ADDRESS:		FACADE DESIGN:			COMMENCEMENT OF ANY WORK. ALL	7 :UC		
	© 2025	3 PRELIM PLANS - INITIAL ISSUE	KPH 07/10/2025 45 GLEN LEA ROA	AD, PONTVILLE TAS 7030	CLASSIC		F-WDCYOR10CLASA	DISCREPANCIES TO BE REPORTED TO THE DRAFTING OFFICE.	Versi		
			LOT / SECTION / CT:	COUNCIL:			SCALES:	714341	olate		
			2 / - / 189251	BRIGHTON	ELEVATIONS / SECTION	6 / 23	1:100	1 14041	Tem		


SOUTH ELEVATION SCALE: 1:100

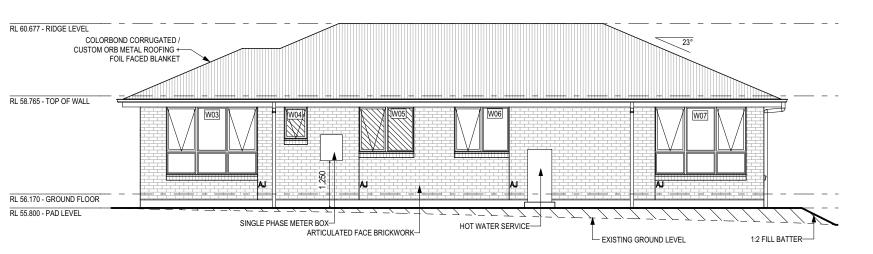

NORTH ELEVATION SCALE: 1:100

SUBJECT TO NCC 2022 (1 MAY 2023)

WATERPROOFING & PLUMBING CONDENSATION MANAGEMENT

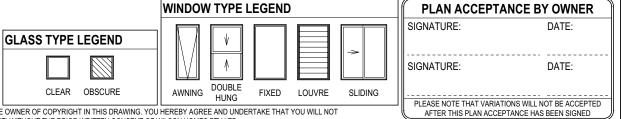

© 2025 WILSON HOMES PTY LTD (ABN 96 126 636 897). THIS DRAWING IS AN ORIGINAL ARTISTIC WORK WITHIN THE MEANING OF THE COPYRIGHT ACT 1968 (CTH). WILSON HOMES PTY LTD IS THE OWNER OF COPYRIGHT IN THIS DRAWING. YOU HEREBY AGREE AND UNDERTAKE THAT YOU WILL NOT



_		IN ANY WAY REPRODUCE, COPY, MODIFY, USE OR TAKE ADVANTAGE OF THE DRAWING TO BUILD A HOUSE BASED ON THIS PLAN (WHETHER IN WHOLE OR IN PART) WITHOUT THE PRIOR WRITTEN CONSENT OF WILSON HOMES PTY LTD.												
- 1	SPECIFICATION:	REVISION			DRAWN	CLIENT:			HOUSE DESIGN:			HOUSE CODE:	DO NOT SCALE DRAWINGS, USE	
1	DISCOVERY	1 1	DRAFT SALE PLAN - CT1	HMI	12/09/2025	BENJAMIN ADAM SHOOI	JBRIDGE	I	YORK 14			H-WDCYOR10SA	FIGURED DIMENSIONS ONLY. CHECK AND VERIFY DIMENSIONS AND LEVELS PRIOR TO THE	140
	I I	1 2	DRAFT SALE PLAN - CT1 UPDATE	HMI	25/09/2025	ADDRESS:			FACADE DESIGN:			FACADE CODE:	COMMENCEMENT OF ANY WORK. ALL	
1	© 2025	3	PRELIM PLANS - INITIAL ISSUE	KPH	07/10/2025	45 GLEN LEA ROAD, PON	NTVILLE TAS 7030	I	CLASSIC			F-WDCYOR10CLASA	DISCREPANCIES TO BE REPORTED TO THE DRAFTING OFFICE.	
Γ		$_{1}$			1		COUNCIL:		SHEET TITLE:	I	SHEET No.:		711211	late \
_		\bot^{\top}				2 / - / 189251	BRIGHTON		ELEVATIONS	7	7 / 23	1:100	714341	Temp

Last Published: Tuesday, October 7,

REFER TO SHEET 1 (COVER SHEET) FOR ALL BUILDING INFORMATION REGARDING:

SUSTAINABILITY REQUIREMENTS
 SITE CLASSIFICATION
 GENERAL BUILDING INFORMATION

SOME DETAILS ON THIS SHEET ARE INDICATIVE ONLY FOR EXAMPLE

BRICKWORK AND CLADDING (EXPANSION JOINTS, ORIENTATION AND LAYOUT) AND

BENEATH TO BE RESTRICTED AS REQUIRED BY NCC 11.3.7 (VOLUME

ROOMS OTHER THAN BEDROOM WINDOW OPENINGS ABOVE 4m OFF THE SURFACE BENEATH TO BE RESTRICTED AS REQUIRED BY NCC

REFER TO THE FOLLOWING DETAILS:

ARE SUBJECT TO CHANGE.

SH = SNAP HEADER SILL

BEDROOM WINDOW OPENINGS
ABOVE 2m OFF THE SURFACE

11.3.7 (VOLUME TWO)

BRICK COURSING W-BRIC-001

TWO)

.DIWilson\Job\T10\714341 - Shoobridge\WiTek Issued\714341 Shoobridge - AC24 - Prelim - 2025.10.02.pl

Sliding Door

Stacking Door

Hinged Door

Fixed External Window

Windows supplied MUST HAVE Uw better and or equal to stated figures and SHGC within +/- 5% of stated figures. Restricted windows to have their openability restricted as per N.C.C 11.3.6.

STOREY	ID	CODE ¹	TYPE	ROOM	HEIGHT	WIDTH	PERIMETER		FRAME TYPE	BAL RATING	SILL TYPE	ORIENT.	GLAZING AREA (m²)	GLAZING (SINGLE GLAZING U.N.O.)	ADDITIONAL INFORMATION
WINDOW				•						-					<u>'</u>
GROUND FLOOR	W01	AFA1824	AWNING	BED 4	1,800	2,410	8,420	4.34	ALUMINIUM	BAL-12.5	SNAP HEADER	Е	3.53	CLEAR, DOUBLE GLAZED	MP 803-803
GROUND FLOOR	W02	AFA0924	AWNING	BED 1	857	2,410	6,534	2.07	ALUMINIUM	BAL-12.5	SNAP HEADER	Е	1.56	CLEAR, DOUBLE GLAZED	MP 803-803
GROUND FLOOR	W03	AFA/FFF1824	AWNING	BED 1	1,800	2,410	8,420	4.34	ALUMINIUM	BAL-12.5	ANGLED	N	3.43	CLEAR, DOUBLE GLAZED	BP 600, MP 803-803/803-803
GROUND FLOOR	W04	A0906	AWNING	ENS	857	610	2,934	0.52	ALUMINIUM	BAL-12.5	ANGLED	N	0.35	OBSCURE, DOUBLE GLAZED, TOUGHENED	
GROUND FLOOR	W05	AF1215	AWNING	BATH	1,200	1,450	5,300	1.74	ALUMINIUM	BAL-12.5	ANGLED	N	1.38	OBSCURE, DOUBLE GLAZED, TOUGHENED	MP 725
GROUND FLOOR	W06	AF1215	AWNING	BED 2	1,200	1,450	5,300	1.74	ALUMINIUM	BAL-12.5	ANGLED	N	1.38	CLEAR, DOUBLE GLAZED	MP 725
GROUND FLOOR	W07	AFA/FFF1824	AWNING	DINING	1,800	2,410	8,420	4.34	ALUMINIUM	BAL-12.5	ANGLED	N	3.43	CLEAR, DOUBLE GLAZED	BP 600, MP 803-803/803-803
GROUND FLOOR	W08	AFA/FFF1824	AWNING	DINING	1,800	2,410	8,420	4.34	ALUMINIUM	BAL-12.5	ANGLED	W	3.43	CLEAR, DOUBLE GLAZED	BP 600, MP 803-803/803-803
GROUND FLOOR	W09	A/F1809	AWNING	LIVING	1,800	850	5,300	1.53	ALUMINIUM	BAL-12.5	ANGLED	S	1.19	CLEAR, DOUBLE GLAZED	BP 600
GROUND FLOOR	W10	A/F1809	AWNING	LIVING	1,800	850	5,300	1.53	ALUMINIUM	BAL-12.5	ANGLED	S	1.19	CLEAR, DOUBLE GLAZED	BP 600
GROUND FLOOR	W11	AFA0927	AWNING	BED 3	857	2,650	7,014	2.27	ALUMINIUM	BAL-12.5	ANGLED	S	1.74	CLEAR, DOUBLE GLAZED	MP 883-883
							71,362 mm	28.75					22.61		
DOOR															
GROUND FLOOR	D01	HD2110L	SWINGING	ENTRY	2,100	970	6,140	2.04	ALUMINIUM	BAL-12.5	SNAP HEADER	Е	1.41	N\A	
GROUND FLOOR	D02	SSF2130	STACKER	LIVING	2,100	3,048	10,296	6.40	ALUMINIUM	BAL-12.5	SNAP HEADER	W	5.67	CLEAR, TOUGHENED	
GROUND FLOOR	D03	SF2115	SLIDING	LDRY	2,100	1,450	7,100	3.05	ALUMINIUM	BAL-12.5	SNAP HEADER	S	2.59	CLEAR, TOUGHENED	
							23,536 mm	11.48					9.67		
							94.898 mm	40.23					32.28		

Provide BAL-12.5 rated aluminium windows and external glass sliding doors in lieu

Provide flyscreens with corrosion resistant mesh to all opening window sashes only.

STOREY	QTY	CODE	TYPE	HEIGHT	WIDTH	GLAZING TYPE	ADDITIONAL INFORMATION
DOOR			·	•			
GROUND FLOOR	1	2 x 520	SWINGING	2,040	1,040	N/A	
GROUND FLOOR	1	2 x 620	SWINGING	2,040	1,240	N/A	
GROUND FLOOR	2	2 x 720	SWINGING	2,040	1,440	N/A	
GROUND FLOOR	1	3 x 720	SWINGING	2,040	2,194	N/A	
GROUND FLOOR	1	720	SWINGING	2,040	720	N/A	LIFT-OFF HINGES
GROUND FLOOR	1	720	SWINGING	2,040	720	N/A	
GROUND FLOOR	5	820	SWINGING	2,040	820	N/A	
GROUND FLOOR	1	820	SWINGING	2,040	820	N/A	LIFT-OFF HINGES
GROUND FLOOR	1	850 SS	SQUARE SET OPENING	2,155	850	N/A	
GROUND FLOOR	2	950 SS	SQUARE SET OPENING	2,155	950	N/A	

PICTURE, TV RECESS AND SS WINDOW OPENINGS QTY TYPE HEIGHT WIDTH AREA (m²)

NOTE: INTERNAL DOORS TO WET AREAS WITH MECHANICAL VENTILATION TO BE UNDERCUT 20mm

© 2025 WILSON HOMES PTY LTD (ABN 96 126 636 897). THIS DRAWING IS AN ORIGINAL ARTISTIC WORK WITHIN THE MEANING OF THE COPYRIGHT ACT 1968 (CTH). WILSON HOMES PTY LTD IS THE OWNER OF COPYRIGHT IN THIS DRAWING. YOU HEREBY AGREE AND UNDERTAKE THAT YOU WILL NOT IN ANY WAY REPRODUCE, COPY, MODIFY, USE OR TAKE ADVANTAGE OF THE DRAWING TO BUILD A HOUSE BASED ON THIS PLAN (WHETHER IN WHOLE OR IN PART) WITHOUT THE PRIOR WRITTEN CONSENT OF WILSON HOMES PTY LTD.

SUBJECT TO NCC 2022 (1 MAY 2023)

3.02

4.03

4.03

4.29

DOW-038-005

AMJ-007-005

AMJ-007-005 GRN-009-001

0.66

0.59

0.59

0.53

WATERPROOFING & PLUMBING CONDENSATION MANAGEMENT

PLAN ACCEPTANCE BY OWNER							
SIGNATURE:	DATE:						
SIGNATURE:	DATE:						

PLEASE NOTE THAT VARIATIONS WILL NOT BE ACCEPTED AFTER THIS PLAN ACCEPTANCE HAS BEEN SIGNED

SUSTAINABILITY REQUIREMENTS

GENERAL BUILDING INFORMATION

REFER TO SHEET 1 (COVER SHEET) FOR BAL-12.5 BUSHFIRE REQUIREMENTS

SEE SHEET 1 (COVER SHEET) FOR DETAILS

	SPECIFICATION:	REVISION	DRAWN	CLIENT:		HOUSE DESIGN:		HOUSE CODE:	DO NOT SCALE DRAWINGS, USE
1	DISCOVERY	1 DRAFT SALE PLAN - CT1	HMI 12/09/2025	BENJAMIN ADAM SHOO	DBRIDGE	YORK 14		H-WDCYOR10SA	FIGURED DIMENSIONS ONLY. CHECK AND VERIFY DIMENSIONS AND LEVELS PRIOR TO THE
	COPYRIGHT:	2 DRAFT SALE PLAN - CT1 UPDATE	HMI 25/09/2025			FACADE DESIGN:			COMMENCEMENT OF ANY WORK. ALL
	© 2025	3 PRELIM PLANS - INITIAL ISSUE	KPH 07/10/2025	45 GLEN LEA ROAD, PO	NTVILLE TAS 7030	CLASSIC		F-WDCYOR10CLASA	DISCREPANCIES TO BE REPORTED TO THE DRAFTING OFFICE.
				LOT / SECTION / CT:	COUNCIL:	SHEET TITLE:		SCALES:	71/2/1
				2 / - / 189251	BRIGHTON	WINDOW & DOOR SCHEDULES	8 / 23		714341

ROOM	AREA (m2)	WINDOW ID	LIGHT REQUIRED (m2)	LIGHT ACHIEVED (m2)	VENTILATION REQ`D (m2)	VENTILATION ACH'D (m2)	
OPEN KITCHEN/ LIVING/	42.12 m²	D02, W07, W08, W09, W010	4.21 m²	14.91 m²	2.11 m²	9.46 m²	
DINING	42.12111	D02, VV07, VV00, VV09, VV010	4.21111	14.81111	2.11111	9.40 111	
BED 1	11.71 m²	W02, W03	1.17 m²	4.99 m²	0.59 m²	3.02 m ²	
BED 2	9.95 m²	W06	1.00 m²	1.38 m²	0.50 m²	0.79 m²	
BED 3	10.77 m²	W011	1.08 m²	1.74 m²	0.54 m²	1.38 m²	
BED 4	11.64 m²	W01	1.16 m²	3.53 m²	0.58 m²	2.68 m²	

PART 10.5.1 LIGHT: Minimum 10% of the floor area of a habitable room required (natural light)

PART 10.6 VENTILATION: Minimum 5% of the floor area of a habitable room required. (An exhaust fan may be used for sanitary compartment, laundry or bathroom provided contaminated air discharges directly to the outside of the building by way of ducts).

SUBJECT TO NCC 2022 (1 MAY 2023)

WATERPROOFING & PLUMBING CONDENSATION MANAGEMENT

PLAN ACCEPTANCE BY OWNER SIGNATURE: DATE: SIGNATURE: DATE: PLEASE NOTE THAT VARIATIONS WILL NOT BE ACCEPTED AFTER THIS PLAN ACCEPTANCE HAS BEEN SIGNED

REFER TO SHEET 1 (COVER SHEET) FOR ALL BUILDING INFORMATION REGARDING:
- SUSTAINABILITY REQUIREMENTS

BAL-12.5 BUSHFIRE REQUIREMENTS
SEE SHEET 1 (COVER SHEET) FOR DETAILS

© 2025 WILSON HOMES PTY LTD (ABN 96 126 636 897). THIS DRAWING IS AN ORIGINAL ARTISTIC WORK WITHIN THE MEANING OF THE COPYRIGHT ACT 1968 (CTH). WILSON HOMES PTY LTD IS THE OWNER OF COPYRIGHT IN THIS DRAWING. YOU HEREBY AGREE AND UNDERTAKE THAT YOU WILL NOT IN ANY WAY REPRODUCE, COPY, MODIFY, USE OR TAKE ADVANTAGE OF THE DRAWING TO BUILD A HOUSE BASED ON THIS PLAN (WHETHER IN WHOLE OR IN PART) WITHOUT THE PRIOR WRITTEN CONSENT OF WILSON HOMES PTY LTD.

	_
	SI
WILSON	0
mir9011	C
11000 50	@
HUIILS	

SUSTAINABILITY REQUIREMENTS SITE CLASSIFICATION

GENERAL BUILDING INFORMATION

		117102 01 1111	in browning to being three by the both the first time to be the browning three br	CELL ST MESSITIONES TO ELS.			iΣ
SPECIFICATION:	REVISION	DRAWN	CLIENT: H	OUSE DESIGN:	HOUSE CODE:	DO NOT SCALE DRAWINGS, USE	i
DISCOVERY	1 DRAFT SALE PLAN - CT1 HM	12/09/2025	BENJAMIN ADAM SHOOBRIDGE	ORK 14	H-WDCYOR10SA	AND VERIFY DIMENSIONS AND	.04
COPYRIGHT:		1 25/09/2025		ACADE DESIGN:		LEVELS PRIOR TO THE COMMENCEMENT OF ANY WORK. ALL	on: 24
© 2025	3 PRELIM PLANS - INITIAL ISSUE KPH	07/10/2025	45 GLEN LEA ROAD, PONTVILLE TAS 7030	CLASSIC	F-WDCYOR10CLASA	TO THE DRAFTING OFFICE.	/ersic
					SCALES:	71/2/1	late
			2 / - / 189251 BRIGHTON C	CALCULATIONS 9 / 23		714341	e di

90mm TIMBER EXTERNAL WALL	FRAMING
PLASTERBOARD INSIDE **20*18*	ARCHITRAVE
*****	20mm PACKING AS REQUIRED
	110mm TIMBER REVEAL AS PER BRADNAMS
80	SCREW FIX REVEAL BY CARPENTER AT 600mm CENTRES
	SELECTED ALUMINIUM
WALL WRAP(RED)	WINDOW FRAME
	FINE BEAD OF SEALANT
91	SILL
	BRICKWORK AS SELECTED
OUTSIDE	

STANDARD BRICK

 $26^{1}\,{}_{2}$

27¹₂

28¹₂

 29^{1}_{2}

30¹₂

34¹₂

VERTICAL GAUGE: 7 Courses to 600mm

FORMAT SIZE:

240x120x86mm

11¹₂

13¹ ₂

15¹ ₂

16¹ 2

17¹ 2

18¹ ₂

19¹ 2

201₂

22¹ 2

23¹ 2

24¹ 2

25¹₂

37¹ ₂

38¹ ₂

MANUFACTURING SIZE:

230x110x76mm

BRICKWORK DIMENSIONS Bricks per m² in wall = 48.5 approx.

FORMAT SIZE

240x120x86mn

2¹₂

5¹₂

6¹ ₂

7¹₂

81₂

SUBJECT TO NCC 2022 (1 MAY 2023) WATERPROOFING & PLUMBING

CONDENSATION MANAGEMENT

PLAN ACCEPTANCE BY OWNER									
DATE:									
DATE:									
WILL NOT BE ACCEPTED E HAS BEEN SIGNED									

SELECTED ROOFING ON BATTENS AS REQUIRED EAVE AS PER PLANS PITCHING POINT **BOTTOM CHORD** -PACKING AS REQUIRED TIMBER DROPPEI HEAD TRIMMER DROP OFF EAVE FRAMING AS REQUIRED--FIXINGS AS REQUIRED 31 x 18mm STORM MOULD (ALL CORNERS MUST BE MITREE -20mm PACKING AS REQUIRED WINDOW AS PER CONSTRUCTION PLANS AND TO GLAZING MANUFACTURER'S DETAIL OUTSIDE INSIDE FIXINGS AS REQUIRED BRICKWORK IN DISTANCE-WATER COMPENSATING APRON BY GLAZING MANUFACTURER FACTORY FITTED TIMBER REVEAL AS ER WINDOW MANUFACTURER'S DETAIL **WINDOW SILL** SILL TRIMMER RAKED SILL 20mm PACKING AS REQUIRED TIMBER FOR SUPPORT ABOVE 1200mm SPLIT BRICK-BY BUILDER FLASHING (ALCOR OR SIMILAR) TO SILL ONLY -PLASTERBOARD LINING WALL INSULATION AS PER **FFL SECTIONS** SCALE: 1:10

REFER TO SHEET 1 (COVER SHEET) FOR ALL BUILDING INFORMATION REGARDING: SUSTAINABILITY REQUIREMENTS GENERAL BUILDING INFORMATION

BAL-12.5 BUSHFIRE REQUIREMENTS SEE SHEET 1 (COVER SHEET) FOR DETAILS

> © 2025 WILSON HOMES PTY LTD (ABN 96 126 636 897). THIS DRAWING IS AN ORIGINAL ARTISTIC WORK WITHIN THE MEANING OF THE COPYRIGHT ACT 1968 (CTH). WILSON HOMES PTY LTD IS THE OWNER OF COPYRIGHT IN THIS DRAWING. YOU HEREBY AGREE AND UNDERTAKE THAT YOU WILL NOT IN ANY WAY REPRODUCE, COPY, MODIFY, USE OR TAKE ADVANTAGE OF THE DRAWING TO BUILD A HOUSE BASED ON THIS PLAN (WHETHER IN WHOLE OR IN PART) WITHOUT THE PRIOR WRITTEN CONSENT OF WILSON HOMES PTY LTD

	SPE
WILSON	COP
mirgail	COP
III	© 2
HUIIIES	

		THE THE STATE OF THE	2 2.3 13 23 ED / (11000E D/)	ALD SIX THIS I DIX (WHE THE KIN WHOLE SIX II THAT) W	 TOTAL TO THE CONTROLLE OF THE LIB.				∦ i⊑
SPECIFICATION:	REVISION	DRAWN	CLIENT:		HOUSE DESIGN:		HOUSE CODE:	DO NOT SCALE DRAWINGS, USE FIGURED DIMENSIONS ONLY. CHECK AND VERIFY DIMENSIONS AND LEVELS PRIOR TO THE COMMENCEMENT OF ANY WORK, ALL DISCREPANCIES TO BE REPORTED TO THE DRAFTING OFFICE.	
DISCOVERY	1 DRAFT SALE PLAN - CT1	HMI 12/09/2025	BENJAMIN ADAM SH	OOBRIDGE	YORK 14		H-WDCYOR10SA		140
COPYRIGHT:	2 DRAFT SALE PLAN - CT1 UPDATE	HMI 25/09/2025			FACADE DESIGN:				
© 2025	3 PRELIM PLANS - INITIAL ISSUE	KPH 07/10/2025	45 GLEN LEA ROAD,	PONTVILLE TAS 7030	CLASSIC		F-WDCYOR10CLASA		/ersic
			LOT / SECTION / CT:	COUNCIL:	SHEET TITLE:	SHEET No.:	SCALES:	71/2/1	late \
			2 / - / 189251	BRIGHTON	DETAILS (FACE BRICKWORK)	10 / 23		714341	Lemp

DETAILS


SCALE: 1:5

WHERE DOWNPIPES ARE FURTHER THAN 1.2m AWAY FROM VALLEY REFER TO N.C.C. 7.3.5(2)

POSITION AND QUALITY OF DOWNPIPES ARE NOT TO BE ALTERED WITHOUT CONSULTATION WITH DESIGNER.

AREA'S SHOWN ARE SURFACE AREAS/ CATCHMENT AREAS, NOT PLAN AREAS

Poofi	ng Data	
KOOII	IIY Dala	
	160.47	Flat Roof Area (excluding gutter and slope factor) (m²)
	174.33	Roof Surface Area (includes slope factor, excludes gutter) (m²)
Down	pipe roof	calculations (as per AS/NZA3500.3:2021)
Ah	170.02	Area of roof catchment (including 115mm Slotted Quad Gutter) (m²)
Ac	205.72	Ah x Catchment Area Multiplier for slope (Table 3.4.3.2 from AS/NZS 3500.3:2021) (1.21 for 23° pitch) (m²)
Ae	6300	Cross sectional area of 57 x 115 Slotted Quad Gutter (mm²)
DRI	83	Design Rainfall Intensity (determined from Table E1 from AS/NZS 3500.3:2021)
Acdp	64	Catchment area per Downpipe (determined from Figure 3.5(A) from AS/NZS 3500.3:2021) (m²)
Required Downpipes	3.2	Ac / Acdp
Downpipes Provided	5	

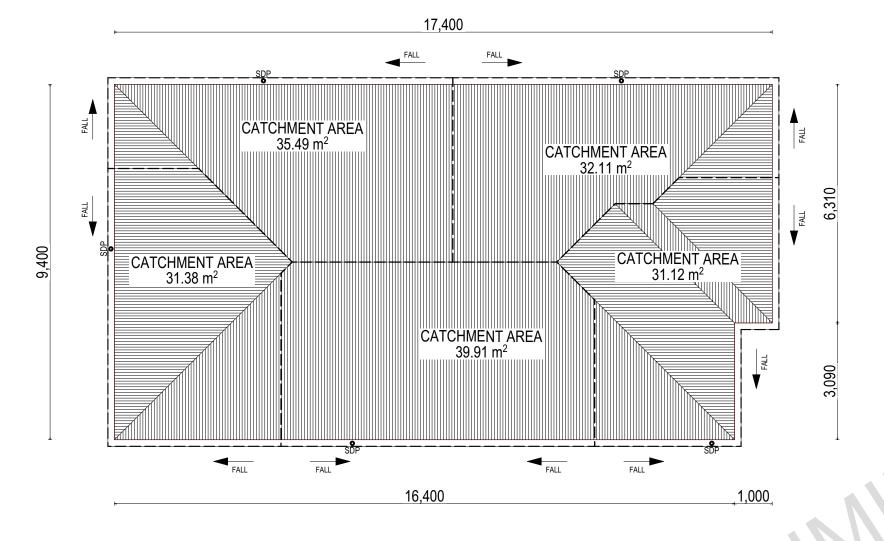

[EV] SOFFIT EAVE VENT PROPOSED LOCATION

SUBJECT TO NCC 2022 (1 MAY 2023)

WATERPROOFING & PLUMBING CONDENSATION MANAGEMENT

PLAN ACCEPTA	NCE BY OWNER		
SIGNATURE:	DATE:		
SIGNATURE:	DATE:		
PLEASE NOTE THAT VARIATI	ONS WILL NOT BE ACCEPTED		
AFTER THIS PLAN ACCEP	TANCE HAS BEEN SIGNED	į	

© 2025 WILSON HOMES PTY LTD (ABN 96 126 636 897). THIS DRAWING IS AN ORIGINAL ARTISTIC WORK WITHIN THE MEANING OF THE COPYRIGHT ACT 1968 (CTH). WILSON HOMES PTY LTD IS THE OWNER OF COPYRIGHT IN THIS DRAWING. YOU HEREBY AGREE AND UNDERTAKE THAT YOU WILL NOT IN ANY WAY REPRODUCE. COPY MODIEY LISE OR TAKE ADVANTAGE OF THE DRAWING TO BIJLID A HOUSE RASED ON THIS PLAN (WHETHER IN WHOLE OR IN PART) WITHOUT THE PRIOR WRITTEN CONSENT OF WILSON HOMES PTY LTD.

IJ	WILSON HOMES	
	HUHHLO	

		IN ANT WAT REI ROBOOL, GOT 1, WOBII 1, GOL OR TARE	ADVA	TIAGE OF T	TIE DIVAMINO TO BOILD A TIOCOL BACED O	ON THIS PLAN (WHETHER IN WHOLE OR IN PART) WITHOUT THE PRIOR WRITTEN	CONCENT OF WILCONTIONIEST IT ETD.		i	证
	SPECIFICATION:	REVISION		DRAWN	CLIENT:		HOUSE DESIGN:	HOUSE CODE:	DO NOT SCALE DRAWINGS, USE	
nn	DISCOVERY	1 DRAFT SALE PLAN - CT1	HMI	12/09/202	BENJAMIN ADAM SHOO	OBRIDGE	YORK 14	H-WDCYOR10SA	FIGURED DIMENSIONS ONLY. CHECK AND VERIFY DIMENSIONS AND	46
UII	COPYRIGHT:	2 DRAFT SALE PLAN - CT1 UPDATE			5 ADDRESS:		FACADE DESIGN:	FACADE CODE:	COMMENCEMENT OF ANY WORK. ALL	n: 24
\overline{C}	© 2025	3 PRELIM PLANS - INITIAL ISSUE	KPH	07/10/202	5 45 GLEN LEA ROAD, PO	NTVILLE TAS 7030	CLASSIC	F-WDCYOR10CLASA	DISCREPANCIES TO BE REPORTED TO THE DRAFTING OFFICE.	/ersic
\mathcal{S}					LOT / SECTION / CT:	COUNCIL:	SHEET TITLE:	SHEET No.: SCALES:	71/2/1	ate
					2 / - / 189251	BRIGHTON	ROOF DRAINAGE PLAN	11 / 23	714341	Temp

GENERAL BUILDING INFORMATION

FLOOR TILES SHOWN ON PLAN DO NOT INDICATE THE SIZE OR JOINT LOCATIONS OF THE ACTUAL FLOOR TILES.
TIMBER FLOORING SHOWN ON PLAN DOES NOT INDICATE THE BOARD SIZE OR DIRECTION OF THE ACTUAL FLOORING.

COVERINGS LEGEND

NO COVERING

COVER GRADE CONCRETE

CARPET

LAMINATE

TILE (STANDARD WET AREAS)

TILE (UPGRADED AREAS)

DECKING



BAL-12.5 BUSHFIRE REQUIREMENTS SEE SHEET 1 (COVER SHEET) FOR DETAILS

© 2025 WILSON HOMES PTY LTD (ABN 96 126 636 897). THIS DRAWING IS AN ORIGINAL ARTISTIC WORK WITHIN THE MEANING OF THE COPYRIGHT ACT 1968 (CTH). WILSON HOMES PTY LTD IS THE OWNER OF COPYRIGHT IN THIS DRAWING. YOU HEREBY AGREE AND UNDERTAKE THAT YOU WILL NOT IN ANY WAY REPRODUCE, COPY, MODIFY, USE OR TAKE ADVANTAGE OF THE DRAWING TO BUILD A HOUSE BASED ON THIS PLAN (WHETHER IN WHOLE OR IN PART) WITHOUT THE PRIOR WRITTEN CONSENT OF WILSON HOMES PTY LTD.

	SF
WILSON	D
mir9011	CC
IIOMEC	C
HOMES	


											_
SPECIFICATION:	REVISION		DRAWN	CLIENT:	_	 HOUSE DESIGN:			HOUSE CODE:	DO NOT SCALE DRAWINGS, USE	
DISCOVERY	1 DRAFT SALE PLAN - CT1	НМІ	12/09/2025	BENJAMIN ADAM SHO	OOBRIDGE	YORK 14			H-WDCYOR10SA	FIGURED DIMENSIONS ONLY. CHECK AND VERIFY DIMENSIONS AND LEVELS PRIOR TO THE	.041
COPYRIGHT:	2 DRAFT SALE PLAN - CT1 UPDATE	НМІ	25/09/2025	ADDRESS:		FACADE DESIGN:			FACADE CODE:	COMMENCEMENT OF ANY WORK. AL	
© 2025	3 PRELIM PLANS - INITIAL ISSUE	KPH	07/10/2025	45 GLEN LEA ROAD, F	ONTVILLE TAS 7030	CLASSIC			F-WDCYOR10CLASA	DISCREPANCIES TO BE REPORTED TO THE DRAFTING OFFICE.	/ersio
				LOT / SECTION / CT:	COUNCIL:	SHEET TITLE:	5	SHEET No.:	SCALES:	744944	ate
				2 / - / 189251	BRIGHTON	FLOOR COVERINGS	-	12 / 23	1:100	714341	dwe

PLAN ACCEPT	ANCE BY OWNER
SIGNATURE:	DATE:
SIGNATURE:	DATE:
	TIONS WILL NOT BE ACCEPTED EPTANCE HAS BEEN SIGNED

REFER TO SHEET 1 (COVER SHEET) FOR ALL BUILDING INFORMATION REGARDING: SUSTAINABILITY REQUIREMENTS

SITE CLASSIFICATION GENERAL BUILDING INFORMATION

DETAILS DEPICTED ON THIS SHEET ARE A REPRESENTATION ONLY. JOINER MAY ADJUST CABINETRY AS REQUIRED.

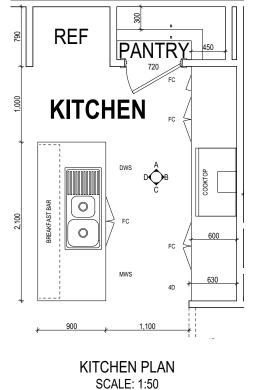

SUBJECT TO NCC 2022 (1 MAY 2023)

WATERPROOFING & PLUMBING CONDENSATION MANAGEMENT

PLAN ACCEPTANCE BY OWNER SIGNATURE: DATE: SIGNATURE: DATE: PLEASE NOTE THAT VARIATIONS WILL NOT BE ACCEPTED AFTER THIS PLAN ACCEPTANCE HAS BEEN SIGNED

ALL DIMENSIONS ARE FRAME DIMENSIONS


© 2025 WILSON HOMES PTY LTD (ABN 96 126 636 897). THIS DRAWING IS AN ORIGINAL ARTISTIC WORK WITHIN THE MEANING OF THE COPYRIGHT ACT 1968 (CTH), WILSON HOMES PTY LTD IS THE OWNER OF COPYRIGHT IN THIS DRAWING. YOU HEREBY AGREE AND UNDERTAKE THAT YOU WILL NOT IN ANY WAY REPRODUCE, COPY, MODIFY, USE OR TAKE ADVANTAGE OF THE DRAWING TO BUILD A HOUSE BASED ON THIS PLAN (WHETHER IN WHOLE OR IN PART) WITHOUT THE PRIOR WRITTEN CONSENT OF WILSON HOMES PTY LTD.

			15 17 11 17 10 2 0	THE BITTOM TO BOILD THIO OOL BRIDED O	31. THE TELL (THE THE THE TELL OF THE THE TELL OF THE THE TELL OF	5.102.11 01 11200111011120111 2.15.		
								•
	SPECIFICATION:	REVISION	DRAWN	CLIENT:		HOUSE DESIGN:		HOUSE CODE:
	DISCOVERY	1 DRAFT SALE PLAN - CT1	HMI 12/09/:	BENJAMIN ADAM SHOC	BRIDGE	YORK 14		H-WDCYOR10SA
I WILSUII	COPYRIGHT:			2025 ADDRESS:		FACADE DESIGN:		FACADE CODE:
IIOMEC	© 2025	3 PRELIM PLANS - INITIAL ISSUE	KPH 07/10/.	45 GLEN LEA ROAD, PO	NTVILLE TAS 7030	CLASSIC		F-WDCYOR10CLASA
HUIIIE 3				LOT / SECTION / CT:	COUNCIL:	SHEET TITLE:	SHEET No.:	SCALES:
				2 / - / 189251	BRIGHTON	KITCHEN DETAILS	13 / 23	1:50

DO NOT SCALE DRAWINGS, USE FIGURED DIMENSIONS ONLY. CHECK AND VERIFY DIMENSIONS AND LEVELS PRIOR TO THE COMMENCEMENT OF ANY WORK. AL DISCREPANCIES TO BE REPORTED TO THE DRAFTING OFFICE. 714341

REFER TO SHEET 1 (COVER SHEET) FOR ALL BUILDING INFORMATION REGARDING: SUSTAINABILITY REQUIREMENTS SITE CLASSIFICATION

DETAILS DEPICTED ON THIS SHEET ARE A REPRESENTATION ONLY

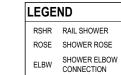

HT

WS

TRH

TH

RH

SHLF SHELF

RSHR RAIL SHOWER

MIX MIXER TAP

HS HOB SPOUT

HOT TAP CT COLD TAP

WALL SPOUT SC STOP COCK

TR-S TOWEL RAIL - SINGLE

TR-D TOWEL RAIL - DOUBLE


TOWEL HOLDER TR TOWEL RACK TMB TUMBLER HOLDER RNG TOWEL RING

ROBE HOOK


SR SHAMPOO RECESS SOAP SOAP HOLDER

TL TOWEL LADDER


TOILET ROLL HOLDER

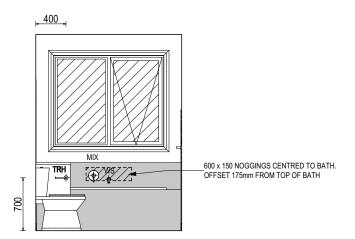

ELEVATION A SCALE: 1:50

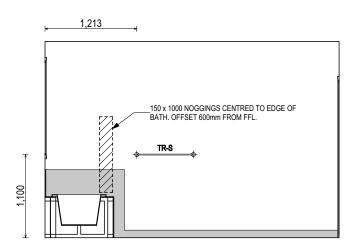

ELEVATION B SCALE: 1:50

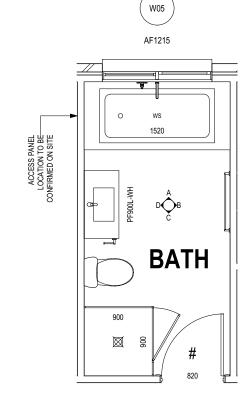


BATHROOM PLAN SCALE: 1:50

SHAMPOO	RECESS SIZE	STRUCTUR	AL DIMENSIONS	
		WIDTH	HEIGHT	
"SMALL"	470 x 380mm	548mm	446mm	
"MEDIUM"	800 x 380mm	878mm	446mm	
"LARGE"	1500 x 380mm	1578mm	446mm	
	SON HOMES' DE ETAIL PRIOR TO			


SUBJECT TO NCC 2022 (1 MAY 2023)

WATERPROOFING & PLUMBING CONDENSATION MANAGEMENT

PLAN ACCEPTA	ANCE BY OWNER
SIGNATURE:	DATE:
SIGNATURE:	DATE:
PLEASE NOTE THAT VARIA	TIONS WILL NOT BE ACCEPTED

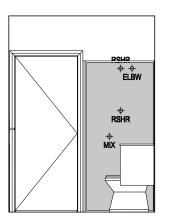

ELEVATION C SCALE: 1:50

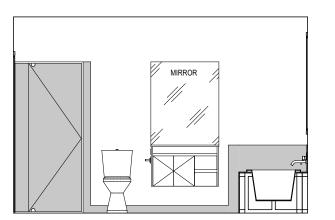

ELEVATION D SCALE: 1:50


ALL DIMENSIONS ARE FRAME DIMENSIONS

© 2025 WILSON HOMES PTY LTD (ABN 96 126 636 897). THIS DRAWING IS AN ORIGINAL ARTISTIC WORK WITHIN THE MEANING OF THE COPYRIGHT ACT 1968 (CTH), WILSON HOMES PTY LTD IS THE OWNER OF COPYRIGHT IN THIS DRAWING, YOU HEREBY AGREE AND UNDERTAKE THAT YOU WILL NOT IN ANY WAY REPRODUCE, COPY, MODIFY, USE OR TAKE ADVANTAGE OF THE DRAWING TO BUILD A HOUSE BASED ON THIS PLAN (WHETHER IN WHOLE OR IN PART) WITHOUT THE PRIOR WRITTEN CONSENT OF WILSON HOMES PTY LTD.




			Design of the Brown of the Brow	NO GOLDEN G. MEGOTTI GINEOTTI ETD.		
	SPECIFICATION:	REVISION	DRAWN CLIENT:	HOUSE DESIGN:	HOUSE CODE: DO NOT SCALE DRAWINGS, USE	
\cap	DISCOVERY	1 DRAFT SALE PLAN - CT1	HMI 12/09/2025 BENJAMIN ADAM SHOOBRIDGE	YORK 14	H-WDCYOR10SA FIGURED DIMENSIONS ONLY. CHEC	½ 5
ш	COPYRIGHT:	2 DRAFT SALE PLAN - CT1 UPDATE	HMI 25/09/2025 ADDRESS:	FACADE DESIGN:	FACADE CODE: LEVELS PRIOR TO THE COMMENCEMENT OF ANY WORK. A	
	© 2025	3 PRELIM PLANS - INITIAL ISSUE	KPH 07/10/2025 45 GLEN LEA ROAD, PONTVILLE TAS 7030	CLASSIC	F-WDCYOR10CLASA DISCREPANCIES TO BE REPORTED TO THE DRAFTING OFFICE.	/ersio
			LOT / SECTION / CT: COUNCIL:	SHEET TITLE: SHEET No.:	SCALES: 711011	ate \
			2 / - / 189251 BRIGHTON	BATHROOM DETAILS 14 / 23	1:50 714341	emp


ELEVATION A SCALE: 1:50

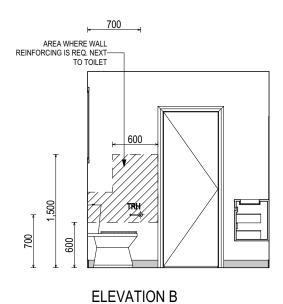

SCALE: 1:50

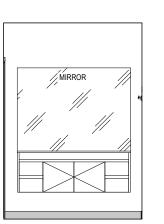

ELEVATION C SCALE: 1:50

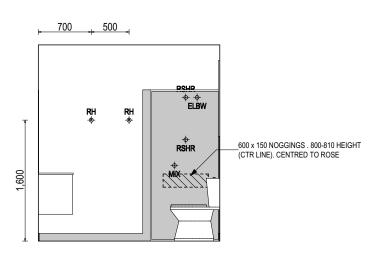

ELEVATION D SCALE: 1:50

REFER TO THE FOLLOWING DETAILS:

VANITY DETAILS G-VANI-001
WINDOW OVER BATH HOB D-WIND-ALU001 STANDARD BATH HOB D-WETA-BATH003
WET AREA TILING LAYOUTS D-WETA-TILE002 SQUARE SET WINDOWS G-WIND-SSET02 FULL HEIGHT TILING D-LINI-WETA

REFER TO SHEET 1 (COVER SHEET) FOR ALL BUILDING INFORMATION REGARDING: SUSTAINABILITY REQUIREMENTS SITE CLASSIFICATION GENERAL BUILDING INFORMATION

DETAILS DEPICTED ON THIS SHEET ARE A REPRESENTATION ONLY

RSHR RAIL SHOWER

ROSE SHOWER ROSE SHOWER ELBOW ELBW CONNECTION MIX MIXER TAP

HOT TAP

WALL SPOUT

ROBE HOOK

SR SHAMPOO RECESS

SOAP SOAP HOLDER

TOILET ROLL HOLDER TR-S TOWEL RAIL - SINGLE TR-D TOWEL RAIL - DOUBLE TL TOWEL LADDER TH TOWEL HOLDER TR TOWEL RACK TMB TUMBLER HOLDER RNG TOWEL RING

CT COLD TAP

HS HOB SPOUT

SC STOP COCK

LEGEND


HT

WS

TRH

RH

SHLF SHELF

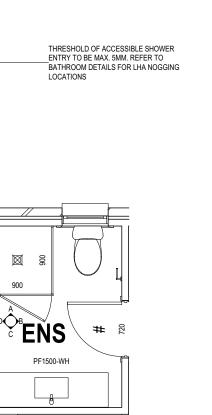

ENSUITE PLAN SCALE: 1:50

SHAMPOO	RECESS SIZE	STRUCTU	RAL DIMENSIONS
"SMALL" "MEDIUM"	470 x 380mm 800 x 380mm	WIDTH 548mm 878mm	HEIGHT 446mm 446mm
"LARGE"	1500 x 380mm	1578mm	446mm
	SON HOMES' DE ETAIL PRIOR TO		

SUBJECT TO NCC 2022 (1 MAY 2023)

WATERPROOFING & PLUMBING CONDENSATION MANAGEMENT

PLAN ACCEPTANCE BY OWNER						
SIGNATURE:	DATE:					
SIGNATURE:	DATE:					
	TIONS WILL NOT BE ACCEPTED					

ALL DIMENSIONS ARE FRAME DIMENSIONS

© 2025 WILSON HOMES PTY LTD (ABN 96 126 636 897). THIS DRAWING IS AN ORIGINAL ARTISTIC WORK WITHIN THE MEANING OF THE COPYRIGHT ACT 1968 (CTH). WILSON HOMES PTY LTD IS THE OWNER OF COPYRIGHT IN THIS DRAWING. YOU HEREBY AGREE AND UNDERTAKE THAT YOU WILL NOT IN ANY WAY REPRODUCE, COPY, MODIFY, USE OR TAKE ADVANTAGE OF THE DRAWING TO BUILD A HOUSE BASED ON THIS PLAN (WHETHER IN WHOLE OR IN PART) WITHOUT THE PRIOR WRITTEN CONSENT OF WILSON HOMES PTY LTD.




		morar managed and make more and make make make make make make make make	715 17 11 1		T DI TITILITA TO DOILD / TITOGGL B/ 1025 C	or mio i 2 m (mi2 m2 mm)		CHOCKET OF THEODITIONS OF THE ETD.				iΣ
	SPECIFICATION:	REVISION	Г	DRAWN	CLIENT:			HOUSE DESIGN:		HOUSE CODE:	DO NOT SCALE DRAWINGS, USE	1
\cap	DISCOVERY	1 DRAFT SALE PLAN - CT1	НМІ	12/09/2025	BENJAMIN ADAM SHOO	DBRIDGE		YORK 14		H-WDCYOR10SA	FIGURED DIMENSIONS ONLY. CHECK AND VERIFY DIMENSIONS AND LEVELS PRIOR TO THE	.04
П	COPYRIGHT:	2 DRAFT SALE PLAN - CT1 UPDATE	НМІ	25/09/2025	ADDRESS:			FACADE DESIGN: CLASSIC			COMMENCEMENT OF ANY WORK. ALL	
	© 2025	3 PRELIM PLANS - INITIAL ISSUE	KPH	07/10/2025	45 GLEN LEA ROAD, PO					F-WDCYOR10CLASA	DISCREPANCIES TO BE REPORTED TO THE DRAFTING OFFICE.	/ersic
		,				COUNCIL:		SHEET TITLE:	SHEET No.:	SCALES:	74.49.44	late \
		,			2 / - / 189251	BRIGHTON		ENSUITE DETAILS	15 / 23	1:50	714341	e e


- SITE CLASSIFICATION
- GENERAL BUILDING INFORMATION

DETAILS DEPICTED ON THIS SHEET ARE A REPRESENTATION ONLY


PROVIDE ADDITIONAL NOGGING TO LAUNDRY FOR FIXING OF WALL MOUNTED CLOTHES DRYER AS PER D-FRAM-ELEC006

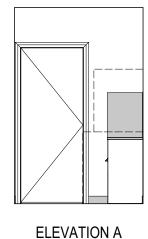


SCALE: 1:50

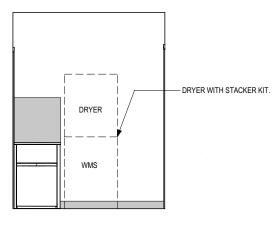


ELEVATION B SCALE: 1:50

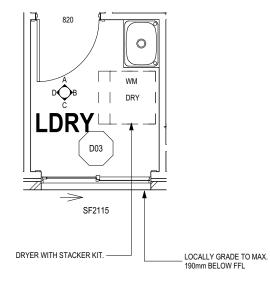

AUNDRY PLAN

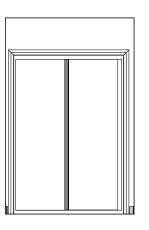

ELEVATION C SCALE: 1:50

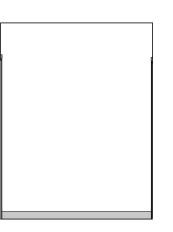

ELEVATION D SCALE: 1:50

SUBJECT TO NCC 2022 (1 MAY 2023)

WATERPROOFING & PLUMBING CONDENSATION MANAGEMENT

PLAN ACCEPTAN	NCE BY OWNER)
SIGNATURE:	DATE:	
SIGNATURE:	DATE:	
PLEASE NOTE THAT VARIATIO	NS WILL NOT BE ACCEPTED	
AFTER THIS PLAN ACCEPT	ANCE HAS BEEN SIGNED) [

ALL DIMENSIONS ARE FRAME DIMENSIONS

© 2025 WILSON HOMES PTY LTD (ABN 96 126 636 897). THIS DRAWING IS AN ORIGINAL ARTISTIC WORK WITHIN THE MEANING OF THE COPYRIGHT ACT 1968 (CTH). WILSON HOMES PTY LTD IS THE OWNER OF COPYRIGHT IN THIS DRAWING. YOU HEREBY AGREE AND UNDERTAKE THAT YOU WILL NOT IN ANY WAY REPRODUCE, COPY, MODIFY, USE OR TAKE ADVANTAGE OF THE DRAWING TO BUILD A HOUSE BASED ON THIS PLAN (WHETHER IN WHOLE OR IN PART) WITHOUT THE PRIOR WRITTEN CONSENT OF WILSON HOMES PTY LTD.





_				510 WINTO 10 DOIED / WINDOOL D/ WELD 0		.,	00.102.11 0. 11.200.11.10201 1. 2.15.					正
_	SPECIFICATION:	REVISION	DRAWN CI	CLIENT:			HOUSE DESIGN:			HOUSE CODE:	DO NOT SCALE DRAWINGS, USE	
1	DISCOVERY	1 DRAFT SALE PLAN - CT1	HMI 12/09/2025 F	BENJAMIN ADAM SHOO	BRIDGE		YORK 14			H-WDCYOR10SA	FIGURED DIMENSIONS ONLY. CHECK AND VERIFY DIMENSIONS AND LEVELS PRIOR TO THE	1.04
	COPYRIGHT:	I I		II 25/09/2025 ADDRESS:			FACADE DESIGN:				COMMENCEMENT OF ANY WORK. ALL DISCREPANCIES TO BE REPORTED	on: 2
	© 2025	3 PRELIM PLANS - INITIAL ISSUE	KPH 07/10/2025 4	45 GLEN LEA ROAD, PONTVILLE TAS 7030			CLASSIC			F-WDCYOR10CLASA	TO THE DRAFTING OFFICE.	Versi
					COUNCIL:		SHEET TITLE:		SHEET No.:		714341	olate
			2	2 / - / 189251	BRIGHTON		LAUNDRY DETAILS		16 / 23	1:50	, <i>1</i> 14341	emi

nplate Version: 24.041 File Location: D:\OneDrive - MiTek

STANDARD SHOWER & WATERPROOFING DETAIL

- ALL PLANS ARE DIAGRAMATIC, REFER TO THE CONSTRUCTION PLANS FOR THE BATHROOM & SHOWER LAYOUTS.
- DO NOT SILICON THE BOTTOM OF THE FRAME ON THE SHOWER SIDE.

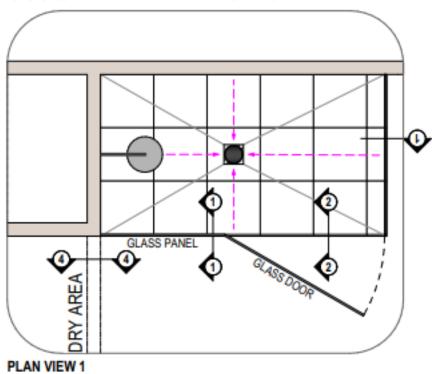

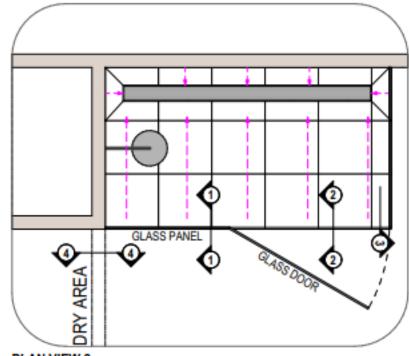

SOND BREAKER

GOOD REVEAL TO BE CUT AROUND THE WATERSTOP (STANDARD) SCALE: 12 **BATHROOM AREA** DRY AREA SQUARE SET OPENING 12x20mm ALUMINUM WATERSTOP ANGLE-DOTING MEMBRANE CONTINUOUS WATER SELECTED TILES-ADHESIVE LAYER BETWEEN TILE AND SLAB-SECTION 04-I (UPGRADE) SCALE: 1:2

SHOWER SCREEN

SHOWER SCREEN FRAME

SCREED BEDDING

SECTION 03 - THROUGH GLASS SCREEEN

SCALE: 1:2

DOOR LEAF

DOOR FRAME REVEAL

DRY AREA

SELECTED FLOORING

BATHROOM AREA

IF NECESSARY)

12x20mm MATCHING COVER ANGLE OVER

ADHESIVE LAYER BETWEEN TILE AND SLAB

SELECTED BATHROOM FLOOR

TILES, DIRECT STICK TO SLAB

CONCRETE SLAB TO ENGINEER'S DETAIL:

TOP/OUT TO FOLLOW SCREED FALL


SECTION 04-

BATHROOM AREA


SELECTED TILES-

12:20mm ALUMINIUM WATERSTOP ANGLE-CONTINUOUS WATERPROOFING MEMBRANE

(STANDARD FW)

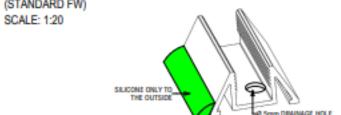

PLAN VIEW 2 (CHANNEL DRAIN) SCALE: 1:20

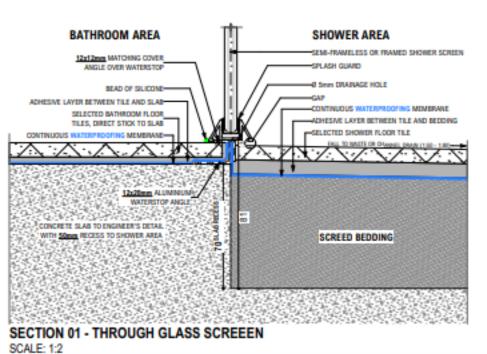


BATHROOM AREA SHOWER AREA SHOWER GLASS DOOR 12x12mm MATCHING COVER GLASS DOOR SPLASH GUARD ANGLE OVER WATERSTOP CONTINUOUS WATERPROOFING MEMBRANE ADHESIVE LAYER BETWEEN TILE AND SLAB-SELECTED BATHROOM FLOOR OHESIVE LAYER BETWEEN TILE AND BEDOING TILES, DIRECT STICK TO SLAB SELECTED SHOWER FLOOR TILE WATERSTOP ANGLE WITH 50mm RECESS TO SHOWER AREA SCREED BEDDING

SECTION 02 - THROUGH GLASS DOOR SCALE: 1:2

© 2025 WILSON HOMES PTY LTD (ABN 96 126 636 897). THIS DRAWING IS AN ORIGINAL ARTISTIC WORK WITHIN THE MEANING OF THE COPYRIGHT ACT 1968 (CTH). WILSON HOMES PTY LTD IS THE OWNER OF COPYRIGHT IN THIS DRAWING. YOU HEREBY AGREE AND UNDERTAKE THAT YOU WILL NOT IN ANY WAY REPRODUCE CODY, MODIEY LISE OR TAKE ADVANTAGE OF THE DRAWING TO RUIL DIA HOUSE RASED ON THIS DIAM (WHETHER IN WHOLE OR IN PART) WITHOUT THE PRIOR WRITTEN CONSENT OF WILSON HOMES PTYLLT





					· · · · · · · · · · · · · · · · · · ·			
SPECIFICATION:		REVISION	-	DRAWN	CLIENT:	HOUSE DESIGN:	HOUSE CODE:	DO NOT SCALE DRAWINGS, USE
DISCOVERY	1 Г	DRAFT SALE PLAN - CT1	НМІ	12/09/2025	BENJAMIN ADAM SHOOBRIDGE	YORK 14	H-WDCYOR10SA	FIGURED DIMENSIONS ONLY. CHECK AND VERIFY DIMENSIONS AND
COPYRIGHT:	2 [DRAFT SALE PLAN - CT1 UPDATE	HMI	25/09/2025	ADDRESS:	FACADE DESIGN:	FACADE CODE:	LEVELS PRIOR TO THE COMMENCEMENT OF ANY WORK. ALL
© 2025	3 F	PRELIM PLANS - INITIAL ISSUE	KPH	07/10/2025	45 GLEN LEA ROAD, PONTVILLE TAS 7030	CLASSIC	F-WDCYOR10CLASA	DISCREPANCIES TO BE REPORTED TO THE DRAFTING OFFICE.
					LOT / SECTION / CT: COUNCIL:	SHEET TITLE:	SHEET No.: SCALES:	744944
					2 / - / 189251 BRIGHTON	STANDARD SHOWER & WATERPROOFING	17 / 23	714341

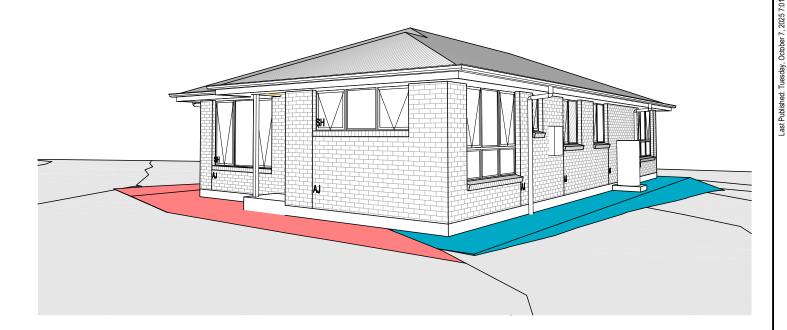

FRONT RIGHT

FRONT LEFT

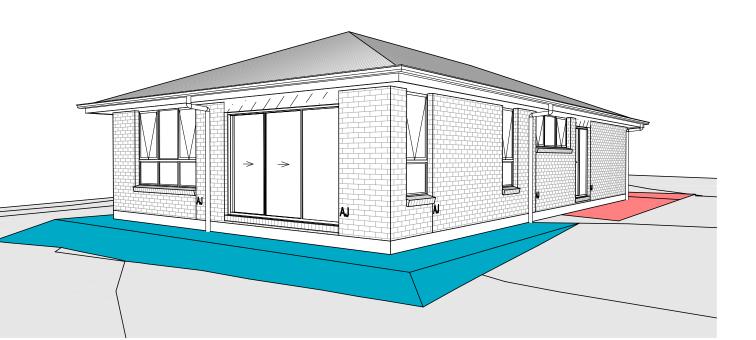

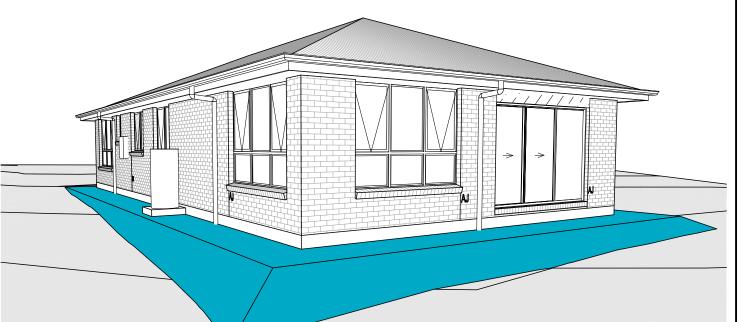

REAR LEFT

REAR RIGHT

SUBJECT TO NCC 2022 (1 MAY 2023)

WATERPROOFING & PLUMBING CONDENSATION MANAGEMENT

PLAN ACCEPTANCE BY OWNER

THIS PLAN HAS BEEN DRAWN TO REFLECT YOUR
CONSOLIDATED TENDER. PLEASE CHECK THAT EVERYTHING
IS CORRECT AND FINALISED. FURTHER STRUCTURAL
CHANGES ARE NOT POSSIBLE PAST THIS POINT.
PLEASE NOTE, SELECTIONS ITEMS WILL NOT APPEAR ON
YOUR PLANS UNTIL AFTER YOUR INTERNAL COLOUR
SELECTIONS APPOINTMENT IS COMPLETE.

GNATURE:	DATE:

SIGNATURE: DATE:

NOTE: SITE LEVELS AND SETBACKS SHOWN ARE INDICATIVE ONLY AND SUBJECT TO A FINAL CONTOUR SURVEY AND REGISTERED REPORTS BEING COMPLETED. 3D IMAGES ARE FOR ILLUSTRATIVE PURPOSES ONLY AND ARE SUBJECT TO CHANGE.

© 2025 WILSON HOMES PTY LTD (ABN 96 126 636 897). THIS DRAWING IS AN ORIGINAL ARTISTIC WORK WITHIN THE MEANING OF THE COPYRIGHT ACT 1968 (CTH), WILSON HOMES PTY LTD IS THE OWNER OF COPYRIGHT IN THIS DRAWING. YOU HEREBY AGREE AND UNDERTAKE THAT YOU WILL NOT IN ANY WAY REPRODUCE, COPY, MODIFY, USE OR TAKE ADVANTAGE OF THE DRAWING TO BUILD A HOUSE BASED ON THIS PLAN (WHETHER IN WHOLE OR IN PART) WITHOUT THE PRIOR WRITTEN CONSENT OF WILSON HOMES PTY LTD.

	1
IIIII COO	
WILSON	1
HNMES	(
ПППЕЭ	

	$\overline{}$		$\overline{}$	$\overline{}$, , , , , , , , , , , , , , , , , , , ,			
SPECIFICATION:		REVISION		DRAWN	CLIENT:	HOUSE DESIGN:	HOUSE CODE:	DO NOT SCALE DRAWINGS, USE FIGURED DIMENSIONS ONLY, CHECK
DISCOVERY	1	DRAFT SALE PLAN - CT1	НМІ	12/09/2025	BENJAMIN ADAM SHOOBRIDGE	YORK 14	H-WDCYOR10SA	AND VERIFY DIMENSIONS AND LEVELS PRIOR TO THE
COPYRIGHT:	2	DRAFT SALE PLAN - CT1 UPDATE	HMI	25/09/2025	, ADDRESS:	FACADE DESIGN:	FACADE CODE:	COMMENCEMENT OF ANY WORK. ALL
© 2025	3	PRELIM PLANS - INITIAL ISSUE	KPH	07/10/2025	5 45 GLEN LEA ROAD, PONTVILLE TAS 7030	CLASSIC	F-WDCYOR10CLASA	DISCREPANCIES TO BE REPORTED TO THE DRAFTING OFFICE.
					LOT / SECTION / CT: COUNCIL:	SHEET TITLE:	SHEET No.: SCALES:	711211
					2 / - / 189251 BRIGHTON	3D VIEWS	18 / 23	714341

- BUILDER TO VERIFY ALL DIMENSIONS AND LEVELS ON SITE PRIOR TO COMMENCEMENT OF WORK
- ALL WORK TO BE CARRIED OUT IN ACCORDANCE WITH THE NATIONAL CONSTRUCTION CODE (NCC)
- INTERNAL DIMENSIONS ARE TO WALL FRAMING ONLY AND DO NOT INCLUDE WALL LININGS

SITE WORKS

GENERAL

- CUT AND FILL BATTERS ARE INDICATIVE ONLY. BATTER TO COMPLY WITH THE NCC TABLE 3.2.1
- ALL CUTS AND FFL'S SHOWN (DA DRAWINGS) ARE SUBJECT TO ENGINEERING ADVICE ONCE À SATISFACTORY SOIL TEST HAS BEEN RECEIVED AND REVIEWED
- ALL EMBANKMENTS THAT ARE LEFT EXPOSED MUST BE STABILISED WITH VEGETATION OR SIMILAR TO PREVENT
- EMBANKMENTS CANNOT EXCEED 2.0m IN HEIGHT WITHOUT THE AID OF RETAINING WALLS OR OTHER APPROVED TYPES OF SOIL RETAINING METHODS
- ALL UNPROTECTED EMBANKMENTS MUST COMPLY WITH THE SLOPE RATIOS FOR SOIL TYPE IN TABLE 3.2.1 OF THE NCC

SOIL TYPE /	EMBANKMENT (OF SLOPE
CLASSIFICATION	COMPACTED FILL	CUT
STABLE ROCK (A)	3:3	8:1
SAND (A)	1:2	1:2
SILT (P)	1:4	1:4
FIRM CLAY	1:2	1:1
SOFT CLAY	NOT SUITABLE	2:3
SOFT SOILS (P)	NOT SUITABLE	NOT SUITABLE

MASONRY

- ALL MASONRY TO BE CONSTRUCTED IN ACCORDANCE WITH AS3700
- EXTERNAL WALLS TO BE 110mm BRICKWORK UNLESS NOTED OTHERWISE
- MORTAR MIXED @ 1:1:6 CEMENT:LIME:SAND UNLESS STATED OTHERWISE BY ENGINEER
- DAMP-PROOF COURSE IN ALL PERIMETER WALLS CUT INTO EXTERNAL WALLS BELOW FLOOR LEVEL WITH WEEP HOLES @ 1200 CTRS IN ACCORDANCE WITH AS2904
- VERTICAL ARTICULATION JOINTS TO BE PROVIDED @ 6m MAX. CTRS FOR UNREINFORCED MASONARY WALLS EXCEPT WHERE BUILT ON CLASS A OR S SOIL AND SPACED AS PER AS3700 SECTION 12.6.4. WILSON HOMES REQUEST THAT @ 5M
- WHERE NECESSARY, STEEL LINTELS ARE TO BE PROVIDED IN ACCORDANCE WITH AS4100 AND AS3700a

TIMBER FRAMING

- ALL WORK TO BE CARRIED OUT IN ACCORDANCE WITH THE CURRENT NCC
- ALL TIMBER FRAMING TO BE CARRIED OUT IN ACCORDANCE **WITH AS1684**
- MGP10 PINE FRAMING OR F17 SOLID AND FINGER JOINED FRAMING TO ALL STRUCTURAL COMPONENTS. 90 x 35mm FRAMING TO INTERNAL AND EXTERNAL WALLS. TIMBER COMPOSITE ENGINEERED ROOF TRUSSES WITH HARDWOOD AND MGP COMPONENTS
- GALVANISED WALL TIES TO MASONRY @ 450 CTRS HORIZONTALLY AND 600 CTRS VERTICALLY, WITH SPACING REDUCED BY 50% AROUND OPENINGS

BRACING / LINTELS

- WALL BRACING AS PER AS1684-2 2021 AND AS1170 WIND
- WALL BRACING AS SHOWN ON PLAN IS A MINIMUM ONLY. BUILDER TO PROVIDE ADDITIONAL BRACING TO SUIT THE CONSTRUCTION OF WALL FRAMES IN ACCORDANCE WITH GOOD BUILDING PRACTICE.
- PLYWOOD BRACING IN ACCORDANCE WITH AS1684 TABLE 8.18 (H) METHOD B. 900 WIDE SHEET PLY BRACING PANELS (6mm THICK F11 OR 4mm THICK F14) TO BE FIXED TO STUD FRAME WITH 2.8mm DIA x 30mm LONG MIN. FLAT HEAD NAILS.
- 65 x 19mm HW DIAGONAL TIMBER BRACING CHECKED INTO STUDS AND FIXED IN ACCORDANCE WITH AS1684

TIMBER LINTELS FOR SINGLE (OR UPPER STORY) TO BE F17 HARDWOOD AS FOLLOWS:

0 - 1500 120 x 35 1500 - 2400 140 x 35 2400 - 2700 190 x 35

TIEDOWN AND FIXING CONNECTIONS TO COMPLY WITH AS1684

STEEL LINTELS FOR SINGLE (OR UPPER STOREY) TO BE AS FOLLOWS:

0 - 2700 90 x 90 x 6 EA 2700 - 3200 100 x 100 x 8 EA 3200 - 4000 150 x 90 x 8 EA

*LINTELS REQUIRE 150mm BEARING EITHER SIDE OF OPENING

ALL LINTEL SIZES SHOWN ARE SUBJECT TO ENGINEERS DETAILS

CONCRETE

- CONCRETE FOOTING AND SLABS TO BE IN ACCORDANCE WITH AS2870
- CONCRETE TO BE MANUFACTURED TO COMPLY WITH AS3600 AND:
- HAVE A STRENGTH @ 28 DAYS OF NOT LESS THAN 25MpA (N25 GRADE)
- HAVE A 20mm NOMINAL AGGREGATE SIZE
- HAVE A NOMINAL 80mm SLUMP
- CONCRETE SLAB TO BE LAID OVER 0.2mm POLYTHENE MEMBRANE, 50mm WELL BEDDED SAND AND MINIMUM COMPACTED FCR (20mm)
- SLAB THICKNESS AND REINFORCEMENT TO BE AS PER ENGINEERS DESIGN

WINDOWS

- WINDOWS TO BE ALUMINIUM FRAMED SLIDING UNLESS NOTED OTHERWISE
- ALL WINDOWS TO BE FABRICATED AND INSTALLED IN ACCORDANCE WITH AS1288 AND AS2047 TO SPECIFIC WIND SPEED AS PER ENGINEERS REPORT
- ALL OPENING WINDOWS TO COMPLY WITH NCC 8 **REQUIREMENTS**
- AS PER NCC 11.3.6 ALL BEDROOM WINDOWS WHERE THE LOWEST OPENABLE PORTION OF THE WINDOW IS WITHIN 1.7m OF FFL AND THE FFL IS 2m OR MORE ABOVE NGL. REQUIRE A PERMANANTLY FIXED DEVICE RESTRICTING ANY OPENINGS OF THE WINDOW OR SCREEN SO THAT A 125mm SPHERE CANNOT PASS THROUGH: AND RESISTING OUTWARDS HORIZONTAL ACTION OF 250N AGAINST THE WINDOW. WHERE THE DEVICE OR SCREEN CAN BE REMOVED, UNLOCKED OR OVER-RIDDEN, THE DEVICE OR SCREEN MUST HAVE A CHILD RESISTANT RELEASE MECHANISM INSTALLED AND BARRIER BELOW THE WINDOW THAT IS 865mm HIGH ABOVE FFL AND RESTRICTS ANY OPENING WITHIN THE BARRIER SO THAT A 125mm SPHERE CANNOT PASS THROUGH, AND HAS NO HORIZONTAL OR NEAR HORIZONTAL ELEMENTS BETWEEN 150mm AND 760mm FROM FFL.
- GLAZING INSTALLED IN AREAS WITH HIGH POTENTIAL FOR **HUMAN IMPACT TO COMPLY WITH NCC PART 8.4**

DRAINAGE / WATER

- DRAINAGE TO BE DESIGNED AND CONSTRUCTED IN ACCORDANCE WITH AS3500 AND LOCAL AUTHORITY
- STORMWATER PIPES TO BE UPVC CLASS HD
- SEWER PIPES TO BE UPVC CLASS SH
- PROVIDE Ø20mm K2 POLYETHYLENE WATER RETICULATION
- TYPE B STOP VALVE TO BE LOCATED ADJACENT TO ENTRY
- BACKFILL ALL TRENCHES BENEATH VEHICLE PAVEMENT AND SLABS ON GRADE TO FULL DEPTH WITH 20 FCR
- PROVIDE OVERFLOW RELIEF GULLY WITH TAP OVER. INVERT LEVEL TO BE 150 MIN. BELOW LOWEST SANITARY DRAINAGE POINT
- CUT AND BATTER ARE INDICATIVE. BATTER TO COMPLY WITH CURRENT NCC TABLE 3.1.1.1
- AG DRAIN REQUIRED AROUND PERIMETER OF DWELLING FOR ALL CLASS M, H, E SITES. LOCATE AG DRAIN NOT CLOSER THAN 1.5m FROM FOOTINGS IN ACCORDANCE WITH AS2870 SECTION 5.6
- PROVIDE SURFACE DRAINAGE IN ACCORDANCE WITH AS2870 SECTION 5.6.3
- PROVIDE FLEXIBLE JOINTS IN ALL DRAINAGE EMERGING FROM UNDERNEATH OR ATTACHED TO BUILDING IN ACCORDANCE WITH AS2870 SECTION 5.6.4 FOR ALL CLASS H AND E SITES. REFER TO GEOTECH FOR FURTHER INFORMATION
- DOWNPIPES AND GUTTERS DESIGNED IN ACCORDANCE WITH AS/NZS 3500 3

STAIRCASES / BALUSTRADES / HANDRAILS

STAIR TREADS 240mm MIN. - 355mm MAX. STAIR RISERS 115mm MIN. - 190mm MAX.

- HANDRAIL REQUIRED WHERE CHANGE OF LEVEL BETWEEN FLOOR / LANDINGS > 1m AS PER CURRENT NCC 11.3.5
- NO GAPS IN STAIRCASES OR BALUSTRADE TO BE GREATER THAN 125mm
- BALUSTRADE REQUIRED WHERE LEVEL OF LANDING OR DECK IS GREATER THAN 1000mm ABOVE ADJACENT GROUND LEVEL
- BALUSTRADE TO BE MINIMUM 1000mm ABOVE FFL (INCLUDING ANY FLOOR COVERINGS)
- DOORS OPENING OUTWARDS EXTERNALLY MUST OPEN TO A LANDING (MIN. 750mm WIDE) WHERE THE DIFFERENCE IN LEVELS IS GREATER THAN 570mm
- NON-SLIP TREADS TO ALL TREADS AND TO COMPLY WITH NCC 11.2.4
- WHERE LANDINGS ARE NOT NOMINATED TO EXTERNAL DOORS. OPERATING DOOR LEAFS ARE TO BE SCREWED FIXED SHUT, OR PROVIDED WITH A FORMED FCR LANDING NOMINALLY 180mm BELOW FLOOR LEVEL.
- GLAZED BALUSTRADE AND HANDRAILS TO COMPLY WITH NCC PART 8.4, 11.3 AND AS1288 REQUIREMENTS

ROOFING

- ROOF TO BE COLORBOND 'CUSTOM ORB' METALDECK UNLESS NOTED OTHERWISE. PROVIDED AND INSTALLED IN ACCORDANCE WITH AS1562.1 (IF TILED REFER TO AS2050)
- PREFABRICATED ROOF TRUSSES TO BE SUPPLIED AND INSTALLED TO MANUFACTURERS SPECIFICATIONS, TRUSS MANUFACTURER TO CONFIRM LINTEL SIZES.

ELECTRICAL

- EXHAUST FAN TO COMPLY WITH CURRENT NCC PART 10.6.2 SECTION C
- EXHAUST FANS TO BE SEALED AND DUCTED TO OUTSIDE OF DWELLING IN ACCORDANCE WITH NCC VOLUME 2, PARTS 10.8.2 AND 10.8.3
- IF VENTING OCCURS DIRECTLY THROUGH WALLS/ROOF ADJACENT TO FAN. THEN UNIT REQUIRES SELF CLOSING BAFFLES TO BE CLASSIFIED AS A SEALED UNIT
- ELECTRICIAN IS TO ENSURE THAT ALL GPO'S IN WET AREAS MEET ALL STANDARD AND CODE REQUIREMENTS - ALL GPO'S TO BE 300mm FROM FFL UNLESS NOTED OTHERWISE

WET AREAS

- WALLS TO WET AREAS TO BE FINISHED WITH WET AREA PLASTERBOARD
- COMPLIANCE WITH NCC PART 10.2 AND AS3740
- ALL UNENCLOSED SHOWERS ABOVE BATHS TO HAVE MINIMUM 900mm SHOWER SCREEN OR FLOORWASTE WITHIN 1500mm OF SHOWER CONNECTION AS PER AS3740

CONDENSATION

- WHERE RAKED CEILINGS EXIST, IT IS HIGHLY RECCOMENDED THAT SUITABLE SPACING BETWEEN SARKING AND BULK INSULATION EXISTS. (NO CONTACT BETWEEN PRODUCTS). THE BUILDER IS TO ENSURE ADEQUATE SIZED TIMBER IS USED TO ENSURE THIS SEPARATION IS PROVIDED.
- IN STANDARD ROOF SPACES. IT IS HIGHLY RECOMMENDED TO PROVIDE SEPARATION BETWEEN SARKING AND CEILING INSULATION AROUND THE BUILDING PERIMETER, TO ENSURE AIRFLOW FROM EAVE VENTS IS MAINTAINED
- IT IS HIGHLY RECOMMENDED THAT ALL LIGHTWEIGHT CLADDING IS BATTENED OUT FROM STUDS (METAL / FC SHEET / TIMBER)

WOOD HEATERS

- ALL WOOD HEATERS ARE TO COMPLY WITH MANUFACTURERS SPECIFICATION AND NCC PART 12.4

FIRE SAFETY

- SMOKE ALARMS TO BE MAINS POWERED AND INSTALLED AS PER AS3786. LOCATIONS AS PER NCC 9.5.
- SMOKE ALARMS TO BE INTERCONNECTED WHERE THERE IS MORE THAN ONE ALARM
- INSTALLATION OF WOOD HEATERS TO COMPLY WITH AS2918. PROVIDE LOCAL AUTHORITIES WITH INSULATION AND **COMPLIANCE CERTIFICATES**

SUBJECT TO NCC 2022 (1 MAY 2023)

WATERPROOFING & PLUMBING **CONDENSATION MANAGEMENT**

PLAN ACCEPTAN	CE BY OWNER
SIGNATURE:	DATE:
SIGNATURE:	DATF:
SIGNATURE.	DATE.
PLEASE NOTE THAT VARIATION	IS WILL NOT BE ACCEPTED
AFTER THIS PLAN ACCEPTA	NCE HAS BEEN SIGNED

© 2025 WILSON HOMES PTY LTD (ABN 96 126 636 897). THIS DRAWING IS AN ORIGINAL ARTISTIC WORK WITHIN THE MEANING OF THE COPYRIGHT ACT 1968 (CTH). WILSON HOMES PTY LTD IS THE OWNER OF COPYRIGHT IN THIS DRAWING. YOU HEREBY AGREE AND UNDERTAKE THAT YOU WILL NOT IN ANY WAY REPRODUCE, COPY, MODIFY, USE OR TAKE ADVANTAGE OF THE DRAWING TO BUILD A HOUSE BASED ON THIS PLAN (WHETHER IN WHOLE OR IN PART) WITHOUT THE PRIOR WRITTEN CONSENT OF WILSON HOMES PTY LTD.



SPECIFICATION OUSE DESIGN HOUSE CODE REVISION DRAWN DO NOT SCALE DRAWINGS, USE IGURED DIMENSIONS ONLY, CHEC HMI 12/09/2025 BENJAMIN ADAM SHOOBRIDGE DISCOVERY YORK 14 H-WDCYOR10SA DRAFT SALE PLAN - CT1 AND VERIFY DIMENSIONS AND I EVELS PRIOR TO THE FACADE DESIGN FACADE CODE HMI 25/09/2025 ADDRESS 2 DRAFT SALE PLAN - CT1 UPDATE KPH 07/10/2025 45 GLEN LEA ROAD, PONTVILLE TAS 7030 **CLASSIC** F-WDCYOR10CLASA 3 PRELIM PLANS - INITIAL ISSUE TO THE DRAFTING OFFICE. SHEET TITLE: LOT / SECTION / CT: SHEET No : COUNCIL . SCALES: 714341 2 / - / 189251 BRIGHTON **GENERAL NOTES** 19 / 23

WET AREA NOTES					ENERG
VESSELS OR AREA WHERE THE FIXTURE IS INSTALLED	FLOORS AND HORIZONTAL SURFACES	WALLS	WALL JUNCTIONS AND JOINTS	PENETRATIONS	STATED R VA NOT RT VALU
ENCLOSED SHOWER WITH HOR	WATERPROOF ENTIRE ENCLOSED	WATERPROOF TO NOT LESS THAN 150mm AROVE THE	WATERDROOF INTERNAL AND EXTERNAL	WATERPROOF ALL	INSULATIO

VESSELS OR AREA WHERE THE FIXTURE IS INSTALLED	FLOORS AND HORIZONTAL SURFACES	WALLS	WALL JUNCTIONS AND JOINTS	PENETRATIONS
ENCLOSED SHOWER WITH HOB	WATERPROOF ENTIRE ENCLOSED SHOWER AREA INCLUDING HOB.	WATERPROOF TO NOT LESS THAN 150mm ABOVE THE SHOWER FLOOR SUBSTRATE OR NOT LESS THAN 25mm ABOVE THE MAXIMUM RETAINED WATER LEVEL WHICH EVER IS THE GREATER WITH THE REMAINDER BEING WATERPROOF TO A HEIGHT OF NOT LESS THAN 1800mm ABOVE THE FINISHED FLOOR LEVEL.	WATERPROOF INTERNAL AND EXTERNAL CORNERS AND HORIZONTAL JOINTS WITHIN A HEIGHT OF 1800mm ABOVE THE FLOOR LEVEL WITH NOT LESS THAN 40mm WIDTH EITHER SIDE OF THE JUNCTION.	WATERPROOF ALL PENETRATIONS.
ENCLOSED SHOWER WITHOUT HOB	WATERPROOF ENTIRE ENCLOSED SHOWER AREA, INCLUDING WATERSTOP.	WATERPROOF TO NOT LESS THAN 150mm ABOVE THE SHOWER FLOOR SUBSTRATE WITH THE REMAINDER BEING WATERPROOF TO A HEIGHT OF NOT LESS THAN 1800mm ABOVE THE FINISHED FLOOR LEVEL.	WATERPROOF INTERNAL AND EXTERNAL CORNERS AND HORIZONTAL JOINTS WITHIN A HEIGHT OF 1800mm ABOVE THE FLOOR LEVEL WITH NOT LESS THAN 40mm WIDTH EITHER SIDE OF THE JUNCTION.	WATERPROOF ALL PENETRATIONS.
ENCLOSED SHOWER WITH STEPDOWN	WATERPROOF ENTIRE ENCLOSED SHOWER AREA INCLUDING THE STEPDOWN.	WATERPROOF TO NOT LESS THAN 150mm ABOVE THE SHOWER FLOOR SUBSTRATE OR NOT LESS THAN 25mm ABOVE THE MAXIMUM RETAINED WATER LEVEL WHICHEVER IS THE GREATER WITH THE REMAINDER BEING WATERPROOF TO A HEIGHT OF NOT LESS THAN 1800mm ABOVE THE FINISHED FLOOR LEVEL.	WATERPROOF INTERNAL AND EXTERNAL CORNERS AND HORIZONTAL JOINTS WITHIN A HEIGHT OF 1800mm ABOVE THE FLOOR LEVEL WITH NOT LESS THAN 40mm WIDTH EITHER SIDE OF THE JUNCTION.	WATERPROOF ALL PENETRATIONS.
ENCLOSED SHOWER WITH PRE-FORMED SHOWER BASE	N/A	WATERPROOF TO A HEIGHT OF NOT LESS THAN 1800mm ABOVE FINISHED FLOOR LEVEL.	WATERPROOF INTERNAL AND EXTERNAL CORNERS AND HORIZONTAL JOINTS WITHIN A HEIGHT OF 1800mm ABOVE THE FLOOR LEVEL WITH NOT LESS THAN 40mm WIDTH EITHER SIDE OF THE JUNCTION.	WATERPROOF ALL PENETRATIONS.
UNENCLOSED SHOWERS	WATERPROOF ENTIRE UNCLOSED SHOWER AREA.	WATERPROOF TO NOT LESS THAN 150mm ABOVE THE SHOWER FLOOR SUBSTRATE OR NOT LESS THAN 25mm ABOVE THE MAXIMUM RETAINED WATER LEVEL WHICH EVER IS THE GREATER WITH THE REMAINDER BEING WATERPROOF TO A HEIGHT OF NOT LESS THAN 1800mm ABOVE THE FINISHED FLOOR LEVEL.	WATERPROOF INTERNAL AND EXTERNAL CORNERS AND HORIZONTAL JOINTS WITHIN A HEIGHT OF 1800mm ABOVE THE FLOOR LEVEL WITH NOT LESS THAN 40mm WIDTH EITHER SIDE OF THE JUNCTION.	WATERPROOF ALL PENETRATIONS.
AREAS OUTSIDE THE SHOWER AREA FOR CONCRETE AND COMPRESSED FIBRE CEMENT SHEET FLOORING	WATER RESISTANT TO ENTIRE FLOOR.	N/A	WATERPROOF ALL WALL/FLOOR JUNCTIONS. WHERE A FLASHING IS USED THE HORIZONTAL LEG MUST BE NOT LESS THAN 40mm.	N/A
AREAS OUTSIDE THE SHOWER AREA FOR TIMBER FLOORS INCLUDING PARTICLEBOARD, PLYWOOD AND OTHER TIMBER BASED FLOORING MATERIALS	WATERPROOF ENTIRE FLOOR.	N/A	WATERPROOF ALL WALL/FLOOR JUNCTIONS. WHERE A FLASHING IS USED THE HORIZONTAL LEG MUST BE NOT LESS THAN 40mm.	N/A
AREAS ADJACENT TO BATHS AND SPAS FOR CONCRETE AND COMPRESSED FIBRE CEMENT SHEET FLOORING.	WATER RESISTANT TO ENTIRE FLOOR.	WATERPROOF TO A HEIGHT OF NOT LESS THAN 150mm ABOVE THE VESSEL AND EXPOSED SURFACES BELOW THE VESSEL LIP TO FLOOR LEVEL.	WATERPROOF EDGES OF THE VESSEL AND JUNCTION OF BATH ENCLOSURE WITH FLOOR. WHERE THE LIP OF THE BATH IS SUPPORTED BY A HORIZONTAL SURFACE, THIS MUST BE WATERPROOF FOR SHOWERS OVER BATH AND WATER RESISTANT FOR ALL OTHER CASES.	WATERPROOF ALL TAP AND SPOUT PENETRATIONS WHERE THEY OCCUR IN A HORIZONTAL SURFACE.
AREAS ADJACENT TO BATHS AND SPAS (SEE NOTE 1) FOR TIMBER FLOORS INCLUDING PARTICLEBOARD, PLYWOOD AND OTHER TIMBER BASED FLOORING MATERIALS.	WATERPROOF ENTIRE FLOOR.	WATERPROOF TO A HEIGHT OF NOT LESS THAN 150mm ABOVE THE VESSEL AND EXPOSED SURFACES BELOW THE VESSEL LIP TO FLOOR LEVEL.	WATERPROOF EDGES OF THE VESSEL AND JUNCTION OF BATH ENCLOSURE WITH FLOOR. WHERE THE LIP OF THE BATH IS SUPPORTED BY A HORIZONTAL SURFACE, THIS MUST BE WATERPROOF FOR SHOWERS OVER BATH AND WATER RESISTANT FOR ALL OTHER CASES.	WATERPROOF ALL TAP AND SPOUT PENETRATIONS WHERE THEY OCCUR IN A HORIZONTAL SURFACE.
INSERTED BATHS	N/A FOR FLOOR UNDER BATH. ANY SHELF AREA ADJOINING THE BATH OR SPA MUST BE WATERPROOF AND INCLUDE A WATERSTOP UNDER THE VESSEL LIP.	N/A FOR WALL UNDER BATH. WATERPROOF TO NOT LESS THAN 150mm ABOVE THE LIP OF THE BATH.	N/A FOR WALL UNDER BATH. WATERPRROF TO NOT LESS THAN 150 mm ABOVE THE LIP OF A BATH OR SPA.	WATERPROOF ALL TAP AND SPOUT PENETRATIONS WHERE THEY OCCUR IN A HORIZONTAL SURFACE.
WALLS ADJOINING OTHER VESSELS (EG. SINKS, LAUNDRY TUBS AND BASINS)	N/A	WATERPROOF TO A HEIGHT OF NOT LESS THAN 150mm ABOVE THE VESSEL IF THE VESSEL IS WITHIN 75mm OF THE WALL.	WHERE THE VESSEL IS FIXED TO A WALL, WATERPROOF EDGES FOR EXTENT OF VESSEL.	WATERPROOF ALL TAP AND SPOUT PENETRATIONS WHERE THEY OCCUR IN A HORIZONTAL SURFACE.
LAUNDRIES AND WCS	WATER RESISTANT TO ENTIRE FLOOR.	WATERPROOF ALL WALL/FLOOR JUNCTIONS TO NOT LESS THAN 25mm ABOVE THE FINISHED FLOOR LEVEL,	WATERPROOF ALL WALL/FLOOR JUNCTIONS. WHERE A FLASHING IS USED THE HORIZONTAL	N/A

THE ABOVE INFORMATION IS FOR GENERAL GUIDANCE AND IS INDICATIVE ONLY. WATERPROOFING INSTALLERS TO COMPLY WITH ALL CURRENT CODES OF LEGISLATION WHICH TAKE PRECEDENCE OVER THIS SPECIFICATION.

WET AREA WAERPROOFING BY LICENSED AND ACCREDITED INSTALLER. CERTIFICATION TO BE PROVIDED TO BUILDING SURVEYOR. CONTRACTOR OR BUILDER TO DETERMINE THE APPROPRIATE WATERPROOFING IN ACCORDANCE WITH AS3740 PART 10.2 OF N.C. CAND TO NOTIFY THE RUII DING SURVEYOR FOR INSPECTION ARRANGEMENTS DURING INSTALLATION.

SEALED TO FLOOR.

EFFICIENCY - GENERAL

JES ARE FOR ADDITIONAL INSULATION REQUIRED AND ARE S (TOTAL SYSTEM VALUE)

BE INSTALLED TO MANUFACTURERS SPECIFICATIONS AND ANY RELEVANT STANDARDS

BULK INSULATION IS NOT TO BE COMPRESSED AS THIS REDUCES THE EFFECTIVE R RATING

WAFFLE POD ALLOWANCES:

- R0.6 175mm DEEP
- R0 7 225mm DEEP
- R0.8 300mm DEEP
- R0.9 375mm DEEP

N.C.C 2022 TAS PART H6

IN TASMANIA, FOR NCC PART H6 REFER TO NCC 2019 AMENDMENT 1 PART 2.6; FOR NCC PART 13.1 REFER TO NCC 2019 PART 3.12

N.C.C 2019 3.12.0 (A)

PERFORMANCE REQUIREMENT P2.6.1 FOR THE THERMAL PERFORMANCE OF THE BUILDING IS SATISFIED BY COMPLYING WITH:

3.12.0.1 - FOR REDUCING THE HEATING AND COOLING LOADS

TO REDUCE HEATING AND COOLING LOADS MUST ACHIEVE AN ENERGY RATING USING HOUSING ENERGY RATING SOFTWARE OF NOT LESS THAN 6

3.12.1.1 - FOR BUILDING FABRIC THERMAL INSULATION

BUILDER TO ENSURE THAT ALL INSULATION COMPLIES WITH AS/NZS 4859.1 AND BE INSTALLED TO N.C.C 3.12.1.1.

3.12.1.2(e) - FOR COMPENSATING FOR A LOSS OF CEILING INSULATION REFER TO ATTACHED THERMAL PERFORMANCE CERTIFICATE

- (i) IF ALLOWANCE HAS BEEN MADE FOR CEILING PENERATIONS IN NATHERS (FIRST RATE 5) CERTIFICATION PROCESS THEN NO FURTHER ACTION REQUIRED.
- (ii) IF NO ALLOWANCE HAS BEEN MADE FOR CEILING PENETRATIONS IN NATHERS (FIRST RATE 5) CERTIFICATION PROCESS THEN CEILING PENETRATION AREA MUST BE CALCULATED AND THE NECESSARY ADJUSTMENT MADE TO THE SPECIFIED INSULATION AS PER TABLE 3.12.1.1B OF NCC

3.12.1.5(c) AND 3.12.1.5(d) - FOR FLOOR EDGE INSULATION FOR CONCRETE SLAB ON GROUNG WITH IN SLAB HEATING OR COOLING.

3.12.3 - FOR BUILDING SEALING

3.12.3.1 - CHIMNEYS AND FLUES

THE CHIMNEY OR FLUE OF AN OPEN SOLID FUEL BURNING APPLIANCE MUST BE PROVIDED WITH A DAMPER OR FLAP THAT CAN BE CLOSED TO SEAL THE

- 3.12.3.2 ROOF LIGHTS
 (a) A ROOF LIGHT MUST BE SEALED, OR CAPABLE OF BEING SEALED WHEN
- (i) A CONDITIONED SPACE; OR
- ii) A HABITABLE ROOM IN CLIMATE ZONES 4, 5, 6, 7 OR 8
- (b) A ROOF LIGHT REQUIRED BY (a) TO BE SEALED, OR CAPABLE OF BEING SEALED MUST BE CONSTRUCTED WITH:
- (i) AN IMPEREORATE CEILING DIFFUSER OR THE LIKE INSTALLED AT A CEILING OR INTERNAL LINING LEVEL; OR
- (ii) A WATERPROOF SEAL; OR
- (iii) A SHUTTER SYSTEM READILY OPERATED MANUALLY, MECHANICALLY OR ELECTRONICALLY BY THE OCCUPANT

- 3.12.0.1 EXTERNAL WINDOWS AND DOORS

 (a) A SEAL TO RESTRIC AIR INFILTRATION MUST BE FITTED TO EACH OF AN EXTERNAL DOOR, OPENABLE WINDOW AND OTHER SUCH OPENING:
- (I) WHEN SERVING A CONDITIONED SPACE; OR
- (II) IN CLIMATE ZONES 4, 5, 6, 7 OR 8, WHEN SERVING A HABITABLE ROOM
- (b) A WINDOW COMPLYING WITH THE MAXIMUM AIR INFILTRATION RATES SPECIFIED IN AS2047 NEED NOT COMPLY WITH (a).
- (c) A SEAL REQUIRED BY (a)
- (i) FOR THE BOTTOM EDGE OF AN INTERNAL SWING DOOR, MUST BE A DRAFT PROTECTION DEVICE; AND
- (ii) FOR THE OTHER EDGES OF AN EXTERNAL SWING DOOR OR THE EDGES OF AN OPENABLE WINDOW OR OTHER SUCH OPENING, MAY BE A FOAM OR RUBBER COMPRESSIBLE STRIP, FIBROUS SEAL OR

3.12.3.4 - EXHAUST FANS

AN EXHAUST FAN MUST BE FITTED WITH A SEALING DEVICE SUCH AS A SELF CLOSE DAMPER, FILTER OR THE LIKE WHEN SERVING:

(a) A CONDITIONED SPACE: OR

(b) A HABITABLE ROOM IN THE CLIMATE ZONES 4, 5, 6, 7 OR 8.

3.12.3.5 - CONSTRUCTION OF ROOF, WALLS AND FLOORS

- (a) ROOFS, EXTERNAL WALLS, EXTERNAL FLOORS AND AN OPENING SUCH AS A WINDOW FRAME, DOOR FRAME, ROOF LIGHT FRAME OR THE LIKE MUST BE CONSTRUCTED TO MINIMISE AIR LEAKAGE IN ACCORDANCE WITH (b) WHEN FORMING PART OF THE EXTERNAL FABRIC OF:
 - (i) A CONDITIONED SPACE; OR
 - (ii) A HABITABLE ROOM IN CLIMATE ZONE 4, 5, 6, 7 OR 8.
- (b) CONSTRUCTION REQUIRED BY (a) MUST BE:
- (i) ENCLOSED BY AN INTERNAL LINING SYSTEM THAT ARE CLOSE FITTING AT CEILING, WALL AND FLOOR JUNCTIONS; OR
- (ii) SEALED BY CAULKING, SKIRTING, ARCHITRAVES, CORNICES OR THE

3.12.3.6 - EVAPORATIVE COOLERS

AN EVAPORATIVE COOLER MUST BE FITTED WITH A SELF CLOSING DAMPER OR THE LIKE WHEN SERVING:

(a) A HEATED SPACE: OR

(b) A HABITABLE ROOM IN CLIMATE ZONES 4 5 6 7 OR 8

3.12.5.5 - ARTIFICIAL LIGHTING

- (a) LAMP POWER DENSITY OR ILLUMINATION POWER DENSITY OF AN ARTIFICIAL LIGHT, EXCLUDING HEATING THAT EMITS LIGHT, MUST NOT EXCEED THE ALLOWANCE OF:
- (i) 5W/m2 IN A CLASS 1 BUILDING
- (ii) 4W/m² ON A VERANDAH, BALCONY OR THE LIKE ATTACHED TO A CLASS 1 BUILDING (NOT EXCLUDING EAVE PERIMETER LIGHTS);
- (iii) 3W/m2 IN A CLASS 10A BUILDING ASSOCIATED WITH A CLASS 1 BUILDING.
- (b) THE ILLUMINATION POWER DENSITY ALLOWANCE IN (a) MAY BE INCREASED BY DIVIDING IT BY THE ILLUMINATION POWER DENSITY ADJUSTMENT FACTOR FOR A CONTROL DEVICE AS PER N.C.C TABLE 3.12.5.3.

SUBJECT TO NCC 2022 (1 MAY 2023)

WATERPROOFING & PLUMBING **CONDENSATION MANAGEMENT**

PLAN ACCEPTAN	ICE BY OWNER	Wilson
SIGNATURE:	DATE:	- MiTekiDiWilson
SIGNATURE:	DATE:	location: D:\OneDrive
PLEASE NOTE THAT VARIATION	NS WILL NOT BE ACCEPTED	Satio
AFTER THIS PLAN ACCEPTA	NCE HAS BEEN SIGNED	Č

© 2025 WILSON HOMES PTY LTD (ABN 96 126 636 897). THIS DRAWING IS AN ORIGINAL ARTISTIC WORK WITHIN THE MEANING OF THE COPYRIGHT ACT 1968 (CTH). WILSON HOMES PTY LTD IS THE OWNER OF COPYRIGHT IN THIS DRAWING. YOU HEREBY AGREE AND UNDERTAKE THAT YOU WILL NOT IN ANY WAY REPRODUCE, COPY, MODIFY, USE OR TAKE ADVANTAGE OF THE DRAWING TO BUILD A HOUSE BASED ON THIS PLAN (WHETHER IN WHOLE OR IN PART) WITHOUT THE PRIOR WRITTEN CONSENT OF WILSON HOMES PTY LTD.

LEG MUST BE NOT LESS THAN 40mm.



	SPECIFICATION:	REVISION	DRAWN	CLIENT:			HOUSE CODE:	DO NOT SCALE DRAWINGS, USE FIGURED DIMENSIONS ONLY. CHECK	İ
1	DISCOVERY	DRAFT SALE PLAN - CT1	HMI 12/09/2025	BENJAMIN ADAM SHOC	BRIDGE	YORK 14	H-WDCYOR10SA	AND VERIFY DIMENSIONS AND LEVELS PRIOR TO THE	.041
			HMI 25/09/2025			FACADE DESIGN:		COMMENCEMENT OF ANY WORK. ALL	n: 24
	© 2025	PRELIM PLANS - INITIAL ISSUE	KPH 07/10/2025	45 GLEN LEA ROAD, PO	NTVILLE TAS 7030	CLASSIC	F-WDCYOR10CLASA	DISCREPANCIES TO BE REPORTED TO THE DRAFTING OFFICE.	Versic
					COUNCIL:	SHEET TITLE: SHEET No.:	SCALES:	71/2/1	late
				2 / - / 189251	BRIGHTON	WET AREA & ENERGY EFFICIENCY NOTES 20 / 23		714341	Temp

Requirements for Building In Bushfire Hazard Areas Building Act 2016

Directors Determination - Bushfire Hazard Areas V1.1, dated 08 April 2021

Deemed-to-Satisfy Requirements (Part 2.3)

2.3.1 Design and construction

(1) Building work in a bushfire-prone area must be designed and constructed in accordance with either: -

(b)Standard for Steel Framed Construction in Bushfire Areas published (b)Standard for Steel Framed Construction in bushrire Areas published by the National Association of Steel Framed Housing Inc. (NASH). as appropriate for a BAL determined for that site using table 2.6 of AS 3959. (2) Subclause (1)(a) is only applicable to the following:

(a) a Class 1, 2 or 3 building or deck associated with a Class 1, 2 or 3 building. (3) Subclause (1)(b) is only applicable to the following:

- (a) a Class 1 building; or (b) a Class 10a building or deck associated with a Class 1 building.
- (4) Despite subsection (1) permissible, variations from requirements specified in 1(a) and 1(b) are as specified in Table 1.
 (5) Despite subsections (1) and (4), performance requirements
- for buildings subject to BAL 40 or BAL Flame Zone (BAL-FZ) are not satisfied by compliance with subsections (1) or (4).

2.3.2 Property Access

2.3.2 Property Access

(1) A new building in a bushfire-prone area must be provided with property access to the building area and the firefighting water point, accessible by a carriageway, designed and constructed as specified in subclause (4).

(2) For an addition or alteration to an existing building in a bushfire-prone area, if there is no property access awailable property access must be provided to the building area and the firefighting water point accessible by a carriageway as specified in subclause (4).

(3) An addition or alteration to an existing building in a bushfire-prone area must not restrict any existing property access to the building area or to water supply for firefighting.

(4) Vehicular access from a public road to a building must:

(a) comply with the property access requirements specified in Table 2;

(b) include access from a public road to within 90 metres of the furthest part of the building measured as a hose lay; and

(c) include access to the hardstand area for the firefighting water point.

2.3.3 Water Supply for Fire fighting

(1) A new building constructed in a bushfire-prone area, must be provided with a water supply dedicated for fire fighting purposes as specified in Table 3A or Table 3B.

(2) For an addition or alteration to an existing building in a bushfire-prone area, if there is no water supply for firefighting available the building must be provided with a water supply dedicated for firefighting purposes which complies with the requirements specified in Table 3A or Table 3B.

2.3.4 Hazard Management Areas

2.3.4 Hazard Management Areas
(1) A new building, and an existing building in the case of an addition or alteration to a building, in a bushfire-prone area must be provided with a hazard management area.
(2) The hazard management area must comply with the requirements specified in Table 4.
(3) The hazard management area for a particular BAL must have the minimum dimensions required for the separation distances specified for that BAL in Table 2.6 of AS. 3959.

(4) The hazard management area must be established and maintained such that fuels are reduced sufficiently, and other hazards are removed such that the fuels and other hazards do not significantly contribute to the bushfire attack.

2.3.5 Bushfire emergency plan

An emergency plan must be provided for:
 a new building;

(b) an existing building in the case of an addition or alteration to a building:

building:

(c) an existing building in the case of a change of building class;

(d) a building associated with the use, handling, generation or storage of a hazardous chemical or explosive; in a bushfire-prone area.

(2) A bushfire emergency plan must comply with the requirements specified in Table 5.

7. Interpretation of Tables

7. Interpretation of Tables (1) For the purposes of the deemed-to-satisfy provisions in clause 2.3 of this Determination, Tables 1, 2, 3A, 3B, 4, and 5 must be complied with in the following way: (a) for a particular element specified in column 1, the corresponding requirement specified in column 2 must be complied with.

Table 1 - Construction Requirements & Construction Variations

Column 1		Column 2			
	ELEMENT	REQUIREMENT			
A.	Straw Bale Construction	May be used in exposures up to and including BAL 19.			
В.	Shielding provisions under Section 3.5 of AS3959-2018	To reduce construction requirements due to shielding, building plans must include suitable detailed elevations or plans that demonstrate that the requirements of Section 3.5 of the Standard can be met.			
		Comment: Application of Section 3.5 of the Standard cannot result in and assessment of BAL-LOW.			

	Column 1			
ELEMENT		REQUIREMENT		
A.	Property access length is less than 30 metres; or access is not for a fire appliance to access a water connection point.	There are no specified design and construction requirements.		
В.	Property access length is 30 metres or greater; or access for a fire appliance to a water connection point.	The following design and construction requirements apply to property access: (1) All-weather construction; (2) Load capacity of at least 20 tonnes, including for bridges and culverts; (3) Minimum carriageway widths of 4 metres; (4) Minimum vertical clearance of 4 metres; (5) Minimum horizontal clearance of 0.5 metres from the edge of the carriageway; (6) Cross falls of less than 3° (1:20 or 5%); (7) Dips less than 7° (1:8 or 12.5%) entry and exit angle; (8) Curves with a minimum inner radius of 10 metres; (9) Maximum gradient of 15° (1:3.5 or 28%) for sealed roads, and 10° (1:5.5 or 18%) for unsealed roads; and (10) Terminate with a turning area for fire appliances provided by one of the following: (a) A turning circle with a minimum inner radius of 10 metres; (b) A property access encircling the building; or (c) A hammerhead "T" or "Y" turning head 4 metres wide and 8 metres long.		
C.	Property access length is 200 metres or greater.	The following design and construction requirements apply to property access: (1) The Requirements for B above; and (2) Passing bays of 2 metres additional carriageway width and 20 metres length provided every 200 metres.		
D.	Property access length is greater than 30 metres, and access is provided to 3 or more properties.	The following design and construction requirements apply to property access: (1) Complies with Requirements for B above; and (2) Passing bays of 2 metres additional carriageway width and 20 metres length must be provided every 100 metres.		

Table 3A - Reticulated Water Supply for Firefighting

Column 1		Column 2			
	ELEMENT	REQUIREMENT			
A.	Distance between building area to be protected and water supply	The following requirements apply: (1) The building area to be protected must be located within 120 metres of a fire hydrant; and (2) The distance must be measured as a hose lay, between the water connection point and the furthest part of the building area.			
В.	Design criteria for fire hydrants	The following requirements apply: (1) Fire hydrant system must be designed and constructed in accordance with TasWater Supplement to Water Supply Code of Australia WSA 03 - 2011-3.1 MRWA Edition 2.0; and (2) Fire hydrants are not installed in parking areas.			
C.	Hardstand	A hardstand area for fire appliances must be provided: (1) no more than three metres from the hydrant, measured as a hose lay; (2) No closer than six metres from the building area to be protected; (3) With a minimum width of three metres constructed to the same standard as the carriageway; and (4) Connected to the property access by a carriageway equivalent to the standard of the property access			

Table 3B - Static Water Supply for Firefighting

	ELEMENT	REQUIREMENT
A.	Distance between building area to be be protected and water supply	The following requirements apply: (a) The building area to be protected must be located within 90 metres of the water connection point of a static water supply; and (b) The distance must be measured as a hose lay, between the water connection point and the furthest part of the building area.
B.	Static Water Supplies	A static water supply: (a) May have a remotely located offtake connected to the static water supply; (b) May be a supply for combined use (fire fighting and other uses) but the specified minimum quantity of fire fighting water must be available at all times; (c) Must be a minimum of 10,000 litres per building area to be protected. This volume of water must not be used for any other purpose including fire fighting sprinkler or spray systems; (d) Must be metal, concrete or lagged by non-combustible materials if above ground; and (e) If a tank can be located so it is shielded in all directions in compliance with Section 3.5 of AS 3959-2018, the tank may be constructed of any material provided that the lowest 400 mm of the tank exterior is protected by: (i) metal; (ii) non-combustible material; or (iii) fibre-cement a minimum of 6 mm thickness.
C.	Fittings, pipework and accessories (including stands and tank supports)	Fittings and pipework associated with a water connection point for a static water supply must: (a) Have a minimum nominal internal diameter of 50mm; (b) Be fitted with a valve with a minimum nominal internal diameter of 50mm; (c) Be metal or lagged by non-combustible materials if above ground; (d) Where buried, have a minimum depth of 300mm (e) Provide a DIN or NEN standard forged Storz 65 mm coupling fitted with a suction washer for connection to fire fighting equipment; (f) Ensure the coupling is accessible and available for connection at all times; (g) Ensure the coupling is fitted with a blank cap and securing chain (minimum 220 mm length); (h) Ensure underground tanks have either an opening at the top of not less than 250 mm diameter or a coupling compliant with this Table; and (i) Where a remote offtake is installed, ensure the offtake is in a position that is: (i) Visible; (ii) Accessible to allow connection by fire fighting equipment; (iii) At a working height of 450 - 600mm above ground level; and (iv) Protected from possible damage, including damage by vehicles.
D.	Signage for static water connections	(1)The water connection point for a static water supply must be identified by a sign permanently fixed to the exterior of the assembly in a visible location. The sign must: (a) comply with water tank signage requirements within AS 2304; or (b) comply with the TFS Water Supply Signage Guideline.
E.	Hardstand	A hardstand area for fire appliances must be provided: (a) No more than three metres from the water connection point, measured as a hose lay (including the minimum water level in dams, swimming pools and the like); (b) No closer than six metres from the building area to be protected; (c) With a minimum width of three metres constructed to the same standard as the carriageway; and (d) Connected to the property access by a carriageway equivalent to the standard of the property access.

Table 4 - Requirements for Hazard Management Area

	Column 1	Column 2
	ELEMENT	REQUIREMENT
A.	Hazard managements areas for new buildings on lots provided with a BAL at the time of subdivision.	A new building must: (a) Be located on the lot so as to be provided wih a HMA no smaller than the required separation distances for the BAL determined at the time of the subdivision; and (b) Have a HMA established in accordance with a certified bushfire hazard management plan.
В.	Hazard management areas for new buildings on lots not provided with a BAL at the time of sub division.	A new building must: (a) Be located on the lot so as to be provided with a HMA no smaller than the separation distances required for BAL 29; and (b) Have an HMA established in accordance with a certified bushfire hazard management plan.
C.	Hazard management areas for alterations or additions to buildings.	An alteration or addition to a building must: (a) Be located on the lot so as to be provided with a HMA which: (i) Has the separation distances required for the BAL assessed for the construction of the existing building; or (ii) In the case of a building without an existing BAL assessment, is no smaller than the separation distances required for BAL 29; and (b) Have an HMA established in accordance with a certified bushfire hazard management plan.
D.	Hazard management areas for new buildings and additions and alterations to buildings classified as an accommodation building BCA Class 1b, BCA Class 2, or BCA Class 3, other than communal residence for persons with a disability, a respite centre or a residential aged care facility or similar.	A new building or an alteration or addition must: (a) be located on the lot so as to be provided with HMAs no smaller than the separation distances required for BAL 12.5; and (b) have a HMA established in accordance with a certified bushfire hazard management plan.
E.	Hazard management areas for new buildings and additions and alterations to existing buildings classified as vulnerable use as defined in the relevant planning scheme.	A new building or an addition or alteration including change of use must: (a) be located on the lot so as to be provided with HMAs no smaller than the separation distances required for BAL 12.5; and (b) have a HMA established in accordance with a certified bushfire hazard management plan.
F.	Hazard management areas for new buildings or additions and alterations to buildings associated with the use, handling, generation or storage of a hazardous chemical or explosive.	A new building or an alteration or addition, including change of use, for a building determined as a hazardous use must: (a) Be located on the lot so as to be provided with a HMA no smaller than the required separation distances for the BAL determined in the certified bushfire hazard management plan; and (b) Have a HMA established in accordance with a certified bushfire hazard management plan.

BUILDING ACT BUSHFIRE HAZARD AREAS 21 / 23

Column 1		Column 2
ELEMENT		REQUIREMENT
A.	Bushfire emergency plans	An emergency plan must be developed for the site which is: (a) Consistent with TFS Bushfire Emergency Planning Guidelines; and (b) Approved by TFS or a person accredited by the TFS.

(1 MAY 2023) WATERPROOFING & PLUMBING

CONDENSATION MANAGEMENT

SUBJECT TO NCC 2022

PLAN ACCEPTA	NCE BY OWNER
SIGNATURE:	DATE:
SIGNATURE:	DATE:
	ONS WILL NOT BE ACCEPTED PTANCE HAS BEEN SIGNED

DO NOT SCALE DRAWINGS, USE FIGURED DIMENSIONS ONLY, CHECK AND VERIFY DIMENSIONS AND I EVELS PRIOR TO THE COMMENCEMENT OF ANY WORK. AL DISCREPANCIES TO BE REPORTED TO THE DRAFTING OFFICE.

714341

REFER TO SHEET 1 (COVER SHEET) FOR ALL BUILDING INFORMATION REGARDING: SUSTAINABILITY REQUIREMENTS GENERAL BUILDING INFORMATION

SEE SHEET 1 (COVER SHEET) FOR DETAILS

© 2025 WILSON HOMES PTY LTD (ABN 96 126 636 897). THIS DRAWING IS AN ORIGINAL ARTISTIC WORK WITHIN THE MEANING OF THE COPYRIGHT ACT 1968 (CTH). WILSON HOMES PTY LTD IS THE OWNER OF COPYRIGHT IN THIS DRAWING, YOU HEREBY AGREE AND UNDERTAKE THAT YOU WILL NOT

BRIGHTON

2 / - / 189251



© 2025 WILS	IN ANY WAY REPRODUCE, COPY, MODIFY, USE OR TAKE ADVANTAGE OF THE DRAWING TO BUILD A HOUSE BASED ON THIS PLAN (WHETHER IN WHOLE OR IN PART) WITHOUT THE PRIOR WRITTEN CONSENT OF WILSON HOMES PTY LTD.									
FICATION:		REVISION		DRAWN	CLIENT:		HOUSE DESIGN:		HOUSE CODE:	
COVERY		1 DRAFT SALE PLAN - CT1	НМІ	12/09/2025	BENJAMIN ADAM SHOC	BRIDGE	YORK 14		H-WDCYOR10SA	
RIGHT:		2 DRAFT SALE PLAN - CT1 UPDATE		25/09/2025			FACADE DESIGN:		FACADE CODE:	
025		3 PRELIM PLANS - INITIAL ISSUE	KPH	07/10/2025	45 GLEN LEA ROAD, PO	NTVILLE TAS 7030	CLASSIC		F-WDCYOR10CLASA	
					LOT / SECTION / CT:	COUNCIL:	SHEET TITLE:	SHEET No.:	SCALES:	

All specifications are per AS3959 (2018) and Wilson Homes request. Other materials and options may be available, refer to AS3959 for full list of compliant materials.

5.1 GENERAL

A building assessed in Section 2 as being BAL -12.5 shall comply with Section 3 and Clauses 5.2 to 5.8.

Any element of construction or system that satisfies the test criteria of AS 1530.8.1 may be used in lieu of the applicable requirements contained in Clauses 5.2 to 5.8 (see Clause 3.8).

NOTE: BAL -12.5 is primarily concerned with protection from ember attack, and radiant heat up to and including $29kW/m^2$ where the site is less than 100 m from the source of the bushfire attack.

5.2 SUBFLOOR SUPPORTS

This Standard does not provide construction requirements fo

subfloor supports where the subfloor space is enclosed with (a) a wall that complies with Clause 5.4; OR
(b) a mesh or perforated sheet with a maxium aperture of
2mm, made of corrosion resistant steel, bronze or aluminium; OR (c) a combination of Items (a) and (b)

NOTE: This requirement applies to the subject building only and not to verandas, decks, steps, ramps and landings (see Clause

C5.2 Combustile materials stored in the subfloor space may be ignited by embers and cause and impact to the building.

5.3 FLOORS

5.3.1 GENERAL

This Standard does not provide construction requirement concrete slabs on the ground

5.3.2 ELEVATED FLOORS

5.3.2.1 ENCLOSED SUBFLOOR SPACE

This standard does not provide consturction requirements for elevated floors, including bearers and joists and flooring, where the subfloor space is enclosed with

(a) a wall that complies with Clause 5.4; OR
(b) a mesh perforated sheet with a maximum aperture of 2mm,
made of corrosion resistant steel, bronze or aluminium; OR
(c) a combination of Items (a) and (b) above.

5.3.2.2 UNENCLOSED SUBFLOOR SPACE

Where the subfloor space is unenclosed, the bearers, joists and flooring, less than 400mm above finished ground level, shall be one of the following
(a) Materials that comply with the following:

(i) Bearers and joists shall be (A) non-combustible; OR
(B) bushfire-resisting timber (see Appendix F); OR
(C) a combination of Items (A) and (B) above.

(ii) Flooring shall be -

(ii) Flooring shall be (A) non-combustible; OR
(B) bushfire-resisting timber (see Appendix F); OR
(C) timber (other than bushfire-resisting timber),
particleboard or plywood flooring where the underside is lined with
sarking-type material or mineral wool insulation; OR
(D) a combination of any Items (A), (B) or (C) above.

(b) A system complying with AS1530.8.1

This standard does not provide construction requirements for elements of elevated floors, including bearers, joists and flooring, if the underside of the element is 400mm or more above finished ground level.

5.4.1 WALLS

The exposed components of an external wall that is less than 400 mm from the ground or less than 400 mm above decks, carport roofs, awnings and similar fittings having an angle of less than 18 degrees to the horizontal and extending more than 110 mm in width from the wall (see Figure D3, Appendix D) shall be:

NOTE: Examples include, but are not limited to, the following (with a minimum of 90 mm inthickness): (i) Full masonry or masonry veneer walls with an outer leaf of clay,

concrete, calcium silicate or natural stone.

(ii) Precast or in situ walls of concrete or aerated concrete

(iii) Earth wall including mud brick. OR

(b) Timber logs of a species with a density of 680kg/m³ or greater at a 12 percent moisture content; of a minimum nominal overall thickness of 90mm and a minimum thickness of 70mm (see Clause 3.11); and

gauge planed. OR
(c) Cladding that is fixed externally to a timber-framed or a steel-framed wall that is sarked on the outside of the frame and is (i) non-combustible material; OR
(ii) fibre cement a minimum of 6mm in thickness; OR

(iii) bushfire-resisting timber (see Appendix F); OR
(iv) a timber species as specified in Paragraph E1, Appendix E; pr
(v) a combination of any of Items (i), (iii), (iii) or (iv) above. OR
(d) A combination of any items (a), (b) or (c) above.

5.4.2 JOINTS

All joints in the external surface material of walls shall be covered sealed, overlapped, backed or butt-jointed.

BAL-12.5 BUSHFIRE REQUIREMENTS

SEE SHEET 1 (COVER SHEET) FOR DETAILS

5.4.3 VENTS AND WEEPHOLES

Except for exclusions provided in Clause 3.6, vents and weepholes in external walls shall be screened with a mesh made of corrosion-resistant steel, bronze

5.5.1 BUSHFIRE SHUTTERS

Where fitted, bushfire shutters shall comply with Clause 3.7 and be made from -(a) non-combustible material; OR
(b) a timber species as specified in Paragraph E1, Appendix E; OR
(c) bushfire-resisting timber (see Appendix F); OR
(d) a combination of Items (a), (b) and (c) above.

5.5.2 SCREENS FOR WINDOWS AND DOORS

Where fitted, screens for windows and doors shall have a mesh or perforated sheet made of corrosion-resistant steel, bronze or aluminium.

The frame supporting the mesh or perforated sheet shall be made from (a) metal; OR

(b) bushfire-resisting timber (see Appendix F).
(c) a timber species as specified in Paragraph E2, Appendix E.

5.5.3 WINDOWS AND SIDELIGHTS

(a) be completely protected by a bushfire shutter that complies with Clause 3.7 and clause 5.5.1; OR

(b) Be completely protected externally by screens that conform with Clause 3.6 and Clause 5.5.2.

(c) Conform with the following:

(i) Frame material For window assemblies less than 400mm from the (I) Frame material For window assemblies less than 400mm from the ground or less than 400mm above decks, carport roofs, awnings and similar elements or fittings having and angle less than 18 degrees to the horizontal and extending more than 110mm in width from the window frame (see Figure D3, Appendix D), window frames and window joinery shall be made from:

(A) Bushfire-resisting timber (see Appendix F) OR

(B) A timber species as specified in Paragraph E2, Appendix F); OR

(D) Metal-reinforced uPVC. The reinforcing members shall be made uninium, stainless steel, or corrosion-resistant steel.

There are no specific restrictions on frame material for all other

windows.

(ii) Hardware There are no specific restrictions on hardware for windows.

(iii) Glazing Where glazing is less than 400mm from the grounf or less than 400mm above decks, carport roofs, awnings and similar elements or fittings having and angle less than 18 degrees to the horizontal and extending more than 110mm in width from the window frame (see Figure D3, Appendix D), this glazing shall be Grade A safety glass a minimum of 4mm in thickness or glass blocks with no restriction on glazing methods. NOTE: Where double-glazed assemblies are used above, the requirements apply to the external pane of the glazed assembly only. For all other glazing, annealed glass may be used in accordance with AS 1288.

(iv) Seals and weather strips There are no specific requirements for seals and weather strips at this BAI Level.

(iv) Seals and weather strips. There are no specific requirements for seals and weather strips at this BAL level. (iv) Screens. The openable portions of windows shall be screened internally or externally with screens that conform with Clause 3.6 and Clause 5.5.2.

C5.5.3 For Clause 5.5.3(c), screening of the openable portions of all windows is required in all BAL's to prevent the entry of embers to the building when the

is required in all BAL's to prevent the entry or embods and fixed portions of some window is open. For Clause 5.5.3 (c)(v), screening of the openable and fixed portions of some windows is required to reduce the effects of radiant heat on some tpes of glass. If the screening is required to reduce the effects of radiant heat on glass, and has to be externally fixed.

For Clause 5.5.3 (c)(v), if the screening is required only to prevent the entry of embers, the screening may be fitted externally or internally.

5.5.4 DOORS SIDE-HUNG EXTERNAL DOORS (including French Doors, Panel Fold and Bi-fold Doors)

Side-hung external doors, including French doors, panel fold and bi-fold (a) Be protected by bushfire shutters that comply with Clause 3.7 and Clause 5.5.1.

(b) Be protected externally by screens that comply with Clause 3.6 and Clause 5.5.2.

OR
(c) conform with the following:
(i) Door panel material Materials shall be (A) non combustible; OR
(B) solid timber, laminated timber or reconstituted timber door, having a minimum thickness of 35mm for the first 400mm above the

the threshold; OR

(D) hollow core, solid timber, laminated timber or reconstituted
r protected externally by a screen that complies with Clause 5.5.2; OR
(E) for fully framed glazed door panels, the framing is made from
or bushfire resisting timber (see Appendix F), or a timber species as
fied in Paragraph E2, Appendix E or uPVC.

(A) Bushfire-resisting timber (see Appendix F). OR

(B) a timber species as specified in Paragraph E2 of Appendix E;

(C) Metal. OR (D) Metal-reinforced PVC-U. The reinforcing members shall be de from aluminium, stainless steel, or corrosion-resistant steel. (iii) Hardware There are no specific requirements for hardwarea at this

(iii) Hardware There are no specific requirements for hardwarea at this BAL level.

(iv) Glazing the glazing shall be Grade A safety glass a minimum of 4mm in thickness, or glass blocks with no restriction on glazing methods. NOTE: Where double glazed units are used the above requirements apply to the external face of the window assembly only.

(v) Seals and weather strips Weather strips, draft excluders or draft seals shall be installed.

(vi) Screens There are no specific requirements for hardwarea at this BAL level.

(vii) Doors shall be tight-fitting to the door frame and to an abutting door,

5.5.5 DOORS-SLIDING DOORS

Sliding doors shall:
(a) Be protected by bushfire shutters that comply with Clause 3.7 and Clause 5.5.1.

(b) Be protected externally by screens that comply with Clause 3.6 and Clause 5.5.2.
OR

OR

(c) conform with the following:

(i) Frame material The material for door frames, including fully framed glazed doors, shall be
(A) Bushfire-resisting timber (see Appendix F). OR

(B) a timber species as specified in Paragraph E2 of Appendix E; OR

(C) Metal. OR

(D) Metal-reinforced uPVC. The reinforcing members shall be made from aluminium, stainless steel, or corrosion-resistant steel.

(ii) Hardware There are no specific requirements for hardwarea at this BAL level.

(iii) Glazing Where doors incorporare glazing, the glazing shall be Grade A safety glass a minimum of 4mm in thickness,
(iv) Seals and weather strips There are no specific requirements for

(v) Screens There are no specific requirements for hardwarea at this BAL (vi) Sliding panels Sliding panels shall be tight-fitting in the frames.

5.5.6 DOORS-VEHICLE ACCESS DOORS

(GARAGE DOORS)

The following apply to vehicle access doors:
(a) The lower portion of a vehicle access door that is within 400mm of the ground when the door is closed (see Figure D4, Appendix D) shall be made from (i) non combustible material; OR
(ii) bushfire-resisting timber (see Appendix F); OR
(iii) fibre- cement sheet, a minimum of 6mm in thickness; OR
(iv) a timber species as specified in Paragraph E1, Appendix E; OR

E; OR (iv) a combination of any Items (i), (iii) or (iv) above. (b) All vehicle access doors doors shall be fitted with suitable weather strips, draught seals or brushes. Door assemblies fitted with guide tracks do not need edge gap protection. NOTES:

NOTES:

1 Refer to AS/NZS 4505 for door types.

2 Gaps of door edges or building elements should be protected as per Section 3.

C5.5.6(b) These guide tracks do not provide a direct passage for embers into the building.

(c) Vehicle access doors with ventilation slots shall be protected in accordance with Clause 3.6.

5.6.1 ROOFS - GENERAL

The following apply to all types of roofs and roofing systems:
(a) Roof tiles, roof sheets and roof-covering accessories shall be (b) The roof/wall junction shall be sealed, or otherwise protected in accordance with Clause 3.6.
(c) Roof ventilation openings, such as gable and roof vents, shall be fitted with ember guards made of non-combustible material or a mesh or perforated sheet conforming with Clause 3.6 and made of corrosion-resistant steel, bronze or aluminium.
(d) Only evaporative coolers manufactured in accordance with AS/NZS 60335.2.98 shall be used. Evaporative coolers with an internal damper to prevent the entry of embers into the roof space need to be screened externally. dance with Clause 3.6.

5.6.2 TILED ROOFS

Tiled roofs shall be fully sarked. The sarking shall (a) be located on top of the roof framing, except that the roof battens may be fixed above the sarking; (b) cover the entire roof area including ridges and hips; and (c) extend into gutters and valleys.

5.6.3 SHEET ROOFS

(a) be fully sarked in accordance with Clause 5.6.2, except that (b) have any gaps sealed at the fascia or wall line and at valleys,

hips and ridges by (i) a mesh or perforated sheet that conforms with Clause 3.6 and that is nade of corrosion-resistant steel, bronze or aluminium; or

(iii) other non-combustible material; or

(iv) a combination of any of Items (i), (ii) or (iii) above. C5.6.3 - Sarking is used as a secondary form of ember protection for

5.6.4 VERANDA, CARPORT AND AWNING ROOFS

the roof space to account for minor gaps that may develop in sheet

The following apply to veranda, carport and awning roofs: (a) A veranda, carport or awning roof forming part of the main roof space [see Figure D1(a), Appendix D] shall meet all the rements for the main roof, as specified in Clauses 5.6.1,

(b) A veranda, carport or awning roof separated from the main (v) A veranus, capt of awiming tool separate norm tier main roof space by an external wall [see Figures D1(b) and D1(c), Appendix D] complying with Clause 5.4 shall have a non-combustible roof covering, except where the roof covering is a translucent or transparent material.

NOTE: There is no requirement to line the inderside of a veranda carport or awning roof that is separated from the main roof space

5.6.5 ROOF PENETRATIONS

The following apply to roof penetrations:
(a) Roof penetrations, including roof lights, roof ventilators, roof-mounted evaporative cooling units, aerials, vent pipes and supports for solar collectors shall be sealed. The material used to seal the penetration shall be non-combustible.
(b) Openings in vented roof lights, roof ventilators or vent pipes

shall conform with Clause 3.6 and be made of corrosion-resistant steel, bronze or aluminiun

This requirement does not apply to a room sealed gas appliance. NOTE: A gas appliance designed such that air for combustion dose not enter from, or combustion products enter into, the room which the appliance is located. In the case of gas appliance flues, ember guards shall not be

NOTE: AS/NZS 5601 contains requirements for gas appliance flue systems and cowls. Advice can be obtained from manufacturers and State and Territory gas technical regulators. (c) All overhead glazing shall be Grade A safety glass complying

(d) Glazed elements in roof lights and skylights may be of polymer, provided a Grade A safety glass diffuser, complying with AS 1288, is installed under the glazing. Where glazing is an insulating glazing

unit (IGU), Grade A toughened safety glass of minimum 4 mm in thickness shall be used in the outer pane of the IGU. (e) Flashing elements of tubular skylights may be of a fire-retardan material, provided the roof integrity is maintained by an underflashing of a material having a flammability index not exceeding

five..

(f) Evaporative cooling units shall be fitted with non-combustible butterfly closers as close as practicable to the roof level, or the unit shall be fitted with non-combustible covers with a mesh or perforated sheet with a maximum aperture of 2mm, made of corrosion-resistant steel, bronze or aluminium.

(g) Vent pipes made from PVC are permitted.

(h) Eaves lighting shall be adequately sealed and not compromise the performance of the element.

5.6.6 EAVES LININGS, FASCIAS AND GABLES

The following apply to eaves linings, fascias and gables:
(a) Gables shall comply with Clause 5.4.
(b) Eaves penetrations shall be protected the same as for roof penetrations, as specified in Clause 5.6.5.

(c) Eaves ventilation openings shall be fitted with ember guards in accordance with Clause 3.6 and made of corrosion-resistant steel, bronze or aluminium Joints in eaves linings, fascias and gables may be sealed with

plastic joining strips or timber storm moulds. This standard does not provide construction requirements for fascias, bargeboards and eaves linings.

5.6.7 GUTTERS AND DOWNPIPES

This Standard does not provide material requirements for downpipe Inis Standard uodes not provide inaterial requirements to cowinpipes if installed, gutter and valley leaf guards shall be non-combustible. With the exception of box gutters, gutters shall be metal or PVC-U. Box gutters shall be non-combustible and flashed at the junction with the roof with noncombustible material.

5.7.1 VERANDAS, DECKS, STEPS AND LANDINGS - GENERAL

Decking may be spaced.

There is no requirement to enclose the subfloor spaces of verandas, decks, steps, ramps or landings.

C5.7.7 - Spaced decking is nominally spaced at 3 mm (in accordance with standard industry practice); however, due to the nature of timber decking with seasonal changes in moisture content, that spacing may range from 0 - 5 mm during service.

It should be noted that recent research studies have shown that gaps at 5 mm spacing afford opportunity for embers to become lodged in between timbers, which may contribute to a fire. Larger gap spacings of 10 mm may preclude this from happening but such a spacing regime may not be practical for a timber deck.

5.7.2 ENCLOSED SUBFLOOR SPACES OF VERANDAS, DECKS, STEPS, RAMPS AND LANDINGS

5.7.2.1 Materials to enclose a subfloor space

This standard does not provide construction requirements for the materials used to enclose a subfloor space except where those materials are less than 400mm from the ground. Where the materials used to enclose a subfloor space are less than 400mm from the ground, when the materials used to enclose a subfloor space are less than 400mm from the ground, they shall conform with Clause 5.4.

This Standard does not provide construction requirements for support posts, columns, stumps, stringers, piers and poles.

This Standard does not provide construction requirements for the framing of verandas, decks, ramps or landings (i.e., bearers and joists).

5.7.2.4 Decking, stair treads and the trafficable surfaces of ramps and landings

This standard does not provide construction requirements for decking, stair treds and the trafficable surfaces and landings that are more than 300mm from a glazed element.

Decking, stair treads and the trafficable surfaces of ramps and landings less than 300mm (measured horizontally at deck level) from glazed elements that are less than 400mm (measured vertically) from the surface of the deck (see Figure D2, Appendix D) shall be made from
(a) of non-combustible material; or

(b) of bushfire-resisting timber (see Appendix F); or (c) a timber species as specified in Paragraph E1, Appendix E; or (e) a combination of Items (a), (b), (c) or (d).

5.7.3 UNENCLOSED SUBFLOOR SPACES OF VERANDAS.

DECKS, STEPS, RAMPS AND LANDINGS

This Standard does not provide construction columns, stumps, stringers, piers and poles.

This Standard does not provide construction requirements for the framing of verandas, decks, ramps or landings (i.e., bearers and joists).

5.7.3.3 Decking, stair treads and the trafficable surfaces of ramps and landings This Standard does not provide construction requirements for deshing, stair treds and the trafficable surfaces of ramps and landings that are more than 300mm from

Decking, stair treads and the trafficable surfaces of ramps and landings less than 300mm (measured horizontally at deck level) from glazed elements that are less than 400mm (measured vertically) from the surface of the deck (see Figure D2, Appendix D) shall be made from
(a) of non-combustible material; or

(b) of bushfire-resisting timber (see Appendix F); or (c) a timber species as specified in Paragraph E1, Appendix E; or

d) uPVC: or (e) a combination of any of Items (a), (b), (c) or (d).

5.7.4 BALUSTRADES, HANDRAILS OR OTHER BARRIERS This Standard does not provide construction requirements for balustrades,

5.7.5 VERANDA POSTS

5./.5 VEKANDA PUDIO

Verandah Posts
(a) Shall be timber mounted on galvanised mounted shoes or stirrups with a clearance of no less than 75mm above adjacent ground level; or (b) if less than 40mm (measured vertically) from the surface of the deck or ground (see Fig D2, Appendix D) shall be made from
(i) non-combustible material; or

(ii) bushfire-resisting timber (see Appendix F); or

(iii) a timbers species as specified in Paragraph E1, Appendix E; or

(iv) a combination of any of items (a) or (b).

5.8 WATER AND GAS SUPPLY PIPES

Above-ground, exposed water and gas supply pipes shall be metal

SUBJECT TO NCC 2022 (1 MAY 2023)

WATERPROOFING & PLUMBING CONDENSATION MANAGEMENT

PLAN ACCEPTANCE BY OWNER SIGNATURE: SIGNATURE: DATE:

PLEASE NOTE THAT VARIATIONS WILL NOT BE ACCEPTED

AFTER THIS PLAN ACCEPTANCE HAS BEEN SIGNED

© 2025 WILSON HOMES PTY LTD (ABN 96 126 636 897). THIS DRAWING IS AN ORIGINAL ARTISTIC WORK WITHIN THE MEANING OF THE COPYRIGHT ACT 1968 (CTH). WILSON HOMES PTY LTD IS THE OWNER OF COPYRIGHT IN THIS DRAWING. YOU HEREBY AGREE AND UNDERTAKE THAT YOU WILL NOT IN ANY WAY REPRODUCE, COPY, MODIFY, USE OR TAKE ADVANTAGE OF THE DRAWING TO BUILD A HOUSE BASED ON THIS PLAN (WHETHER IN WHOLE OR IN PART) WITHOUT THE PRIOR WRITTEN CONSENT OF WILSON HOMES PTY LTD.



DISCOVERY DRAFT SALE PLAN - CT1

REVISION 2 DRAFT SALE PLAN - CT1 UPDATE 3 PRELIM PLANS - INITIAL ISSUE

HMI 12/09/2025 BENJAMIN ADAM SHOOBRIDGE HMI 25/09/2025 ADDRESS: KPH 07/10/2025 45 GLEN LEA ROAD, PONTVILLE TAS 7030 LOT / SECTION / CT: 2 / - / 189251

COUNCIL . BRIGHTON

CLASSIC SHEET TITLE:

YORK 14

FACADE DESIGN

BAL 12.5 NOTES

F-WDCYOR10CLASA SHEET No.: | SCALES: 22 / 23

H-WDCYOR10SA

HOUSE CODE

FACADE CODE:


TO THE DRAFTING OFFICE. 714341

DO NOT SCALE DRAWINGS, USE FIGURED DIMENSIONS ONLY, CHECK

AND VERIFY DIMENSIONS AND I EVELS PRIOR TO THE

Figure 5.1. Tiled Roofs


- Install EnviroSeal roof tile sarking on top of the roof framing and below the roof battens.
- For further fixing details contact CSR technical support.

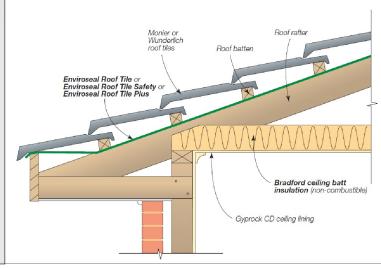

Application	Product
Sarking	EnviroSeal [™] Resiwrap
Foil faced insulation blanket	Bradford Anticon™
Gap seal	Bradford Fireseal BAL 12.5 - 40 Blanket

Figure 5.2.1. Fascia Detail - Metal Roof (BAL12.5-40)

- Install EnviroSeal Resiwrap to the entire roof area over the top of the battens.
- · Immediately above the fascia install BAL12.5 - 40 Blanket extending up the roof and over the first batten. Compress with the roof sheeting.
- For further fixing details contact CSR technical support.

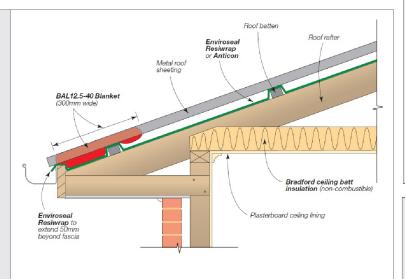

3 PRELIM PLANS - INITIAL ISSUE

Figure 5.2.2. Valley Detail - Steel Roof (BAL-12.5 - BAL-40)

 Install EnviroSeal Resiwrap to the entire roof area over the top of the battens.

BAL12.5 - 40 Blanket to be laid over the top of the sarking extending into the outer edge of the valley gutter. Compress with roof sheeting.

 For further fixing details contact CSR technical support.

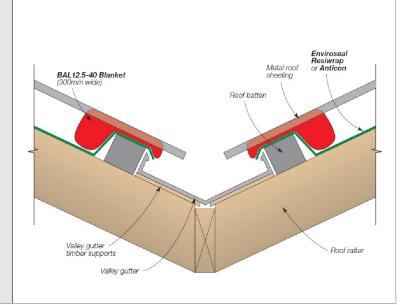


Figure 5.2.3. Barge **Detail - Steel Roof** (BAL-12.5 - BAL-40)

- Install EnviroSeal Resiwrap to the entire roof area over the top of the battens.
- At barge install BAL12.5 - 40 Blanket and compress with roof sheeting.
- For further fixing details contact CSR technical support.


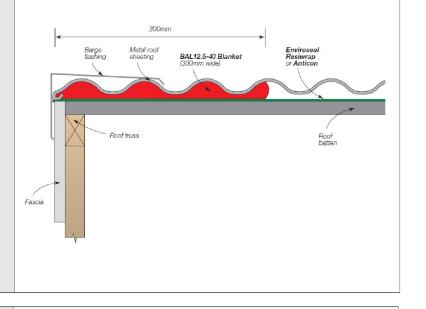


Figure 5.2.4. Hip/Ridge Detail - Steel Roof (BAL-12.5 - BAL-40)

- Install EnviroSeal Resiwrap to the entire roof area over the top of the battens.
- At the ridge/hip lay BAL12.5 - 40 Blanket over the gap between the roof sheets and compress with the ridge capping to the roof profile.
- For further fixing details contact CSR technical support.

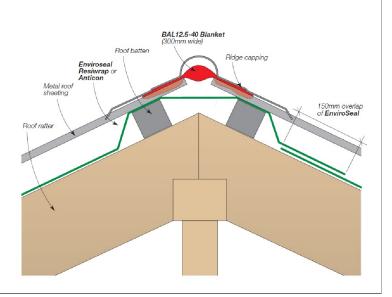

BAL-12.5 BUSHFIRE REQUIREMENTS SEE SHEET 1 (COVER SHEET) FOR DETAILS

© 2025 WILSON HOMES PTY LTD (ABN 96 126 636 897). THIS DRAWING IS AN ORIGINAL ARTISTIC WORK WITHIN THE MEANING OF THE COPYRIGHT ACT 1968 (CTH). WILSON HOMES PTY LTD IS THE OWNER OF COPYRIGHT IN THIS DRAWING, YOU HEREBY AGREE AND UNDERTAKE THAT YOU WILL NOT IN ANY WAY REPRODUCE. COPY MODIEY USE OR TAKE ADVANTAGE OF THE DRAWING TO BIJL DA HOUSE RASED ON THIS PLAN (WHETHER IN WHOLE OR IN PART) WITHOUT THE PRIOR WRITTEN CONSENT OF WILSON HOMES PTY LTD.

		INVEST WAT THE PRODUCE, GOT 1, MODIL 1, GOE ON THE	10 17 11 1	INCL OF THE	EDITORNIA TO BOLED AT TOO DE BAOLD ON THIS TENT (WHETHER WAT WHO LE ON WAT THEY WAT TO BOLED AT THE THICK WAT THE TO	SHOEIT OF WILDOITHOMEOT IT ETD.
SPECIFICATION:		REVISION		RAWN	CLIENT:	HOUSE DESIGN:
DISCOVERY	1	DRAFT SALE PLAN - CT1	НМІ	12/09/2025	BENJAMIN ADAM SHOOBRIDGE	YORK 14
COPYRIGHT:	2	DRAFT SALE PLAN - CT1 UPDATE	НМІ	25/09/2025	ADDRESS:	FACADE DESIGN:

KPH 07/10/2025 45 GLEN LEA ROAD, PONTVILLE TAS 7030 LOT / SECTION / CT: COUNCIL: 2 / - / 189251 BRIGHTON

CLASSIC SHEET TITLE: BAL 12.5 - BAL 40 ROOF DETAILS 23 / 23

HOUSE CODE H-WDCYOR10SA FACADE CODE: F-WDCYOR10CLASA SHEET No.: SCALES:

SIGNATURE:

SIGNATURE:

SUBJECT TO NCC 2022

(1 MAY 2023)

WATERPROOFING & PLUMBING CONDENSATION MANAGEMENT

PLAN ACCEPTANCE BY OWNER

PLEASE NOTE THAT VARIATIONS WILL NOT BE ACCEPTED

AFTER THIS PLAN ACCEPTANCE HAS BEEN SIGNED

DO NOT SCALE DRAWINGS, USE FIGURED DIMENSIONS ONLY. CHECK AND VERIFY DIMENSIONS AND I EVELS PRIOR TO THE COMMENCEMENT OF ANY WORK. AL DISCREPANCIES TO BE REPORTED TO THE DRAFTING OFFICE.

DATE:

DATE:

714341

Images sourced from Bradfords Bushfire Roofing System",

Details for the purpose of

bushfire proofing only.

To be printed in colour.

Published 04/11