

Land Use Planning and Approvals Act 1993

APPLICATION NO.

DA2025/173

LOCATION OF AFFECTED AREA

29 WILLIS STREET, BRIDGEWATER

DESCRIPTION OF DEVELOPMENT PROPOSAL

SECONDARY RESIDENCE

A COPY OF THE DEVELOPMENT APPLICATION MAY BE VIEWED AT www.brighton.tas.gov.au AND AT THE COUNCIL OFFICES, 1 TIVOLI ROAD, OLD BEACH, BETWEEN 8:15 A.M. AND 4:45 P.M, MONDAY TO FRIDAY OR VIA THE QR CODE BELOW. ANY PERSON MAY MAKE WRITTEN REPRESENTATIONS IN ACCORDANCE WITH S.57(5) OF THE LAND USE PLANNING AND APPROVALS ACT 1993 CONCERNING THIS APPLICATION UNTIL 4:45 P.M. ON 24/11/2025. ADDRESSED TO THE CHIEF EXECUTIVE OFFICER AT 1 TIVOLI ROAD, OLD BEACH, 7017 OR BY EMAIL

AT

development@brighton.tas.gov.au.

REPRESENTATIONS SHOULD INCLUDE A DAYTIME TELEPHONE NUMBER TO ALLOW COUNCIL OFFICERS TO DISCUSS, IF NECESSARY, ANY MATTERS RAISED.

JAMES DRYBURGH
Chief Executive Officer



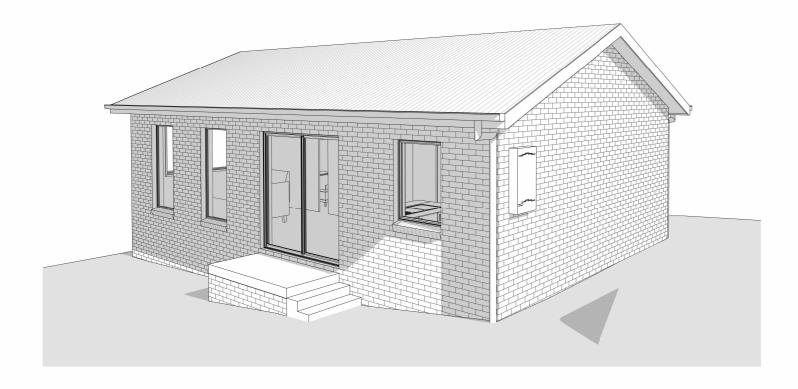


B151 - PROPOSED ANCILLARY DWELLING FOR ANGELA HAYES AT 29 WILLIS STREET, BRIDGEWATER



14 Clare Street, New Town, Tasmania, 7008 Ph: 6278 7782 Mob: 0407 721 824 Fax: 6278 7783 Accreditation No. CC284T

Architectural Drawing No.	Description
01	SITE PLAN
02	DRAINAGE PLAN
03	FLOOR PLAN
04	ELEVATIONS
04a	PERSPECTIVES



PROTECTIVE COATINGS FOR STEELWORK

ENVIRONMENT	LOCATION	MINIMUM PROTECTION COATING		
EINVIRONMENT	LUCATION	General str	uctural steel members	Lintels in masonry
MEDIUM	INTERNAL	No protection required		
mild steel corrosion rate 25 to 50 µm/year	EXTERNAL	Option 1	Hot dip galvanising - F	HDG225
Typically more than 1 km from breaking surf or		Option 2	Duplex system. See N	.C.C. Table 6.3.9c
aggressive industrial areas or more than 50 m from sheltered bays		Option 3	Paint. See N.C.C. Table ACC4, ACC5, IZS1, Pt	

- Heavy industrial areas means industrial environments around major industrial complexes. There are only a few such regions in Australia, examples of which occur around Port Pirie and Newcastle.
- Australia, examples or windor occur and under our Fine and reweaters.

 2. The outer leaf and cavity of an external masonny wall for a building, including walls under open carports are considered to be external environments. A part of an internal leaf of an external masonry wall which is located in the roof space is considered to be
- prior to painting.

 4. All zinc coatings (including inorganic zinc) require a barrier coat to stop conventional domestic enamels from peeling.
- 5. Refer to the paint manufacturer where decorative finishes are required on top of the minimum coating specified in the table for
- 6. Internal locations subject to moisture, such as in close proximity to kitchen or bathroom exhaust fans are not considered to be in a permanently dry location and protection as specified for external locations is required.
- 7. For applications outside the scope of this table, seek specialist advice.

F	REVISION	DATE	SHEETS	DESCRIPTION

C.T. No. C.T.6707/601 Wind Speed -Soil Classification -Corrosion Environment - MEDIUM FLOOR AREA -Lower Floor = 60m² Upper Floor

TBC

Climate Zone -

BAL - Not Bushfire Prone As shown in the Tasmanian Planning Scheme Overlay

6.5 sq

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DRAWING: DATE:

COVER SHEET 28/07/25

FILE NAME: DRAWN BY:

B151 Prelim DA 280825 **COVER SHEET**

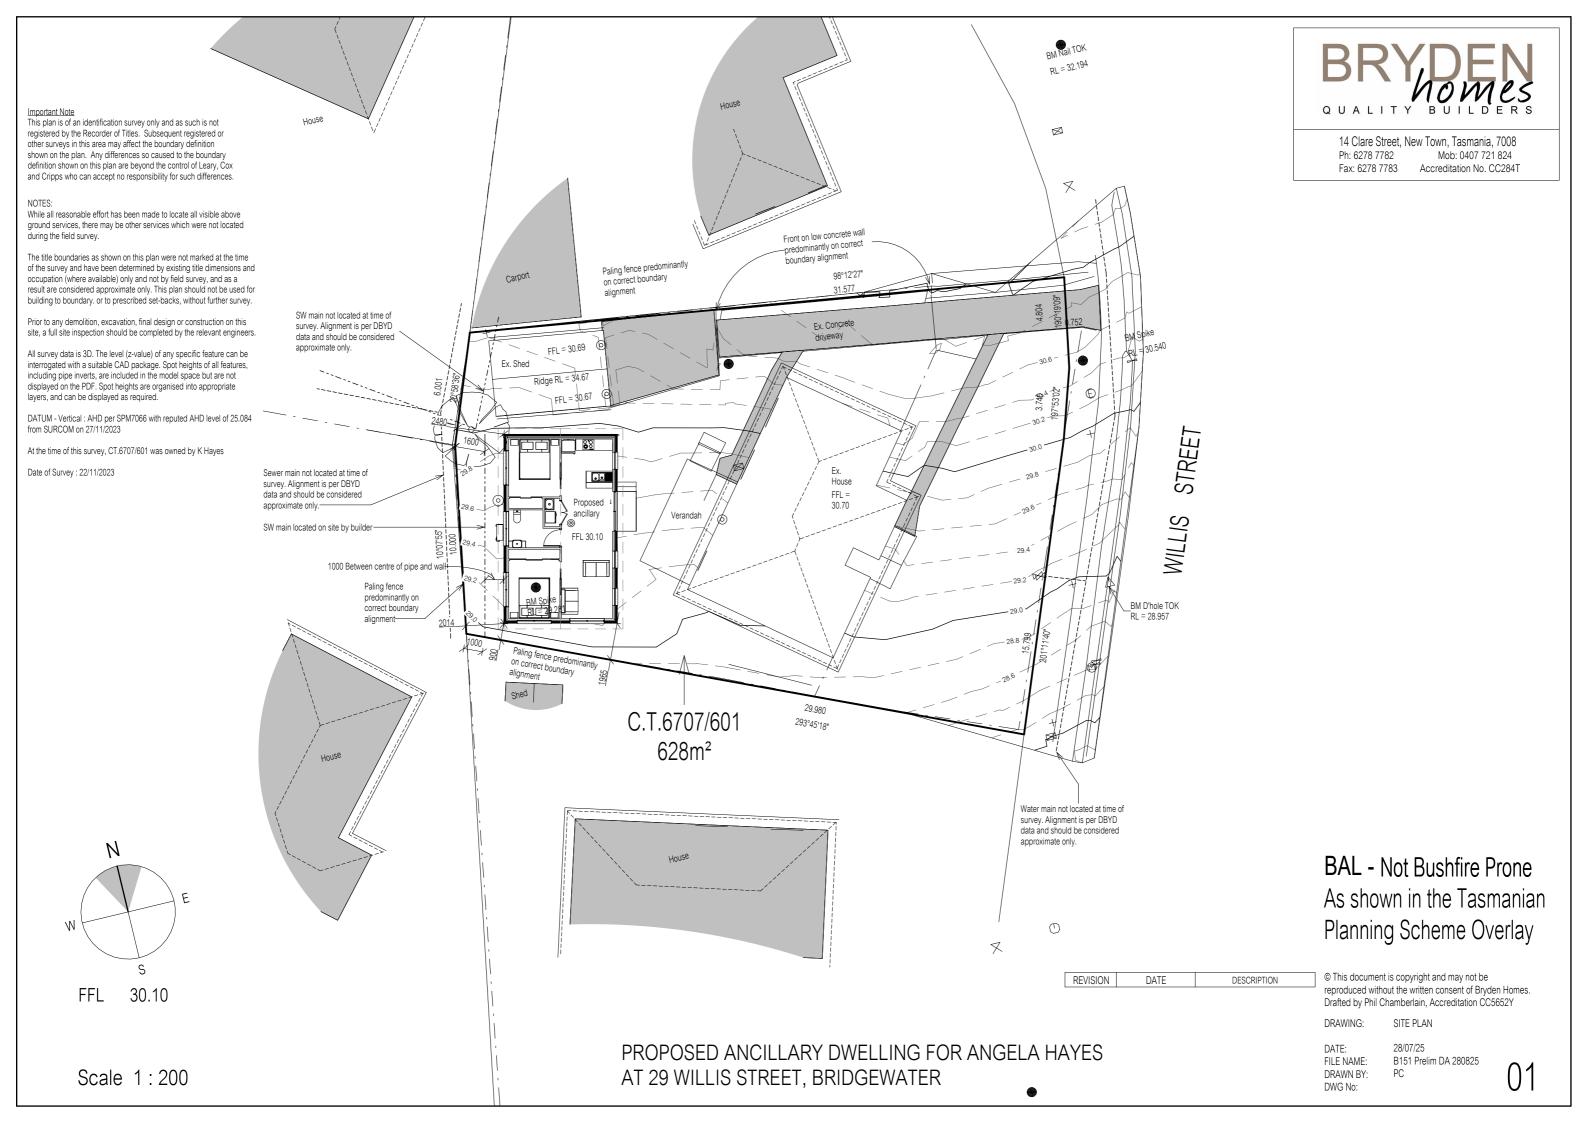
Development application drawings (DA)

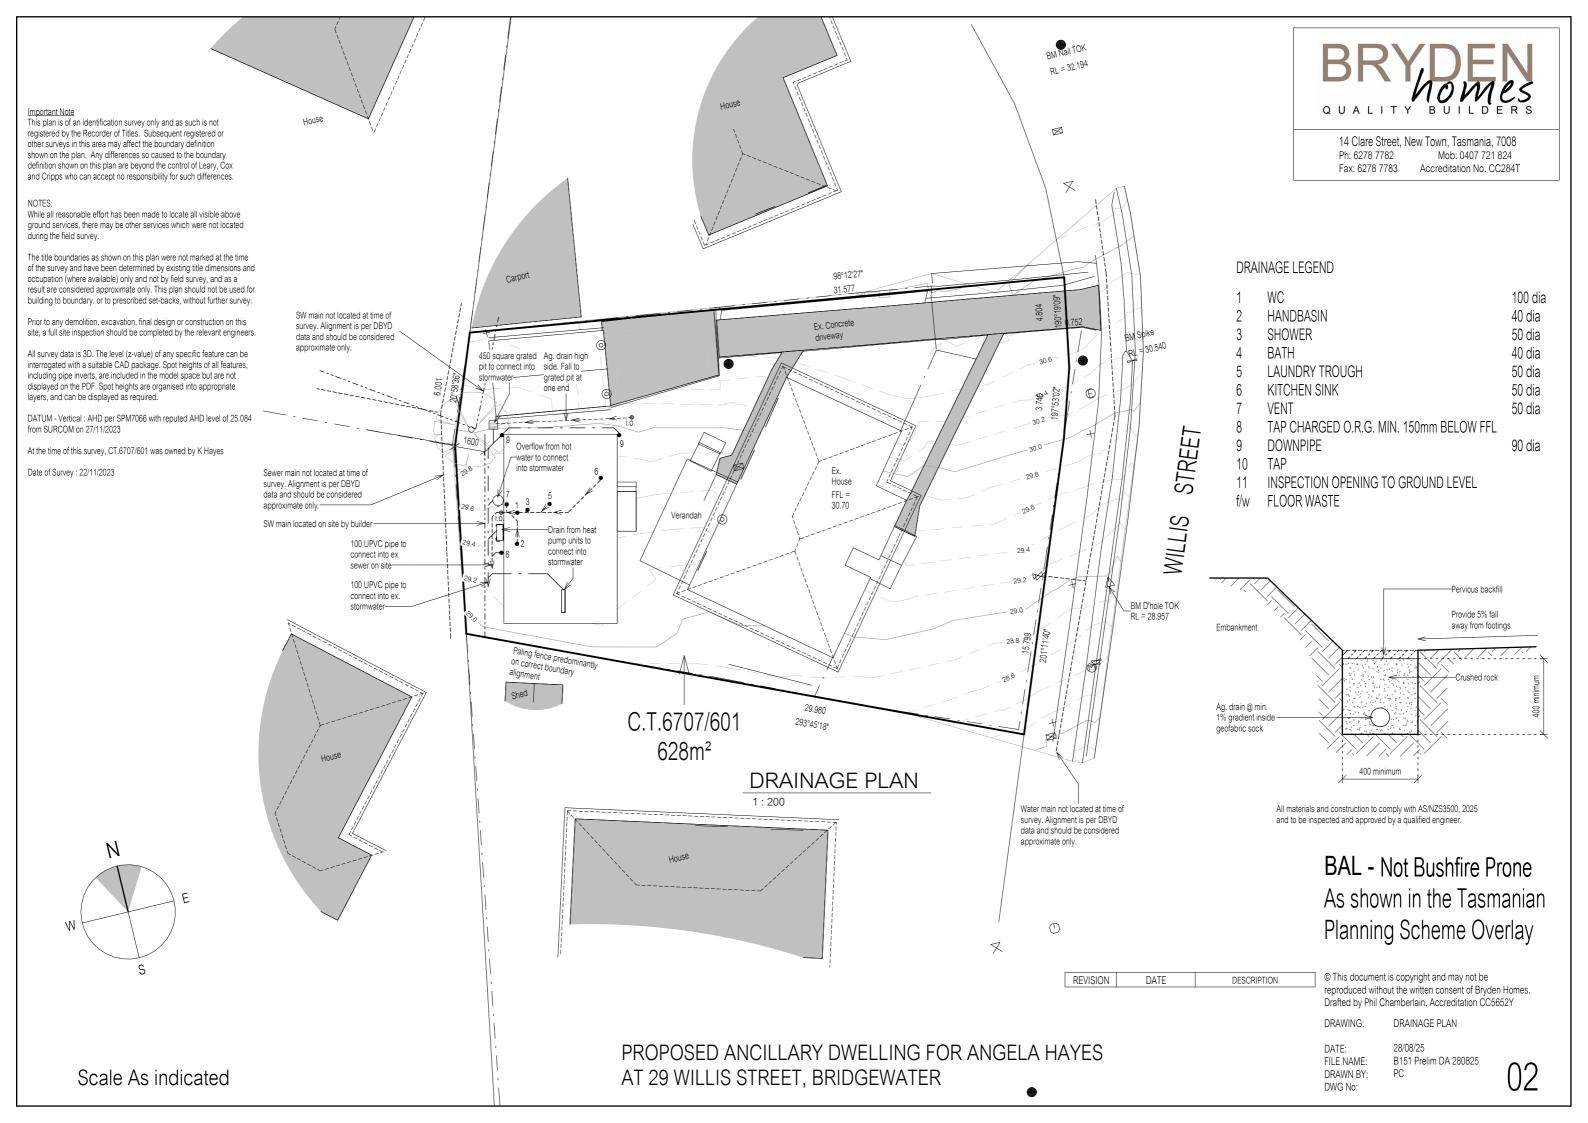
Preliminary construction drawings Engineer not to sign this copy, only provide notes, additions & amendments

Final construction drawings (BA)

Approved by Building Surveyor

Approved by Engineer





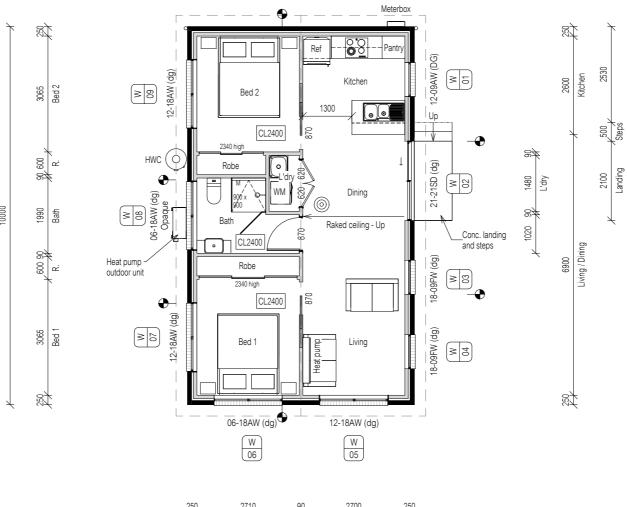
Floor Area = 60m²

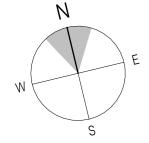
Landing Areas = 2.6m²



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Scale 1:100

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> DRAWING: FLOOR PLAN

FILE NAME: B151 Prelim DA 280825 DRAWN BY:

BAL - Not Bushfire Prone

As shown in the Tasmanian

Planning Scheme Overlay

03

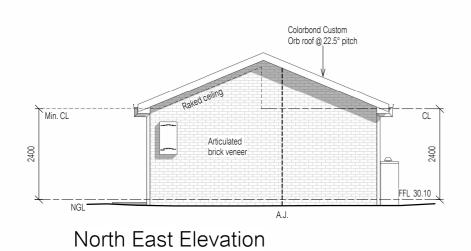
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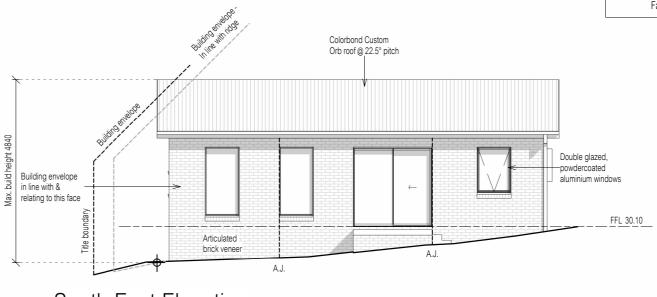
PC

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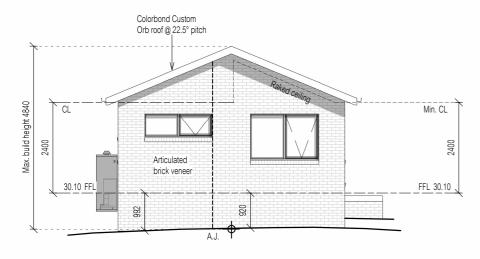


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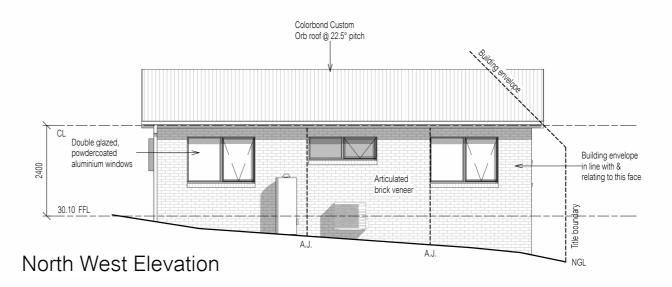




South East Elevation



South West Elevation



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REVISION	DATE	DESCRIPTION

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DRAWING:

ELEVATIONS

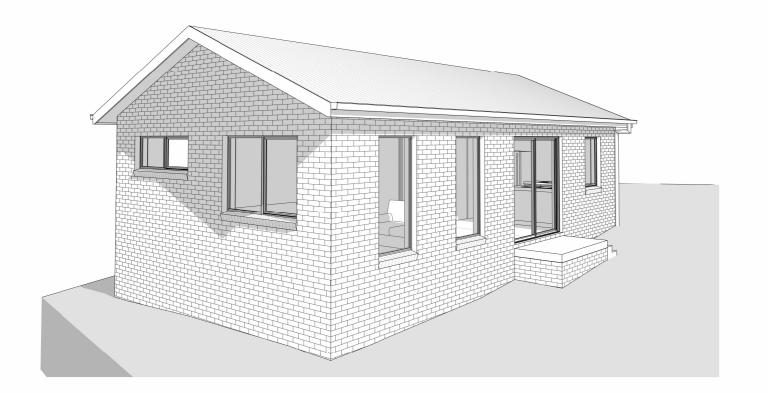
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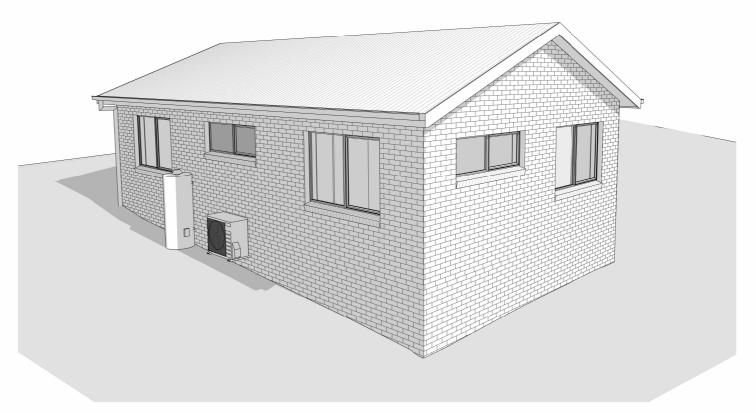
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DRAWING: PERSPECTIVES

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