

### Land Use Planning and Approvals Act 1993

APPLICATION NO.

DA2024/234

LOCATION OF AFFECTED AREA

**7 SILVERGUM STREET, BRIGHTON** 

DESCRIPTION OF DEVELOPMENT PROPOSAL

### **MULTIPLE DWELLINGS X 7**

A COPY OF THE DEVELOPMENT APPLICATION MAY BE VIEWED AT <a href="https://www.brighton.tas.gov.au">www.brighton.tas.gov.au</a> AND AT THE COUNCIL OFFICES, 1 TIVOLI ROAD, OLD BEACH, BETWEEN 8:15 A.M. AND 4:45 P.M, MONDAY TO FRIDAY OR VIA THE QR CODE BELOW. ANY PERSON MAY MAKE WRITTEN REPRESENTATIONS IN ACCORDANCE WITH S.57(5) OF THE LAND USE PLANNING AND APPROVALS ACT 1993 CONCERNING THIS APPLICATION UNTIL 4:45 P.M. ON 14/04/2025. ADDRESSED TO THE CHIEF EXECUTIVE OFFICER AT 1 TIVOLI ROAD, OLD BEACH, 7017 OR BY EMAIL

AT

development@brighton.tas.gov.au.

REPRESENTATIONS SHOULD INCLUDE A DAYTIME TELEPHONE NUMBER TO ALLOW COUNCIL OFFICERS TO DISCUSS, IF NECESSARY, ANY MATTERS RAISED.

JAMES DRYBURGH
Chief Executive Officer





# PINNACLE

# PINACLE

## 7 Silvergum Street, Brighton 7030

Owner(s) or Clients

Building Classification

Designer

Total Floor Area (Combined)

Alpine Area

Other Hazards (e.g., High wind, earthquake, flooding, landslip, dispersive soils, sand dunes, mine subsidence, landfill, snow & ice, or other relevant factors) Huntingfield Developments 8 x 1a Dwellings

Jason Nickerson CC6073Y

1020.36m<sup>2</sup> N/A

Burrows Avenue SAP BRI-S12

Title Reference
Zoning

186843/18 General Residential

Land Size
Design Wind Speed
Soil Classification
Climate Zone

Climate Zone
Corrosion Environment
Bushfire Attack Level (BAL)

Low


2,734m<sup>2</sup>

TBA

TBA

ID	Sheet Name	Issue
A0.01	Location Plan	DA - 03
A0.02	Site Plan	DA - 03
A2.01	U1 - Floor Plan	DA - 03
A2.02	U1 - Elevations	DA - 03
A3.01	U2 - Floor Plan	DA - 03
A3.02	U2 - Elevations	DA - 03
A4.01	U3 - Floor Plan	DA - 03
A4.02	U3 - Elevations	DA - 03
A5.01	U4 - Floor Plan	DA - 03
A5.02	U4 - Elevations	DA - 03
A6.01	U5 - Floor Plan	DA - 03
A6.02	U5 - Elevations	DA - 03
A7.01	U6 - Floor Plan	DA - 03
A7.02	U6 - Elevations	DA - 03
A8.01	U7 - Floor Plan	DA - 03
A8.02	U7 - Elevations	DA - 03
C.01	Parking & Driveway Plan	DA - 03
L.01	Landscaping Plan	DA - 03
L.02	Planting Schedule & Details	DA - 03



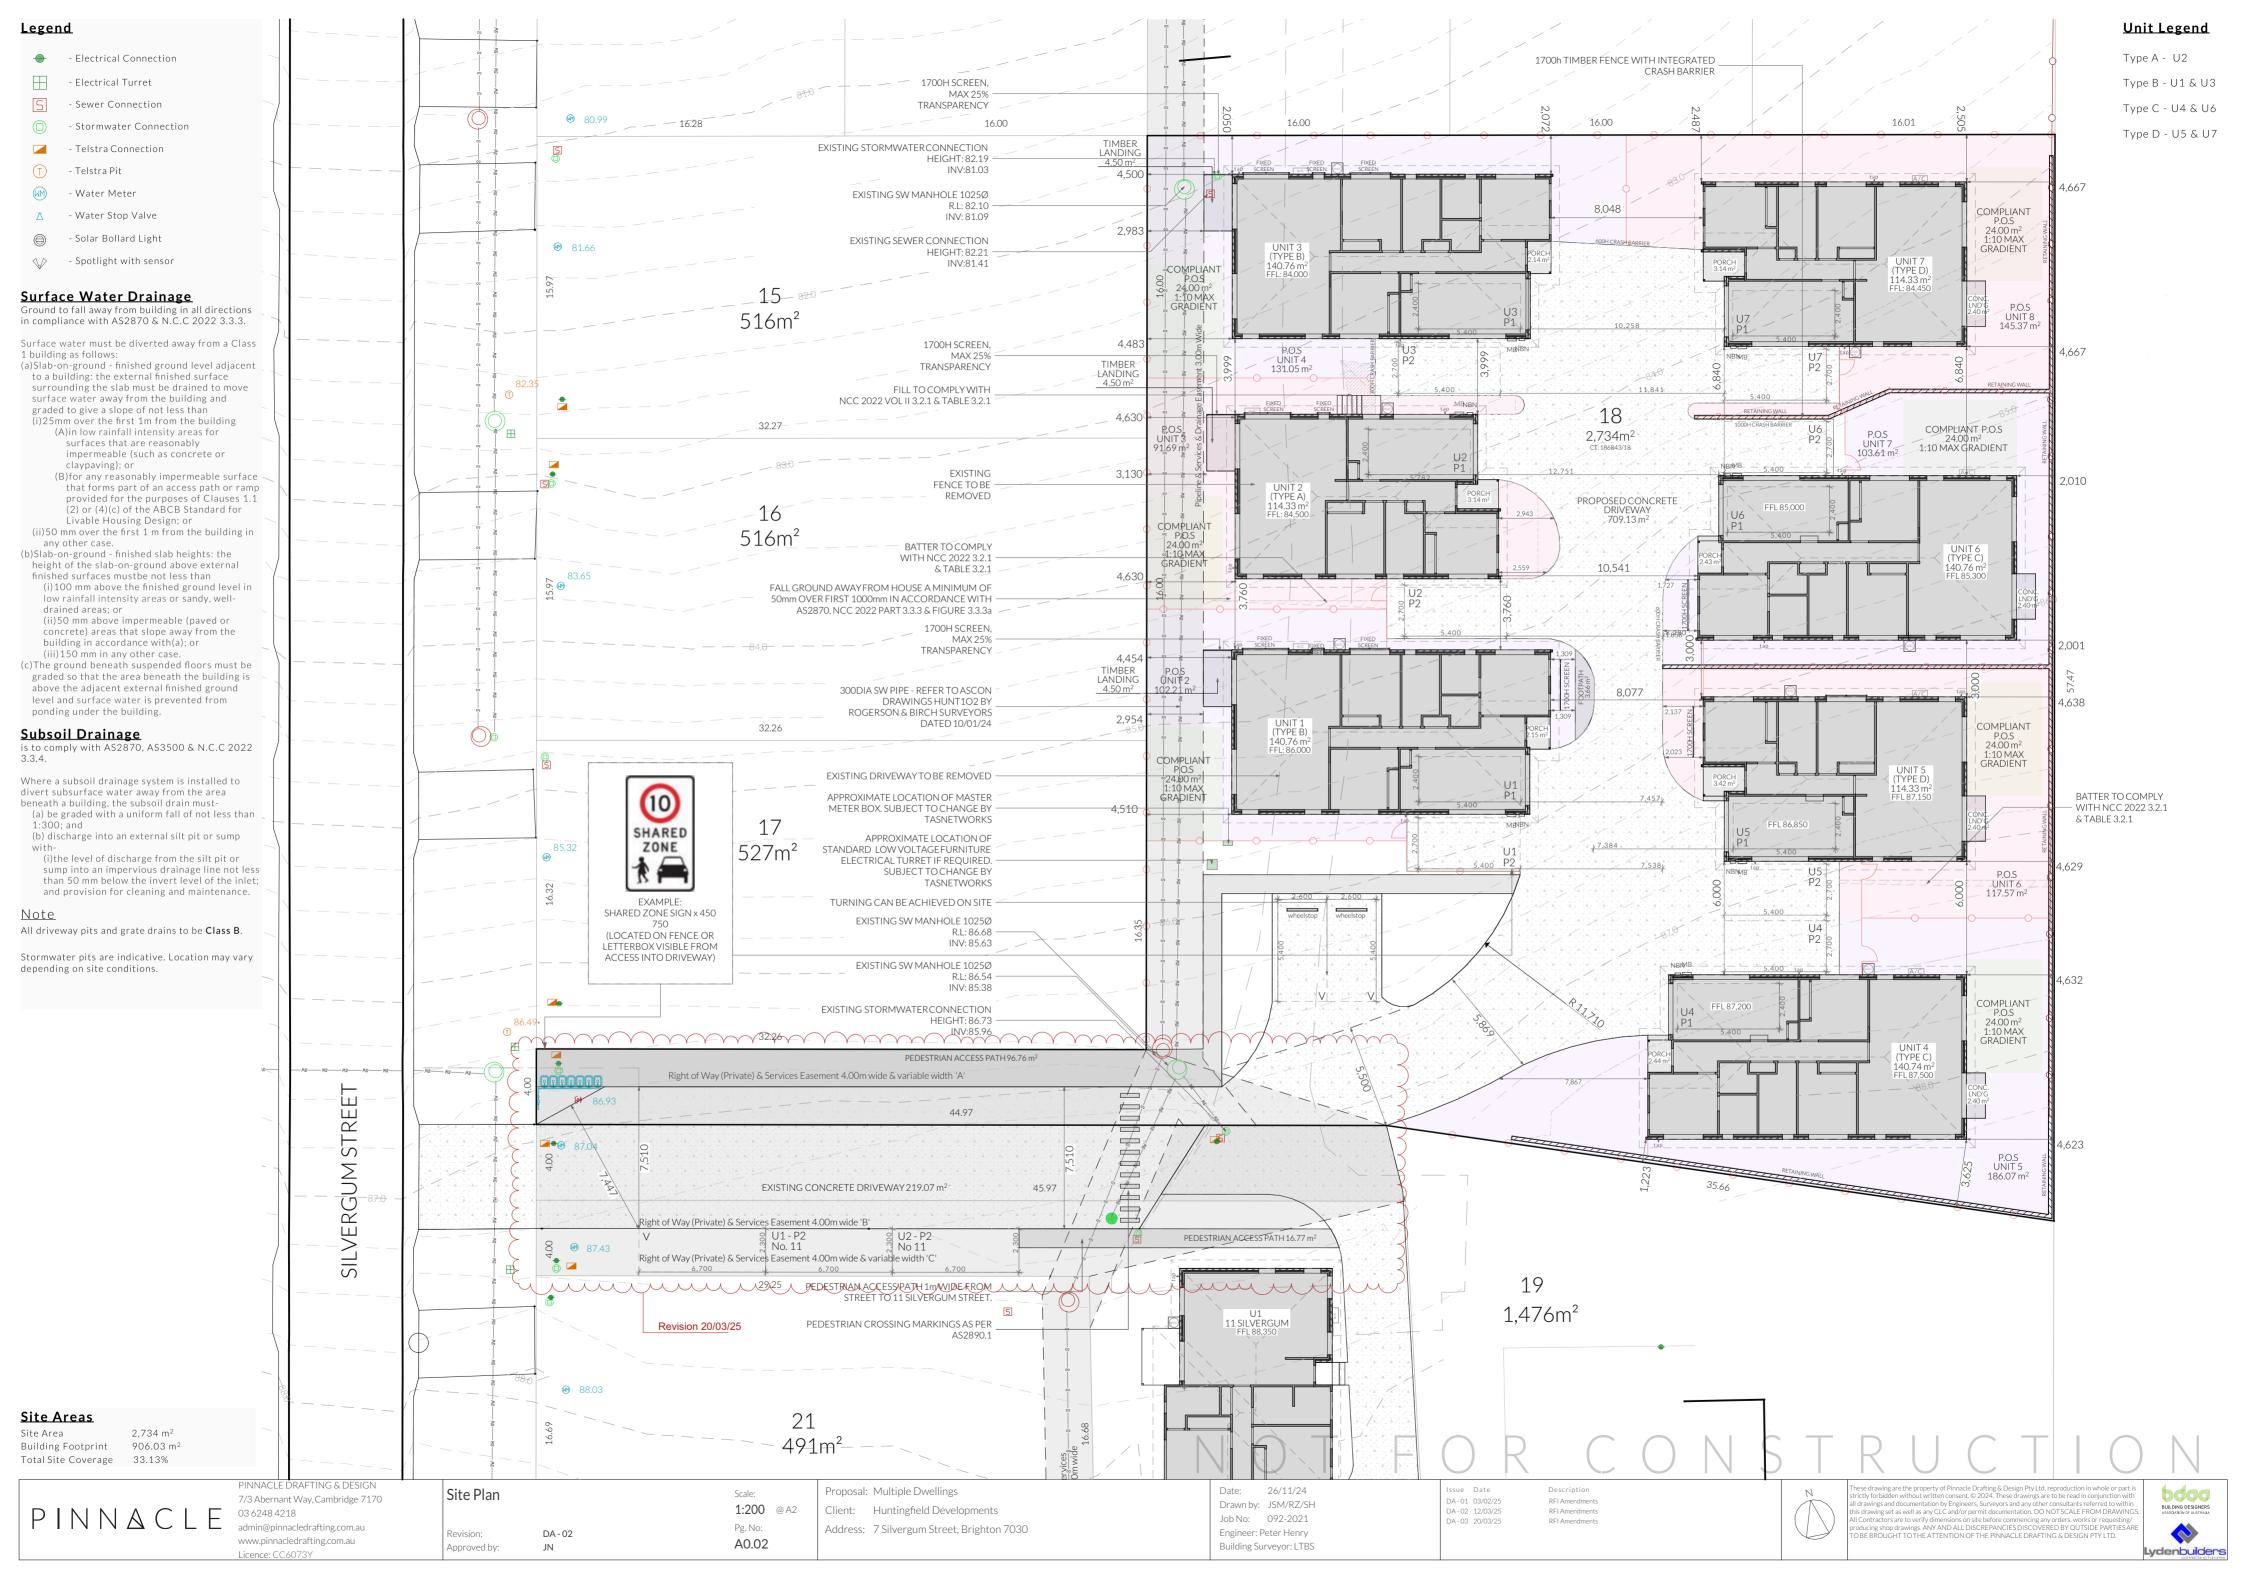

Type D - U5 & U7

Unit Legend

### Construction of sanitary

compartments 10.4.2 of NCC 2022
The door to a fully enclosed sanitary compartment must -

· open outwards; or

slide; orbe readily removable fr

 $\boldsymbol{\cdot}$  be readily removable from the outside of the compartment.

unless there is a clear space of at least 1.2 m, measured in accordance with Figure 10.4.2 of NCC 2022 Vol II, between the closet pan within the sanitary compartment and the doorway.

### Note: Safe Movement & Egress

Openable windows greater than 4m above the surface below are to be fitted with a device to limit opening or a suitable screen so a 125mm sphere cannot pass through. Except for Bedrooms, where the requirement is for heights above 2m. Refer to clauses 11.3.7 and 11.3.8 of NCC 2022 for further information on suitable protective devices.

### Note: Paved Areas

All paths and patios to fall away from dwelling.

### Note: Stair Construction

All stairs to be constructed in accordance with NCC Vol II 2022 Part 11.2.2:
Riser: Min 115mm - Max 190mm
Going: Min 240mm - Max 355mm
Slope (2R+G): Max 550 - Min 700
For stairways serving non-habitable room used infrequently, refer to table 11.2.2(b).

Landings to comply with Clause 11.2.5 and be a minimum of  $750\,\text{mm}$  deep measured  $500\,\text{mm}$  from the inside edge of the landing.

Slip resistance of treads, nosings and ramps to comply with Clause 11.2.4.


### Heights of rooms & other spaces

### 10.3.1 of NCC 2022

landing or the like.

Heights of rooms and other spaces must not be less than;
(a)in a habitable room excluding a kitchen - 2.4 m; and
(b)in a kitchen - 2.1 m; and
(c)in a corridor, passageway or the like - 2.1 m; and
(d)in a bathroom, shower room, laundry, sanitary compartment, airlock, pantry, storeroom, garage, car parking area or the like - 2.1 m; and
(e)in a room or space with a sloping ceiling or projections below the ceiling line within- See NCC directly for these items
(f)in a stairway, ramp, landing, or the like - 2.0 m measured vertically above the nosing line of stairway treads or the floor surface of a ramp,

If required onsite, the builder may work within the tolerances of the above as specified within the NCC 2022 Vol II. Builder to contact *Pinnacle* before undertaking works.

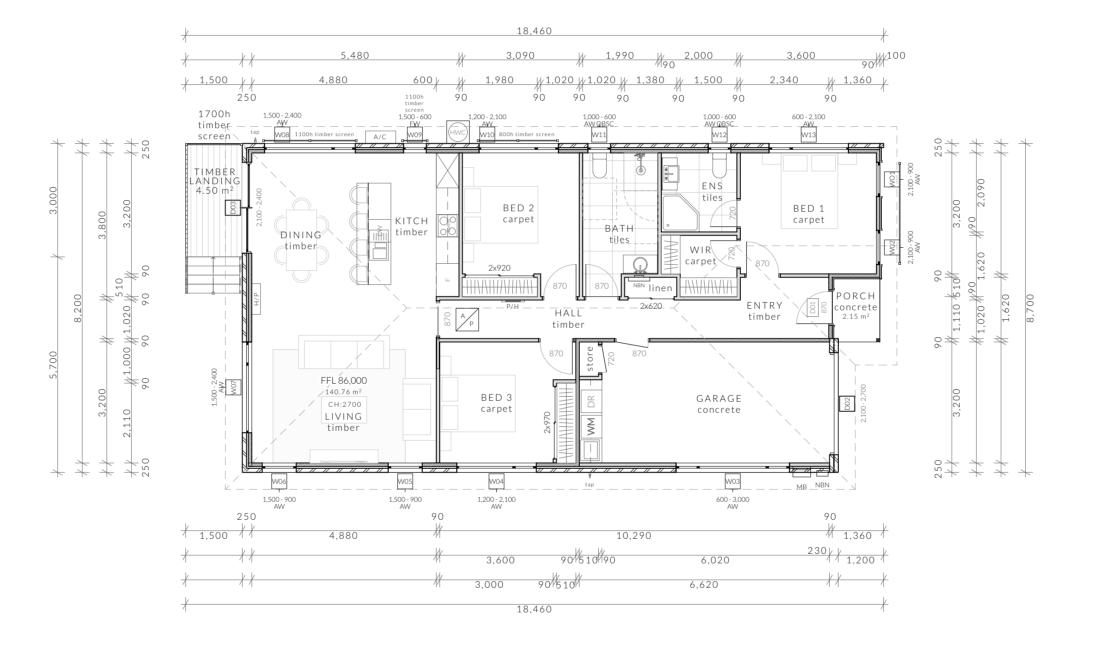

### Floor Areas

Porch

Total Floor Area 140.76m<sup>2</sup>
Timber Landing 4.50m<sup>2</sup>

PINNACLE

2.15m<sup>2</sup>

PINNACLE DRAFTING & DESIGN 7/3 Abernant Way, Cambridge 7170 03 6248 4218 admin@pinnacledrafting.com.au www.pinnacledrafting.com.au

Licence: CC6073Y

U1 - Floor Plan

Revision:

Approved by:

DA - 02

JN

1:100 Pg. No: A2.01

Scale: Proposal: Multiple Dwellings

1:100 @ A2 Client: Huntingfield Developments

Pg. No: Address: 7 Silvergum Street, Brighton 7030

Date: 26/11/24
Drawn by: JSM/RZ/SH
Job No: 092-2021
Engineer: Peter Henry
Building Surveyor: LTBS


DA-01 03/02/25 DA-02 12/03/25 DA-03 20/03/25

Description RFI Amendments RFI Amendments RFI Amendments



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Engineer: Peter Henry

Building Surveyor: LTBS

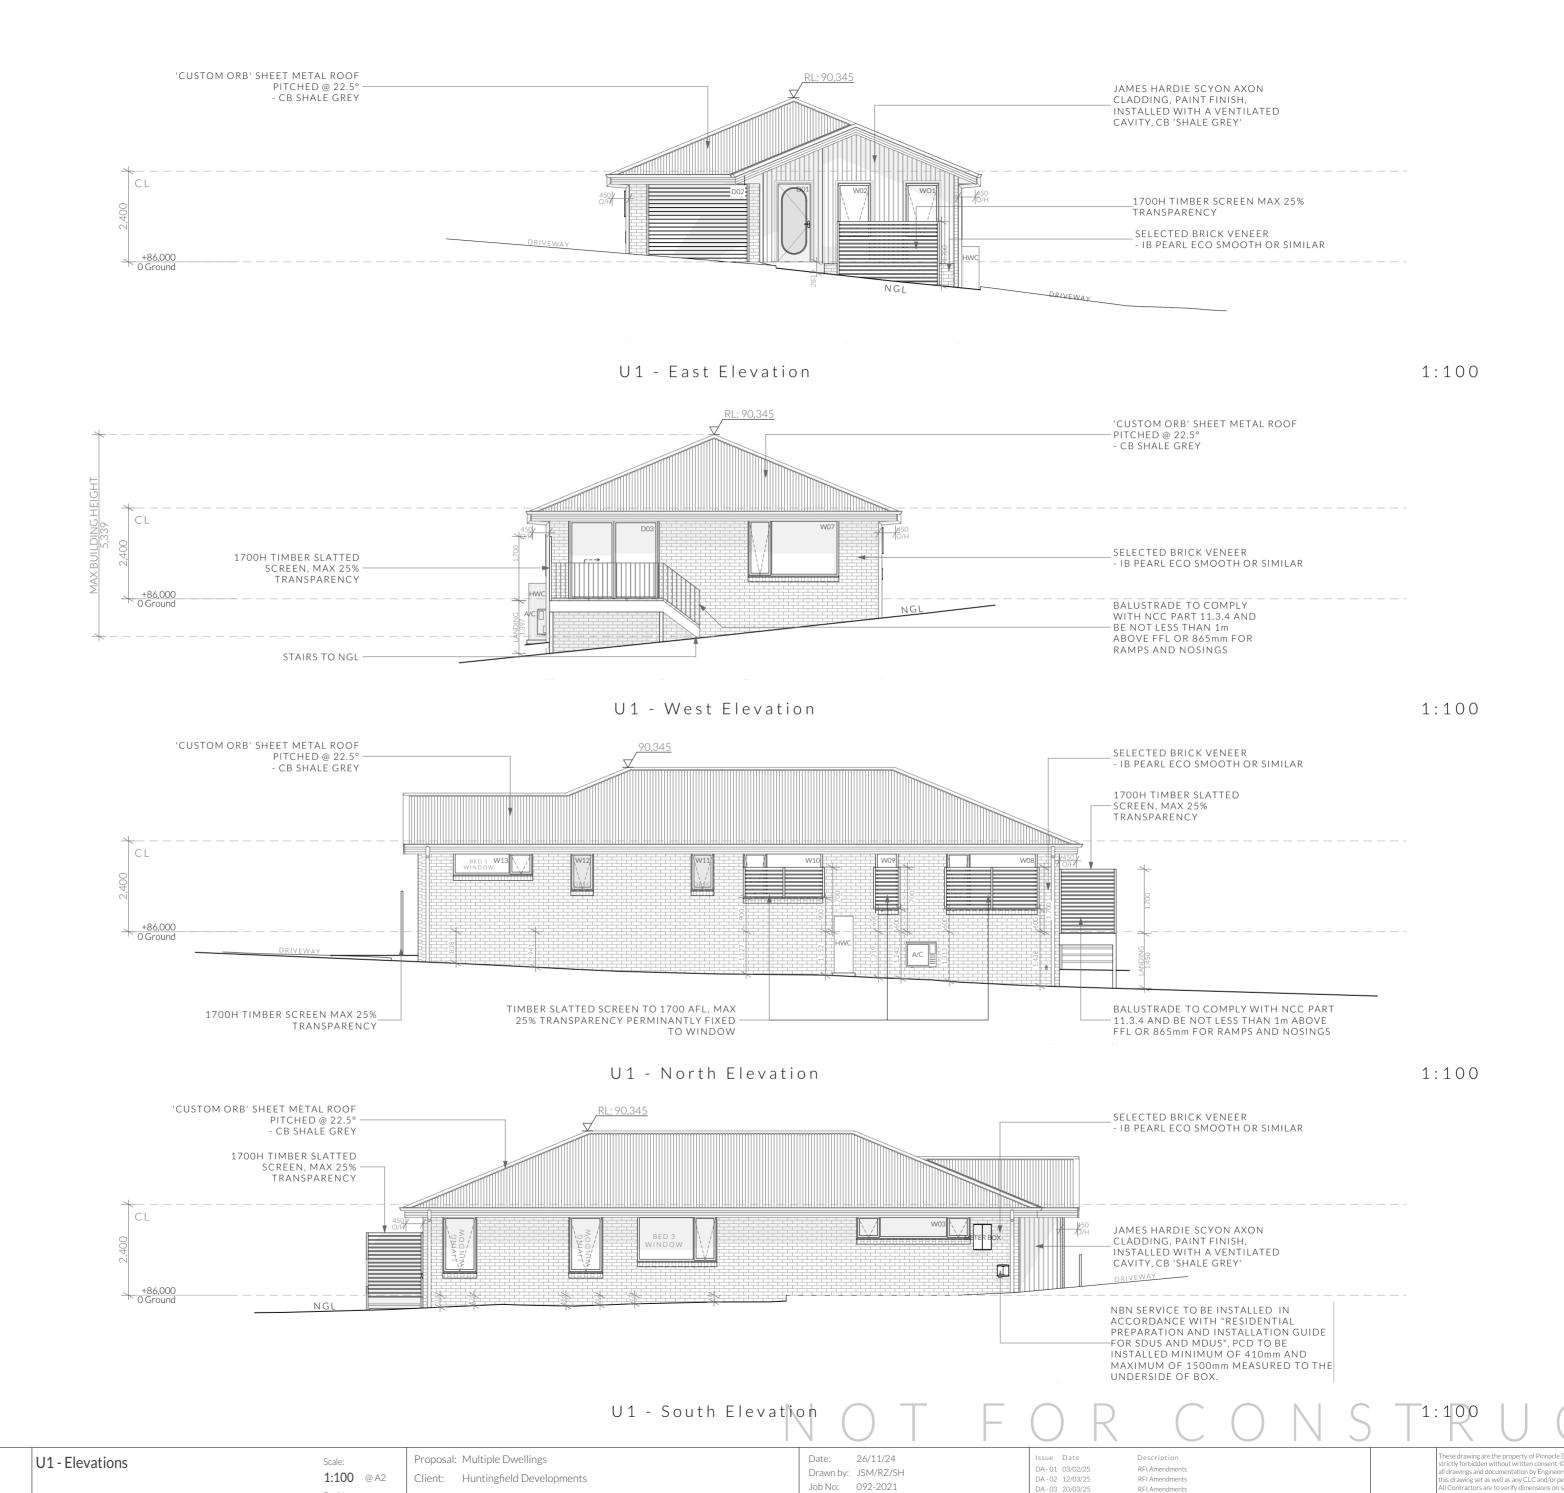Lydenbuilders

Clearances between cladding and ground shall comply with Clause 7.5.7 of the NCC

100mm in low rainfall intensity areas or sandy, well-drained areas; or 50mm above

impermeable areas that slope away from the building; or 150mm in any other case. Wall cladding must extend a minimum of 50 mm below the bearer or lowest

U.N.O in builders specifications or located in saline environments or if using a glazed

Openable windows greater than 4m above ground level are to be fitted with a device to limit the opening or a suitable screen so a 125mm sphere cannot pass through, and withstand a force of 250N. Except for bedrooms, where the requirement is for

Going: Min 240mm - Max 355mm

03 6248 4218

Licence: CC6073Y

PINNACLE DRAFTING & DESIGN

7/3 Abernant Way, Cambridge 7170

Pg. No:

A2.02

DA - 02

JN

Revision:

Approved by:

Address: 7 Silvergum Street, Brighton 7030

admin@pinnacledrafting.com.au

www.pinnacledrafting.com.au

All stairs to be constructed in accordance with NCC 2022 Vol II Part 11.2.2 Riser: Min 115mm - Max 190mm Going: Min 240mm - Max 355

finish brick, brickwork is to be installed in stretcher bond pattern with raked joints.

2022 and shall be a minimum clearance of:

As per NCC parts 11.3.7 and 11.3.8,

Slope (2R+G): Max 550 - Min 700

heights above 2m.

horizontal part of the suspended floor framing.

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Smoke Alarm

### Construction of sanitary

compartments 10.4.2 of NCC 2022 The door to a fully enclosed sanitary compartment

open outwards; or slide; or

be readily removable from the outside of the compartment.

unless there is a clear space of at least 1.2 m, measured in accordance with Figure 10.4.2 of NCC 2022 Vol II, between the closet pan within the sanitary compartment and the doorway.

### Note: Safe Movement & Egress Openable windows greater than 4m above the surface below are to be fitted with a device to limit opening or a suitable screen so a 125mm sphere cannot pass through. Except for Bedrooms, where the requirement is for heights above 2m. Refer to clauses 11.3.7 and 11.3.8 of NCC 2022 for further information on suitable protective devices.

### Note: Paved Areas

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Landings to comply with Clause 11.2.5 and be a minimum of 750mm deep measured 500mm from the inside edge of the landing.

Slip resistance of treads, nosings and ramps to comply with Clause 11.2.4.


### Heights of rooms & other spaces

### 10.3.1 of NCC 2022 Heights of rooms and other spaces must not be less

(a)in a habitable room excluding a kitchen - 2.4 m; and (b)in a kitchen - 2.1 m; and (c)in a corridor, passageway or the like - 2.1 m; and (d)in a bathroom, shower room, laundry, sanitary compartment, airlock, pantry, storeroom, garage, car parking area or the like - 2.1 m; and (e)in a room or space with a sloping ceiling or projections below the ceiling line within- See NCC

directly for these items (f)in a stairway, ramp, landing, or the like - 2.0 m measured vertically above the nosing line of stairway treads or the floor surface of a ramp, landing or the like.

If required onsite, the builder may work within the tolerances of the above as specified within the NCC 2022 Vol II. Builder to contact Pinnacle before undertaking works.

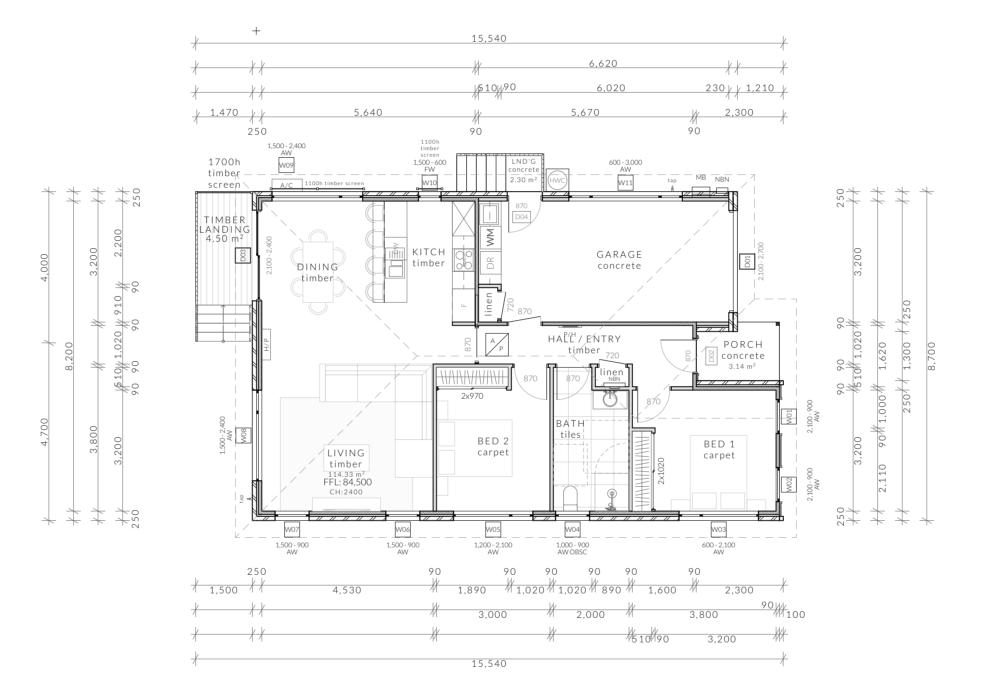

### Floor Areas

Total Floor Area 114.33m<sup>2</sup> 4.50m<sup>2</sup> Timber Landing Concrete Landing 2.30m<sup>2</sup>

PINNACLE DRAFTING & DESIGN 7/3 Abernant Way, Cambridge 7170 PINNACLE 03 6248 4218 admin@pinnacledrafting.com.au

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Licence: CC6073Y

U2 - Floor Plan

Revision:

Approved by:

DA - 02

JN

Proposal: Multiple Dwellings 1:100 @ A2 Client: Huntingfield Developments Address: 7 Silvergum Street, Brighton 7030

Scale:

Pg. No:

A3.01


Date: 26/11/24 Drawn by: JSM/RZ/SH Job No: 092-2021 Engineer: Peter Henry Building Surveyor: LTBS

DA-01 03/02/25 DA-02 12/03/25 DA-03 20/03/25







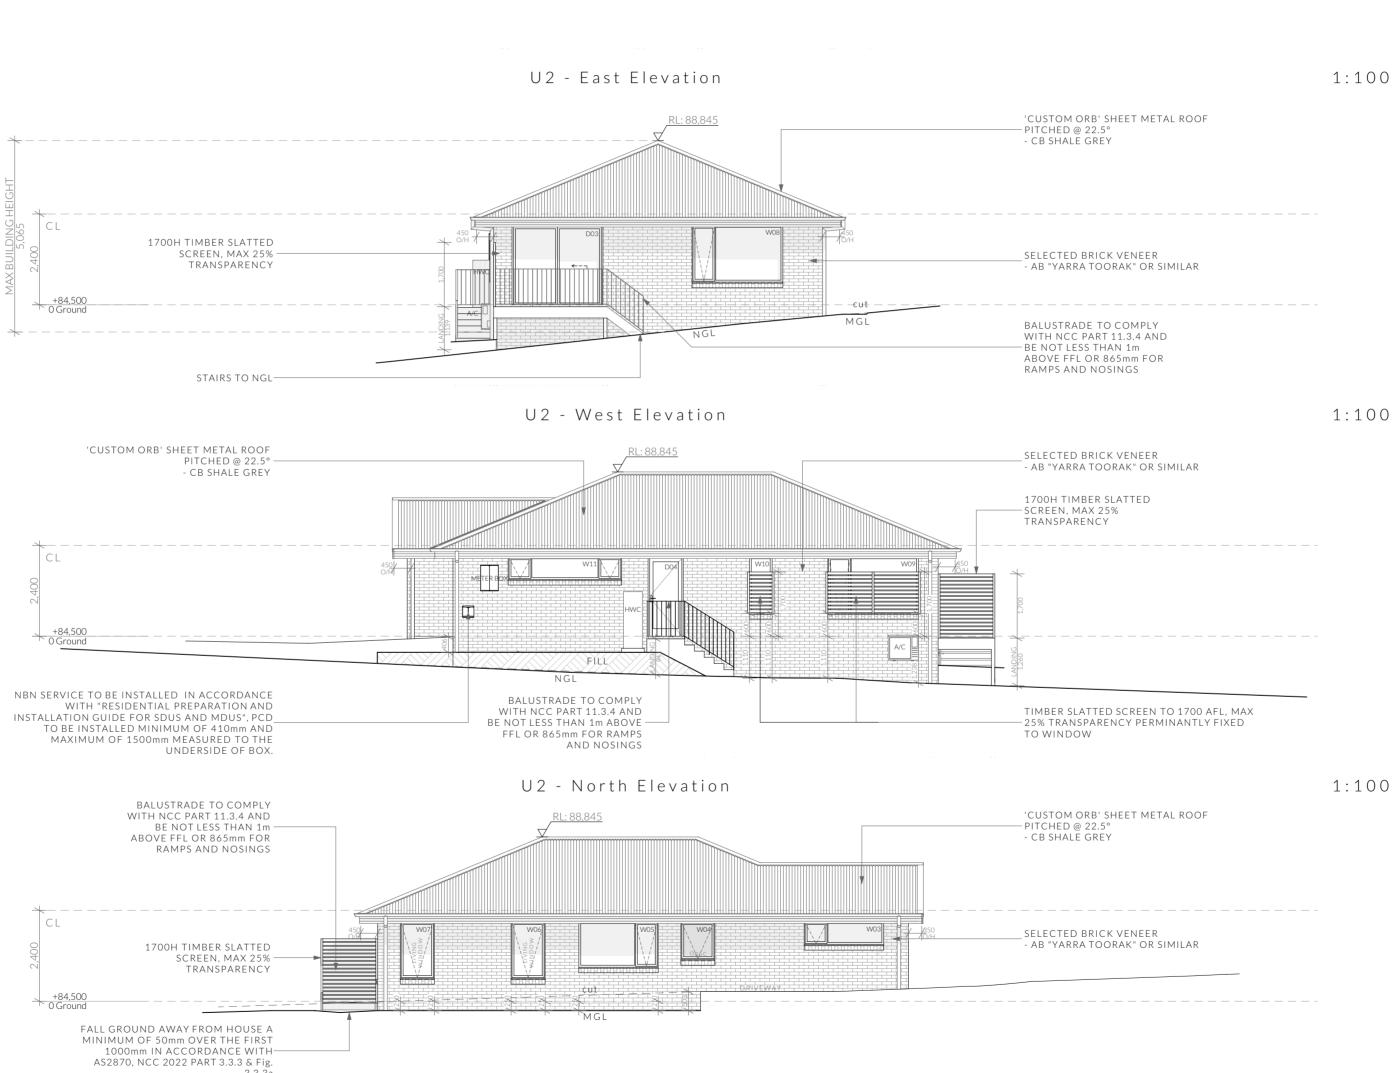

Clearances between cladding and ground shall comply with Clause 7.5.7 of the NCC 2022 and shall be a minimum clearance of:

100mm in low rainfall intensity areas or sandy, well-drained areas; or 50mm above impermeable areas that slope away from the building; or 150mm in any other case.

Wall cladding must extend a minimum of 50 mm below the bearer or lowest horizontal part of the suspended floor framing.

U.N.O in builders specifications or located in saline environments or if using a glazed finish brick, brickwork is to be installed in stretcher bond pattern with raked joints.

As per NCC parts 11.3.7 and 11.3.8, Openable windows greater than 4m above ground level are to be fitted with a device to limit the opening or a suitable screen so a 125mm sphere cannot pass through, and withstand a force of 250N. Except for bedrooms, where the requirement is for heights above 2m.

All stairs to be constructed in accordance with NCC 2022 Vol II Part 11.2.2 Riser: Min 115mm - Max 190mm Going: Min 240mm - Max 35 Going: Min 240mm - Max 355mm Slope (2R+G): Max 550 - Min 700

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Licence: CC6073Y

U2 - Elevations Scale: DA - 02 Revision: Approved by: JN

1:100 @ A2 Pg. No: A3.02

Proposal: Multiple Dwellings Client: Huntingfield Developments Address: 7 Silvergum Street, Brighton 7030

26/11/24 Drawn by: JSM/RZ/SH Job No: 092-2021 Engineer: Peter Henry Building Surveyor: LTBS

U2 -South Elevation



Type C - U4 & U6

Type D - U5 & U7

### Construction of sanitary

compartments 10.4.2 of NCC 2022 The door to a fully enclosed sanitary compartment

open outwards; or slide; or

be readily removable from the outside of the compartment.

unless there is a clear space of at least 1.2 m, measured in accordance with Figure 10.4.2 of NCC 2022 Vol II, between the closet pan within the sanitary compartment and the doorway.

### Note: Safe Movement & Egress

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### Note: Paved Areas

All paths and patios to fall away from dwelling.

### Note: Stair Construction

All stairs to be constructed in accordance with NCC Vol II 2022 Part 11.2.2: Riser: Min 115mm - Max 190mm Going: Min 240mm - Max 355mm Slope (2R+G): Max 550 - Min 700 For stairways serving non-habitable room used infrequently, refer to table 11.2.2(b).

Landings to comply with Clause 11.2.5 and be a minimum of 750mm deep measured 500mm from the inside edge of the landing.

Slip resistance of treads, nosings and ramps to comply with Clause 11.2.4.


### Heights of rooms & other spaces

10.3.1 of NCC 2022 Heights of rooms and other spaces must not be less

landing or the like.

(a)in a habitable room excluding a kitchen - 2.4 m; and (b)in a kitchen - 2.1 m; and (c)in a corridor, passageway or the like - 2.1 m; and (d)in a bathroom, shower room, laundry, sanitary compartment, airlock, pantry, storeroom, garage, car parking area or the like - 2.1 m; and (e)in a room or space with a sloping ceiling or projections below the ceiling line within- See NCC directly for these items (f)in a stairway, ramp, landing, or the like - 2.0 m measured vertically above the nosing line of stairway treads or the floor surface of a ramp,

If required onsite, the builder may work within the tolerances of the above as specified within the NCC 2022 Vol II. Builder to contact Pinnacle before undertaking works.

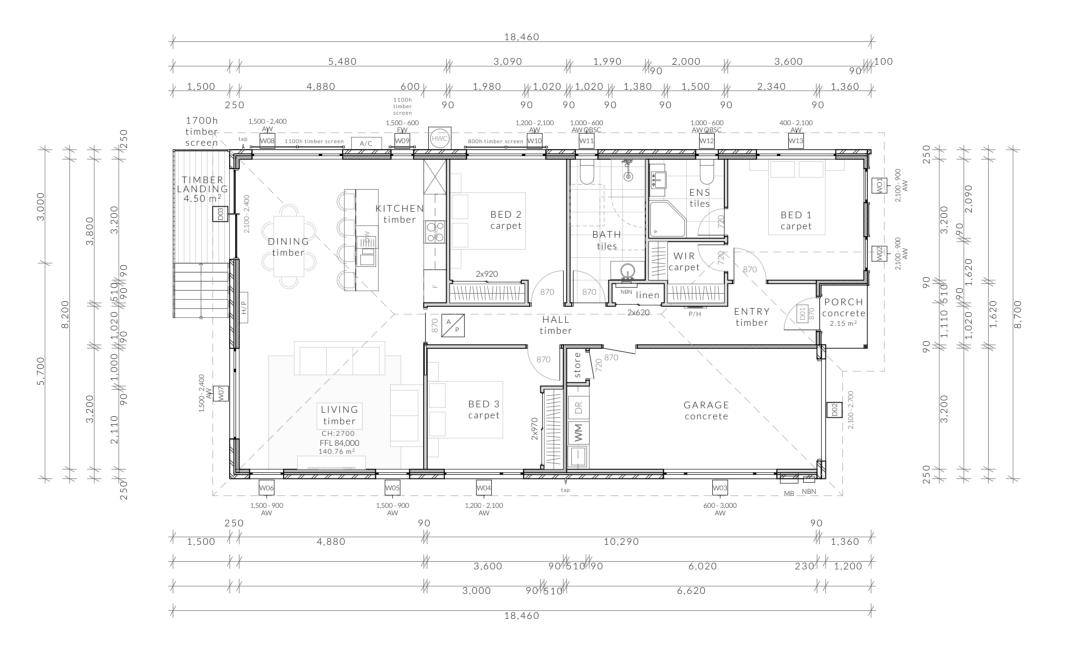

### Floor Areas

Total Floor Area 140.76m<sup>2</sup> Landing  $4.50m^{2}$ 2.15 m<sup>2</sup>Porch

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U3 - Floor Plan

Revision:

Approved by:

DA - 02

JN


Pg. No: A4.01

Proposal: Multiple Dwellings Scale: 1:100 @ A2 Client: Huntingfield Developments Address: 7 Silvergum Street, Brighton 7030 Date: 26/11/24 Drawn by: JSM/RZ/SH Job No: 092-2021 Engineer: Peter Henry Building Surveyor: LTBS

DA-01 03/02/25 DA-02 12/03/25 DA-03 20/03/25





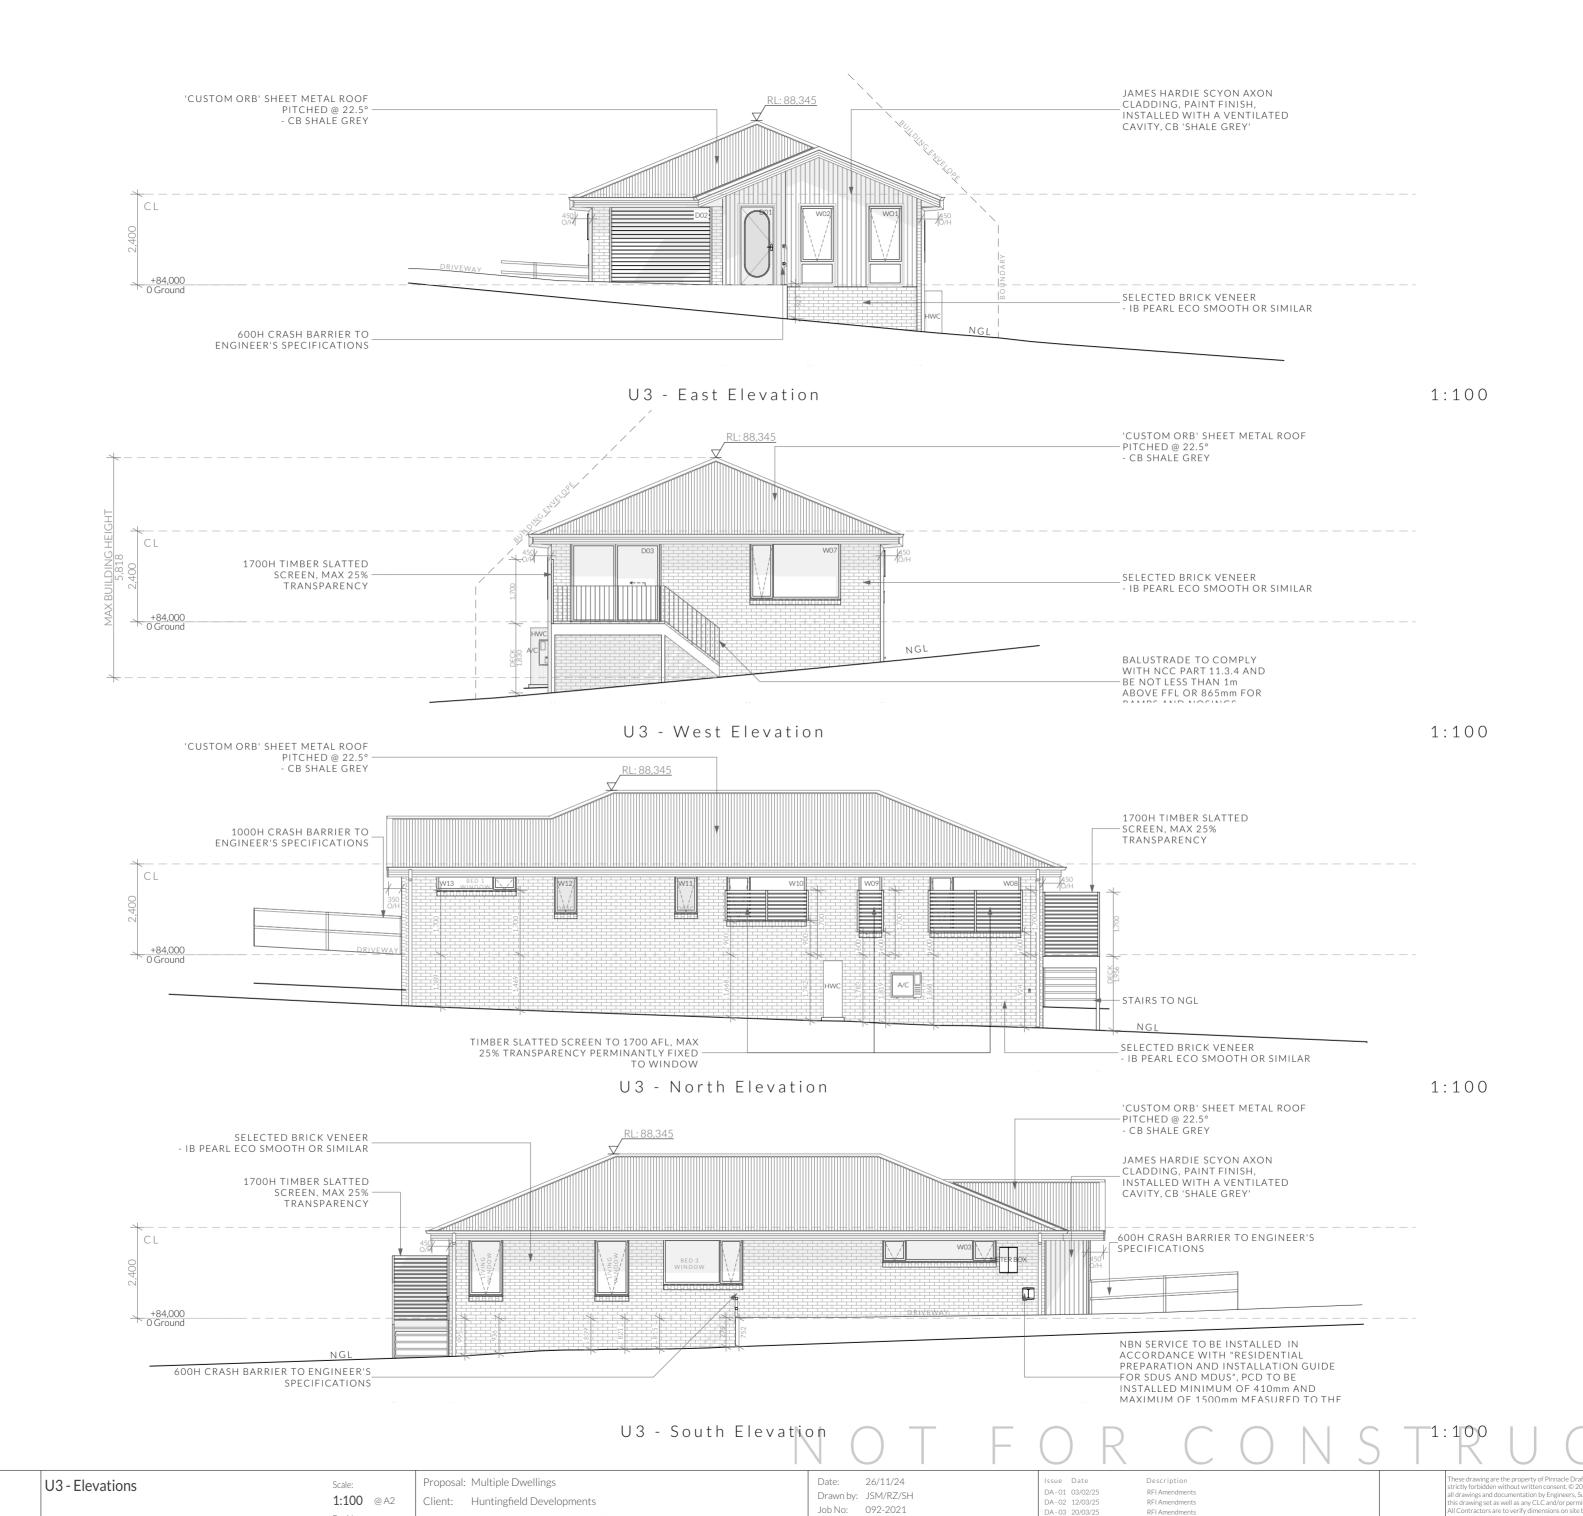

Engineer: Peter Henry

Building Surveyor: LTBS

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2022 and shall be a minimum clearance of:

As per NCC parts 11.3.7 and 11.3.8,

Slope (2R+G): Max 550 - Min 700

heights above 2m.

horizontal part of the suspended floor framing.

Clearances between cladding and ground shall comply with Clause 7.5.7 of the NCC

100mm in low rainfall intensity areas or sandy, well-drained areas; or 50mm above

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to limit the opening or a suitable screen so a 125mm sphere cannot pass through, and withstand a force of 250N. Except for bedrooms, where the requirement is for

Going: Min 240mm - Max 355mm

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Licence: CC6073Y

PINNACLE DRAFTING & DESIGN

7/3 Abernant Way, Cambridge 7170

Pg. No:

A4.02

DA - 02

JN

Revision:

Approved by:

Address: 7 Silvergum Street, Brighton 7030

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finish brick, brickwork is to be installed in stretcher bond pattern with raked joints.

Wall cladding must extend a minimum of 50 mm below the bearer or lowest

All stairs to be constructed in accordance with NCC 2022 Vol II Part 11.2.2 Riser: Min 115mm - Max 190mm Going: Min 240mm - Max 355

Type D - U5 & U7

### Construction of sanitary compartments 10.4.2 of NCC 2022 The door to a fully enclosed sanitary compartment

open outwards; or

slide; or be readily removable from the outside of the compartment.

unless there is a clear space of at least 1.2 m, measured in accordance with Figure 10.4.2 of NCC 2022 Vol II, between the closet pan within the sanitary compartment and the doorway.

### Note: Safe Movement & Egress Openable windows greater than 4m above the

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### Note: Paved Areas

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Landings to comply with Clause 11.2.5 and be a minimum of 750mm deep measured 500mm from the inside edge of the landing.

Slip resistance of treads, nosings and ramps to comply with Clause 11.2.4.


### Heights of rooms & other spaces 10.3.1 of NCC 2022

Heights of rooms and other spaces must not be less

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If required onsite, the builder may work within the tolerances of the above as specified within the NCC 2022 Vol II. Builder to contact *Pinnacle* before undertaking works.

landing or the like.

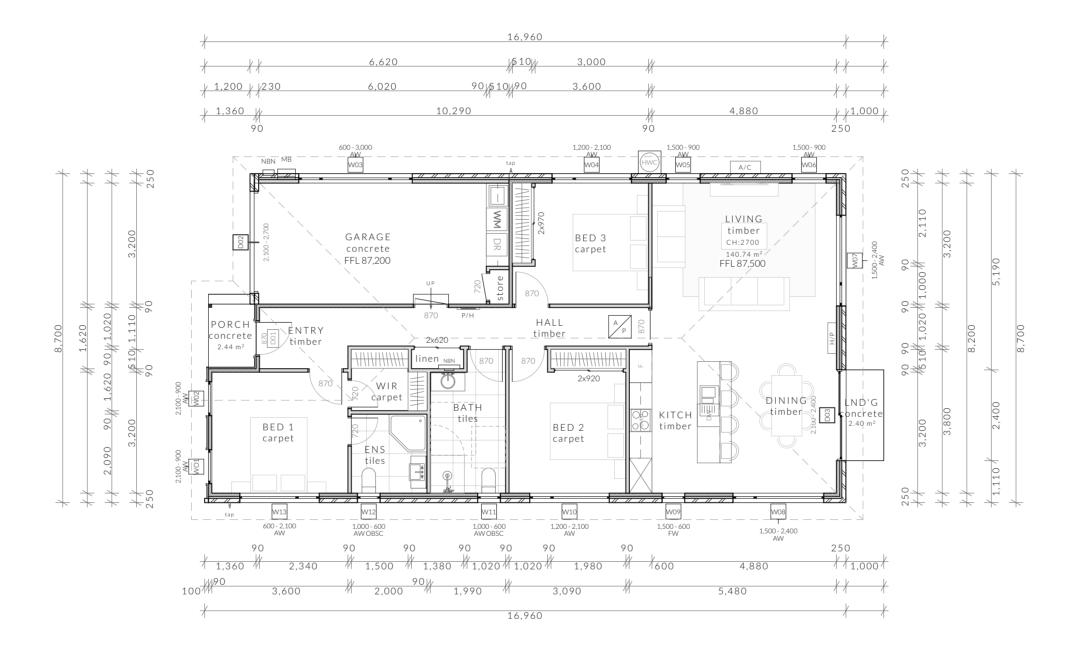

### Floor Areas

Total Floor Area 140.74m<sup>2</sup> Porch 2.44m<sup>2</sup> Concrete Landing 2.40m<sup>2</sup>

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Licence: CC6073Y

U4 - Floor Plan

DA - 02 Revision: Approved by: JN

Scale: 1:100 @ A2 Pg. No:


A5.01

Proposal: Multiple Dwellings Client: Huntingfield Developments Address: 7 Silvergum Street, Brighton 7030 Date: 26/11/24 Drawn by: JSM/RZ/SH Job No: 092-2021 Engineer: Peter Henry Building Surveyor: LTBS

DA-01 03/02/25 DA-02 12/03/25 DA-03 20/03/25





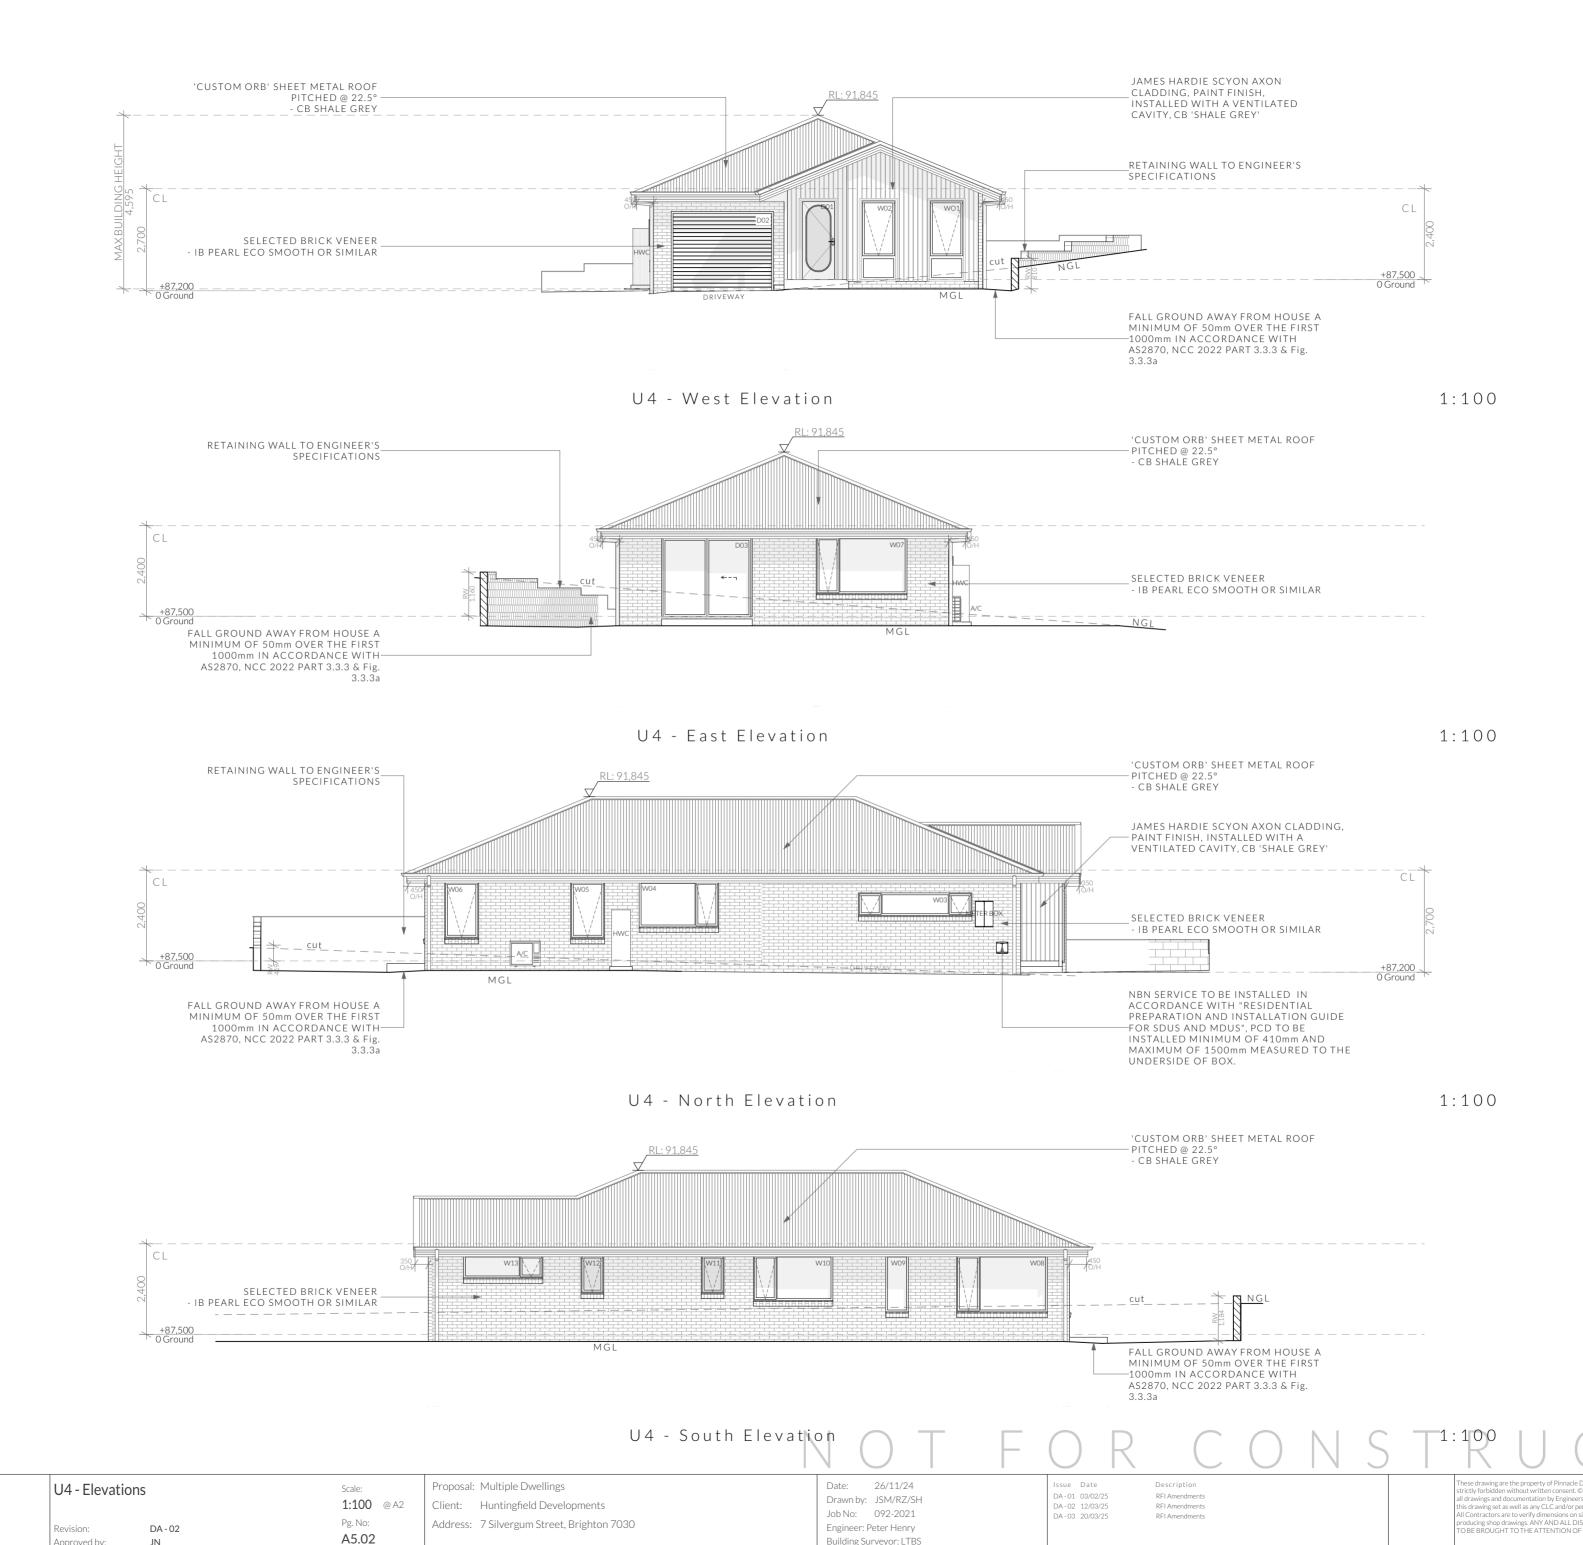

Building Surveyor: LTBS

Lydenbuilders

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2022 and shall be a minimum clearance of:

As per NCC parts 11.3.7 and 11.3.8,

Slope (2R+G): Max 550 - Min 700

heights above 2m.

horizontal part of the suspended floor framing.

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Going: Min 240mm - Max 355mm

03 6248 4218

Licence: CC6073Y

PINNACLE DRAFTING & DESIGN

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7/3 Abernant Way, Cambridge 7170

Approved by:

JN

finish brick, brickwork is to be installed in stretcher bond pattern with raked joints.

Wall cladding must extend a minimum of 50 mm below the bearer or lowest

All stairs to be constructed in accordance with NCC 2022 Vol II Part 11.2.2 Riser: Min 115mm - Max 190mm Going: Min 240mm - Max 355

Type D - U5 & U7

### — Articulation Joint Smoke Alarm

Construction of sanitary compartments 10.4.2 of NCC 2022 The door to a fully enclosed sanitary compartment

open outwards; or slide; or

be readily removable from the outside of the compartment.

unless there is a clear space of at least 1.2 m, measured in accordance with Figure 10.4.2 of NCC 2022 Vol II, between the closet pan within the sanitary compartment and the doorway.

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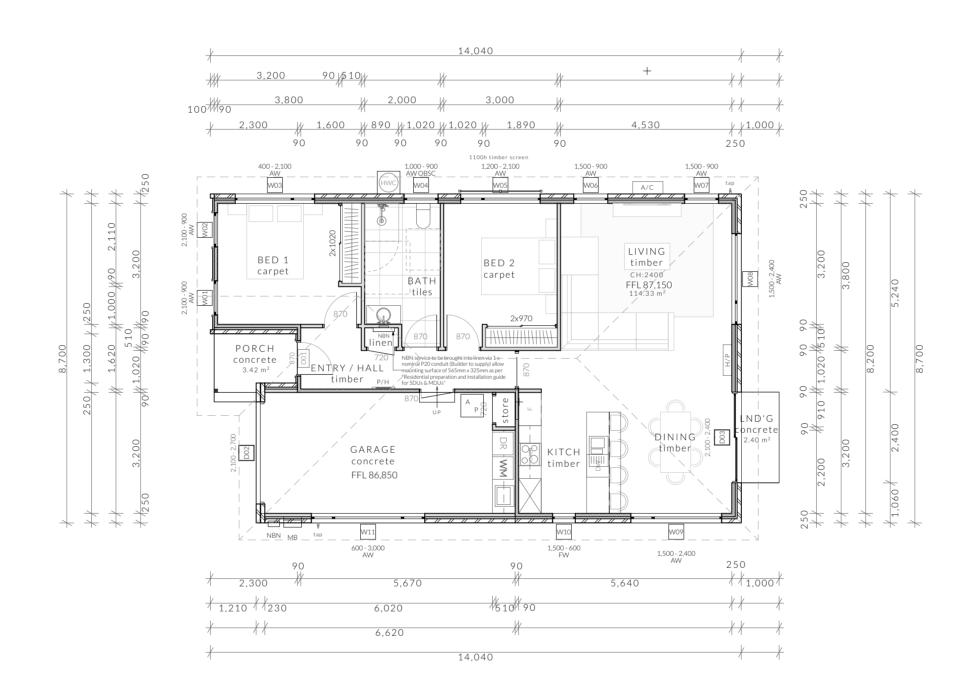
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### Floor Areas

Total Floor Area 114.33m² Porch 3.42m<sup>2</sup> Concrete Landing 2.40m<sup>2</sup>


Licence: CC6073Y

Approved by:

JN





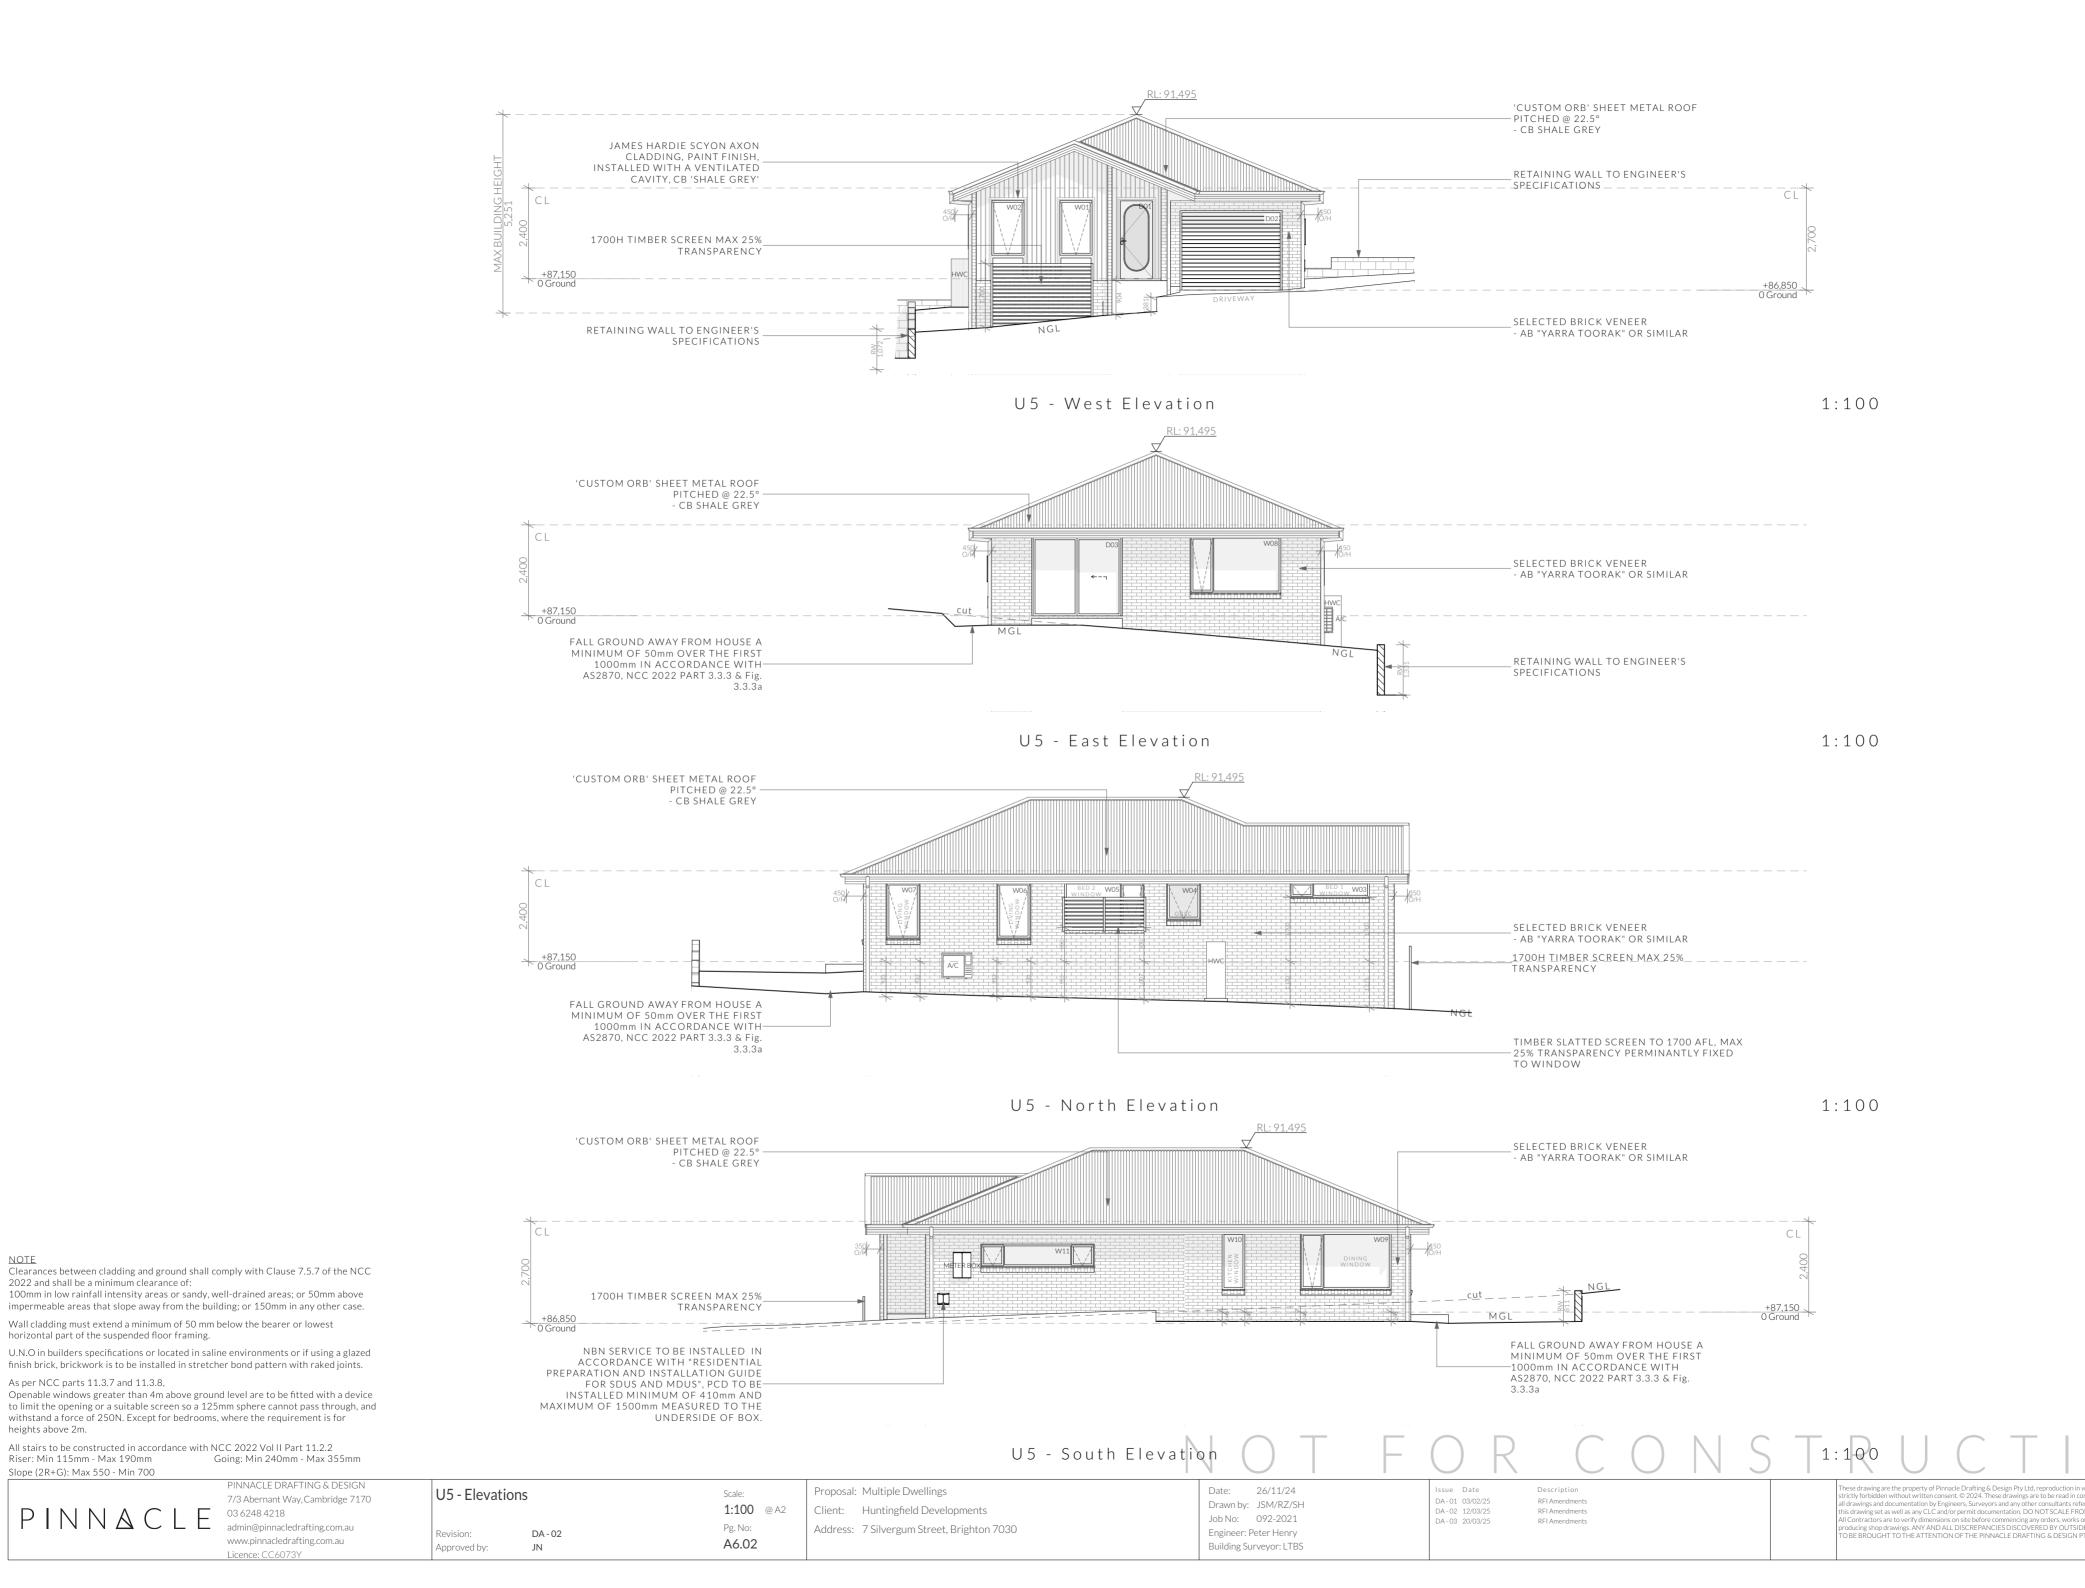

PINNACLE 03 6248 4218 www.pinnacledrafting.com.au

2022 and shall be a minimum clearance of:

horizontal part of the suspended floor framing.

As per NCC parts 11.3.7 and 11.3.8,

Slope (2R+G): Max 550 - Min 700

heights above 2m.

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Going: Min 240mm - Max 355mm

admin@pinnacledrafting.com.au

Licence: CC6073Y

Type D - U5 & U7

—A Articulation Joint Smoke Alarm

Construction of sanitary compartments 10.4.2 of NCC 2022 The door to a fully enclosed sanitary compartment

open outwards; or slide; or

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### Note: Paved Areas

All paths and patios to fall away from dwelling.

### Note: Stair Construction

All stairs to be constructed in accordance with NCC Vol II 2022 Part 11.2.2: Riser: Min 115mm - Max 190mm Going: Min 240mm - Max 355mm Slope (2R+G): Max 550 - Min 700 For stairways serving non-habitable room used infrequently, refer to table 11.2.2(b).

Landings to comply with Clause 11.2.5 and be a minimum of 750mm deep measured 500mm from the inside edge of the landing.

Slip resistance of treads, nosings and ramps to comply with Clause 11.2.4.


### Heights of rooms & other spaces 10.3.1 of NCC 2022

Heights of rooms and other spaces must not be less

(a)in a habitable room excluding a kitchen - 2.4 m; and (b)in a kitchen - 2.1 m; and (c)in a corridor, passageway or the like - 2.1 m; and (d)in a bathroom, shower room, laundry, sanitary compartment, airlock, pantry, storeroom, garage, car parking area or the like - 2.1 m; and (e)in a room or space with a sloping ceiling or projections below the ceiling line within- See NCC directly for these items (f)in a stairway, ramp, landing, or the like - 2.0 m measured vertically above the nosing line of stairway treads or the floor surface of a ramp,

If required onsite, the builder may work within the tolerances of the above as specified within the NCC 2022 Vol II. Builder to contact *Pinnacle* before undertaking works.

landing or the like.

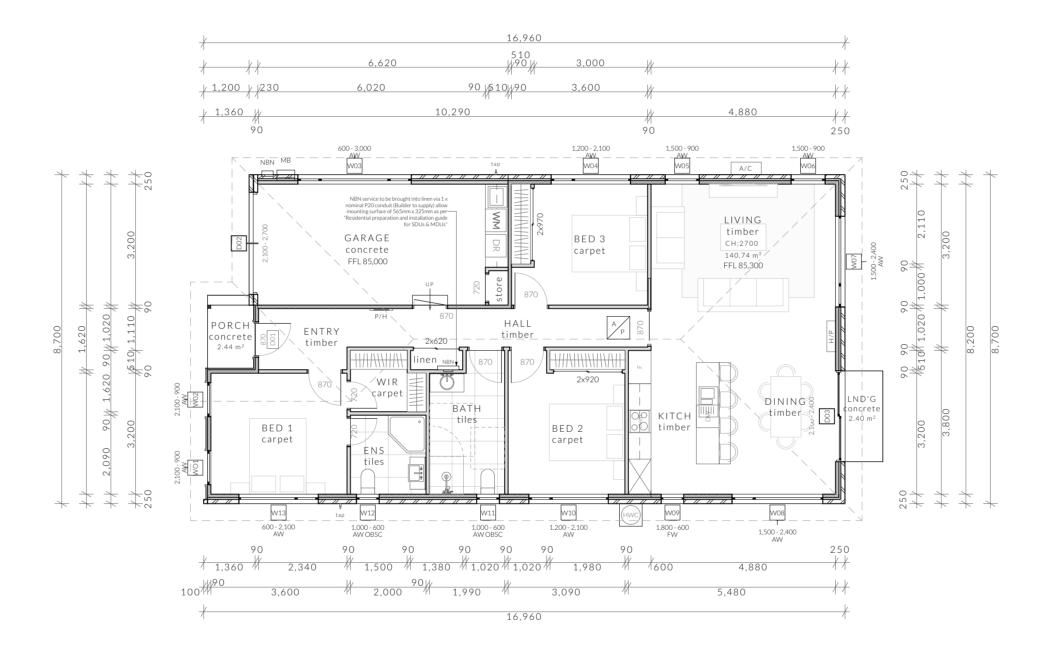

### Floor Areas

Total Floor Area 140.74m<sup>2</sup> 2.44m<sup>2</sup> 2.40m<sup>2</sup> Conc. Landing



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Approved by:

JN

A7.01









Building Surveyor: LTBS

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2022 and shall be a minimum clearance of:

horizontal part of the suspended floor framing.

As per NCC parts 11.3.7 and 11.3.8,

Slope (2R+G): Max 550 - Min 700

heights above 2m.

Clearances between cladding and ground shall comply with Clause 7.5.7 of the NCC

100mm in low rainfall intensity areas or sandy, well-drained areas; or 50mm above impermeable areas that slope away from the building; or 150mm in any other case.

U.N.O in builders specifications or located in saline environments or if using a glazed

Openable windows greater than 4m above ground level are to be fitted with a device to limit the opening or a suitable screen so a 125mm sphere cannot pass through, and withstand a force of 250N. Except for bedrooms, where the requirement is for

Going: Min 240mm - Max 355mm

03 6248 4218

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PINNACLE DRAFTING & DESIGN

admin@pinnacledrafting.com.au

www.pinnacledrafting.com.au

7/3 Abernant Way, Cambridge 7170

Approved by:

JN

finish brick, brickwork is to be installed in stretcher bond pattern with raked joints.

Wall cladding must extend a minimum of 50 mm below the bearer or lowest

All stairs to be constructed in accordance with NCC 2022 Vol II Part 11.2.2 Riser: Min 115mm - Max 190mm Going: Min 240mm - Max 35

Type D - U5 & U7

### — Articulation Joint

### Smoke Alarm

### Construction of sanitary compartments 10.4.2 of NCC 2022 The door to a fully enclosed sanitary compartment

open outwards; or

slide; or

be readily removable from the outside of the

unless there is a clear space of at least 1.2 m, measured in accordance with Figure 10.4.2 of NCC 2022 Vol II, between the closet pan within the sanitary compartment and the doorway.

### Note: Safe Movement & Egress

Openable windows greater than 4m above the surface below are to be fitted with a device to limit opening or a suitable screen so a 125mm sphere cannot pass through. Except for Bedrooms, where the requirement is for heights above 2m. Refer to clauses 11.3.7 and 11.3.8 of NCC 2022 for further information on suitable protective devices.

### Note: Paved Areas

All paths and patios to fall away from dwelling.

### Note: Stair Construction

All stairs to be constructed in accordance with NCC Vol II 2022 Part 11.2.2: Riser: Min 115mm - Max 190mm Going: Min 240mm - Max 355mm Slope (2R+G): Max 550 - Min 700 For stairways serving non-habitable room used infrequently, refer to table 11.2.2(b).

Landings to comply with Clause 11.2.5 and be a minimum of 750mm deep measured 500mm from the inside edge of the landing.


Slip resistance of treads, nosings and ramps to comply with Clause 11.2.4.

### Heights of rooms & other spaces 10.3.1 of NCC 2022

### Heights of rooms and other spaces must not be less

(a)in a habitable room excluding a kitchen - 2.4 m; and (b)in a kitchen - 2.1 m; and (c)in a corridor, passageway or the like - 2.1 m; and (d)in a bathroom, shower room, laundry, sanitary compartment, airlock, pantry, storeroom, garage, car parking area or the like - 2.1 m; and (e)in a room or space with a sloping ceiling or projections below the ceiling line within- See NCC directly for these items (f)in a stairway, ramp, landing, or the like - 2.0 m measured vertically above the nosing line of stairway treads or the floor surface of a ramp,

If required onsite, the builder may work within the tolerances of the above as specified within the NCC 2022 Vol II. Builder to contact Pinnacle before undertaking works.

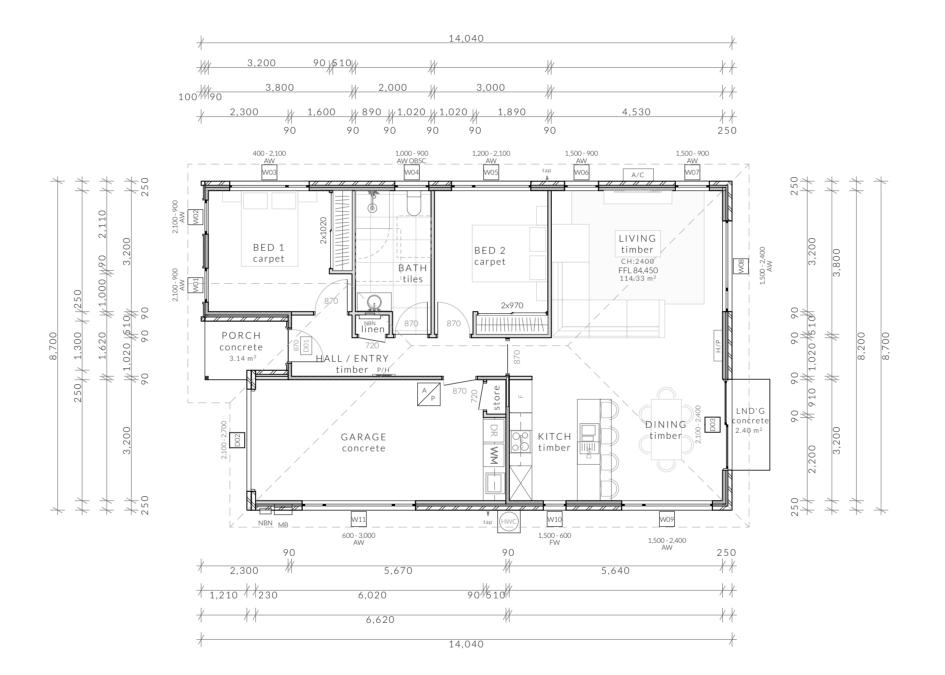

### Floor Areas

Total Floor Area 114.33m<sup>2</sup> Porch 3.14m<sup>2</sup> Concrete Landing 2.40m<sup>2</sup>

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Revision:


Approved by:

DA - 02

JN





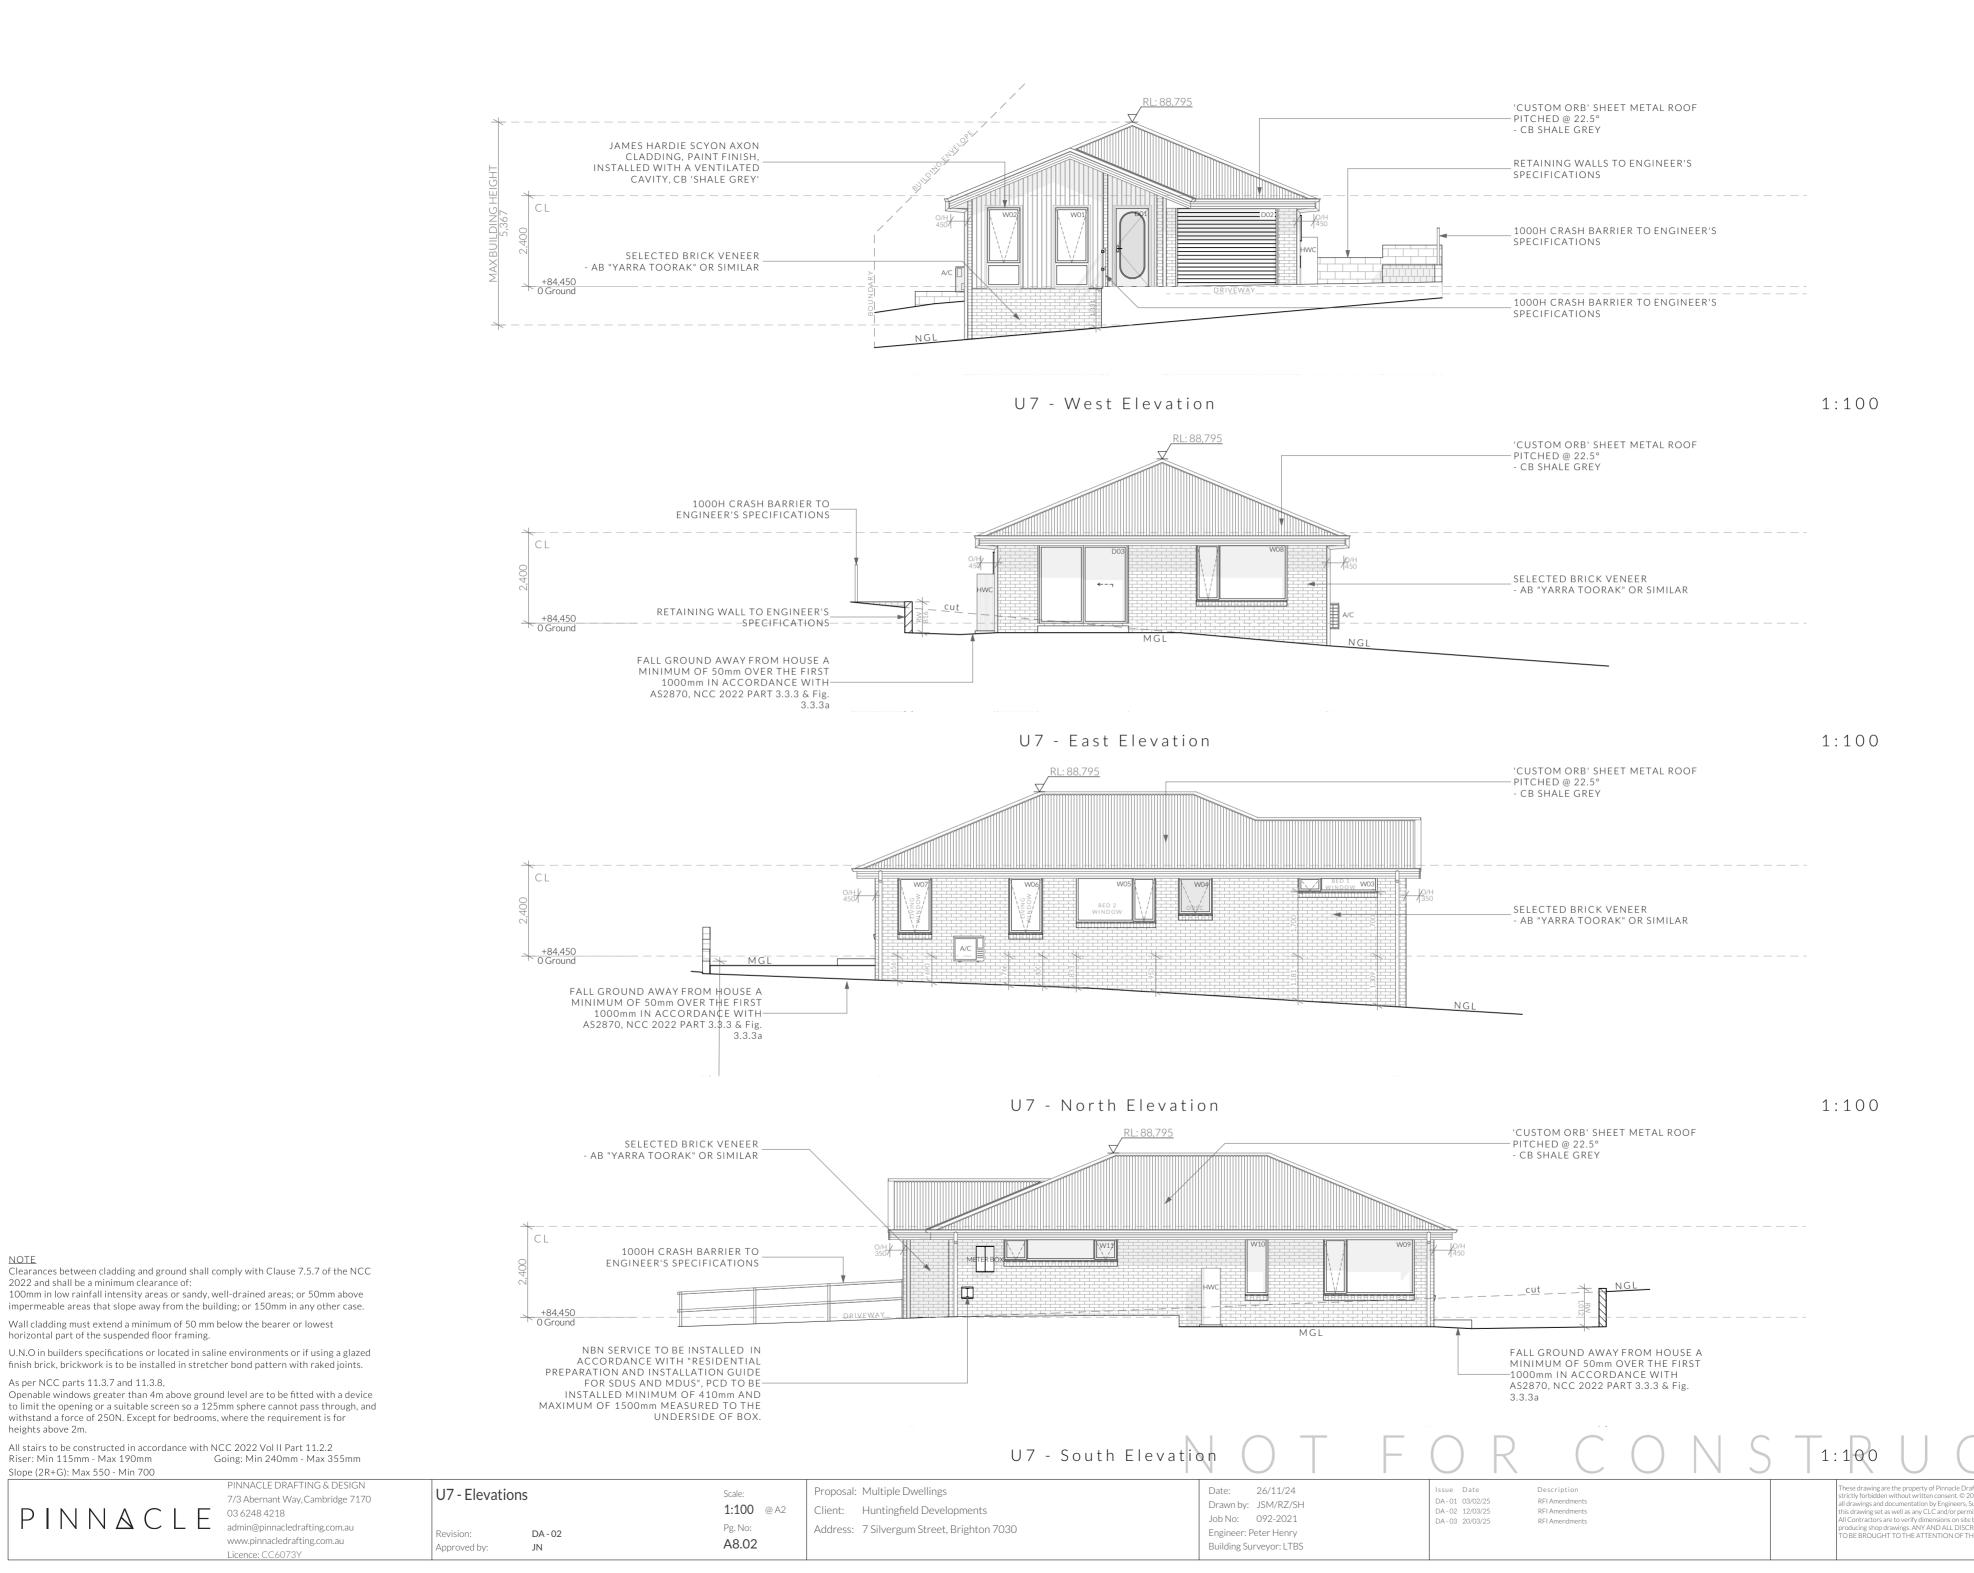

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2022 and shall be a minimum clearance of:

As per NCC parts 11.3.7 and 11.3.8,

Slope (2R+G): Max 550 - Min 700

heights above 2m.

horizontal part of the suspended floor framing.

100mm in low rainfall intensity areas or sandy, well-drained areas; or 50mm above impermeable areas that slope away from the building; or 150mm in any other case.

finish brick, brickwork is to be installed in stretcher bond pattern with raked joints.

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Going: Min 240mm - Max 355mm


03 6248 4218

Licence: CC6073Y

PINNACLE DRAFTING & DESIGN

admin@pinnacledrafting.com.au

www.pinnacledrafting.com.au

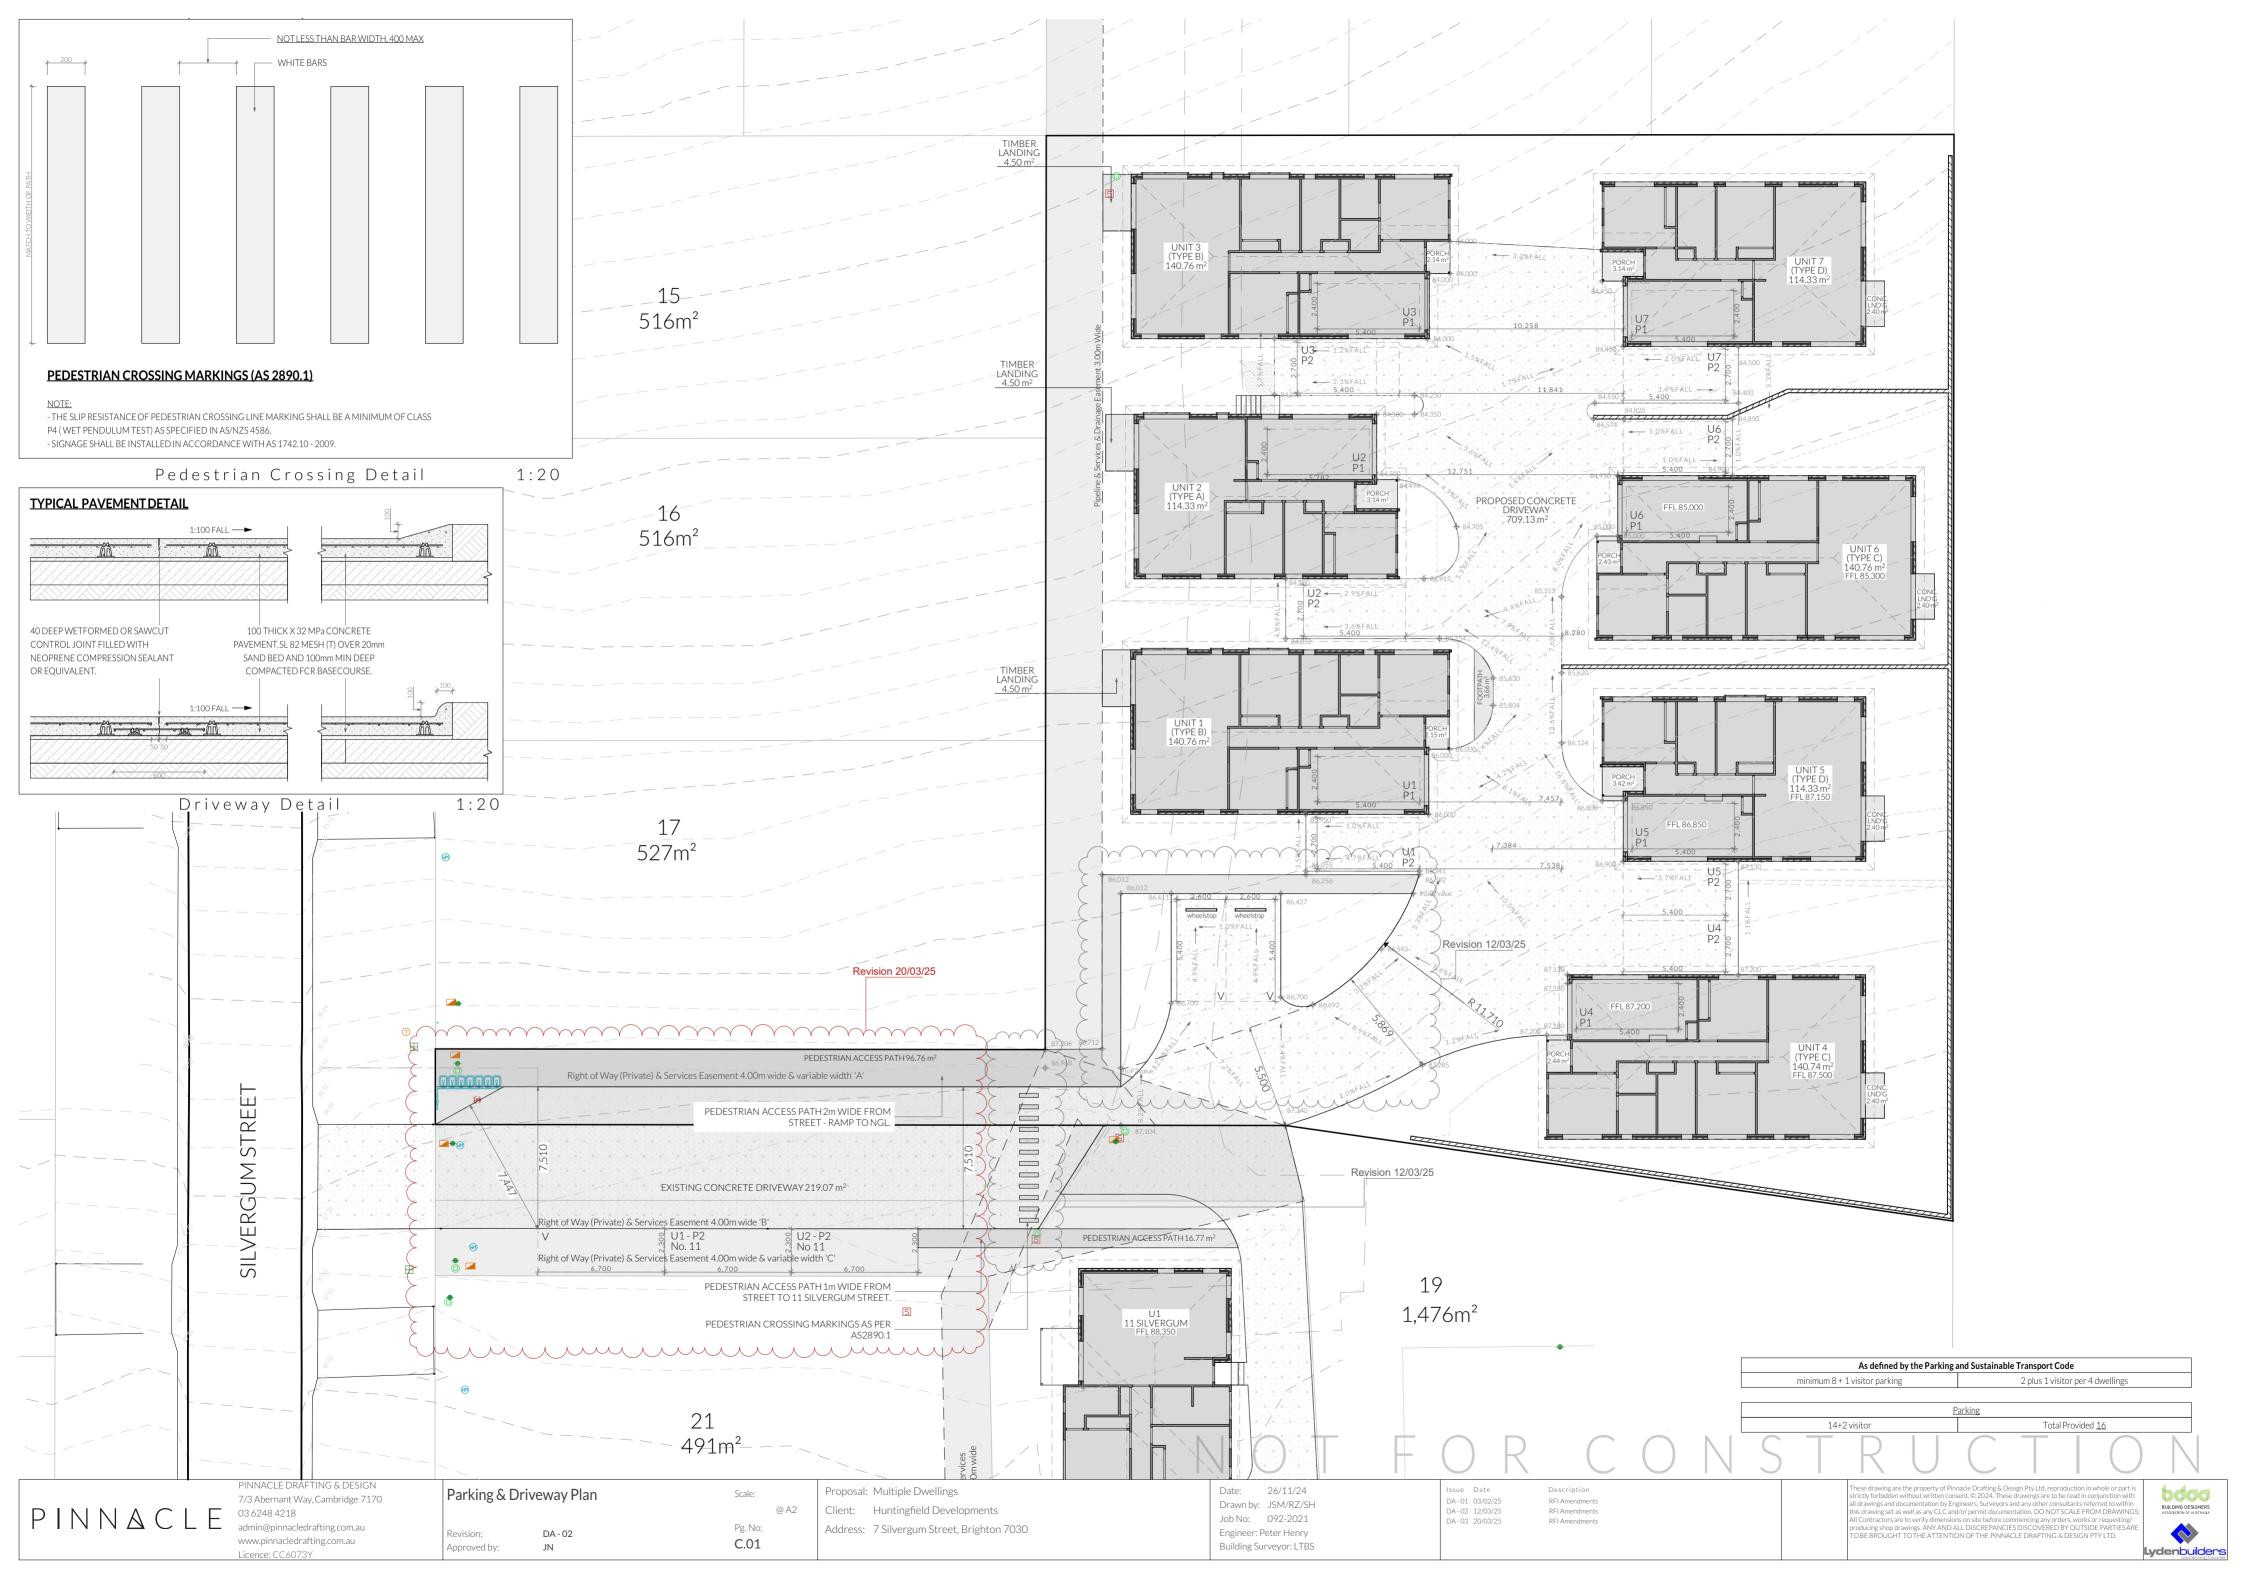



### Planting Schedule

Symbol	Name	Qty	Pot Size	Height	Spread
	Abelia sp.	24		6,000	1,000
Archy	Acer.sp	7	200mm	4,000	3,000
	Anigozanthos sp.	17		6,000	1,000
	Callistemon sp.	4		6,000	2,000
	Dianella tasmanica	24		6,000	1,000
	Eremophila sp.	24		6,000	1,200
	Grevillea sp.	4		6,000	2,500
ENS.	Hebe sp.	3		6,000	1,200
-	Lavandula sp.	11		6,000	1,500
The state of the s	Lomandra sp.	2		6,000	1,000

### BRI-S 12.7.2 A1


- 1 tree in the private open space of each dwelling which can grow to a minimim height of 3m and a minimum

spread of 2m at maturity.


 Denotes potted plant within Easement

### <u>Note</u>

Plants have been selected to be drought tolerant and low maintenance once established, it is recommended that a dripper system or similar be put into place until established. Plant locations are indicative and may be altered where suitable growing conditions cannot be met. Garden areas to be mulched with 75mm cover of selected mulch and plants are to fertilised 6 monthly or where required until established. Garden edges are to be timber, steel, or brick. Plantings that are unsuccessful will be replaced where required.

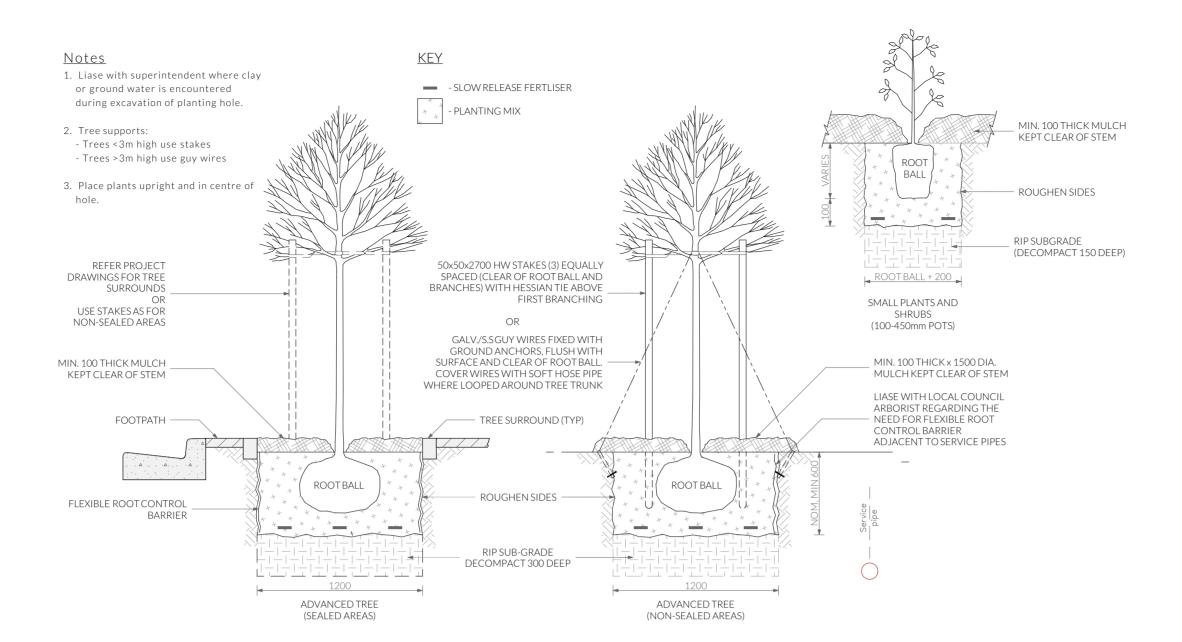

### Tree and Shrub Planting

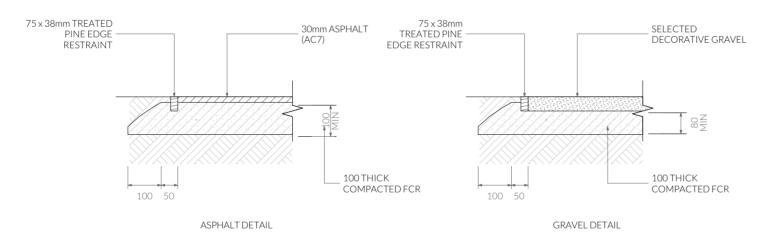



Pavement Details

1:20

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# **Amended Submission to Planning Authority**Notice

### **Application details**

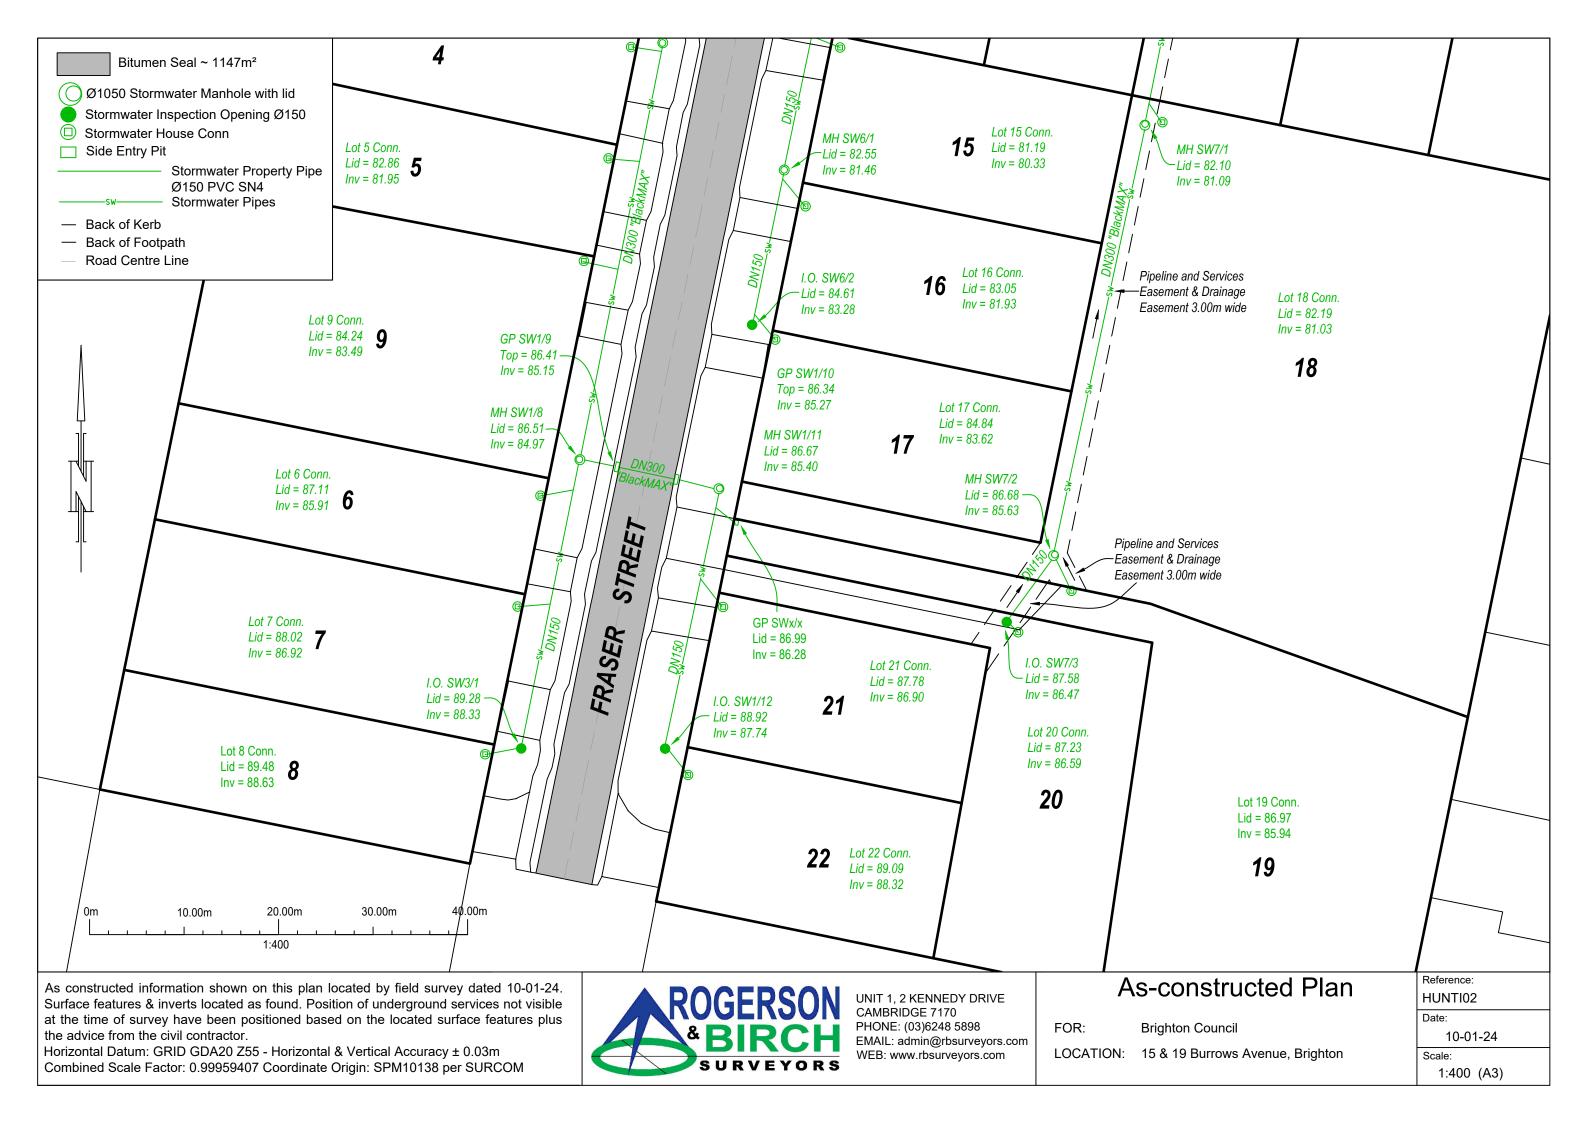Council Planning Permit No. DA 2024/234

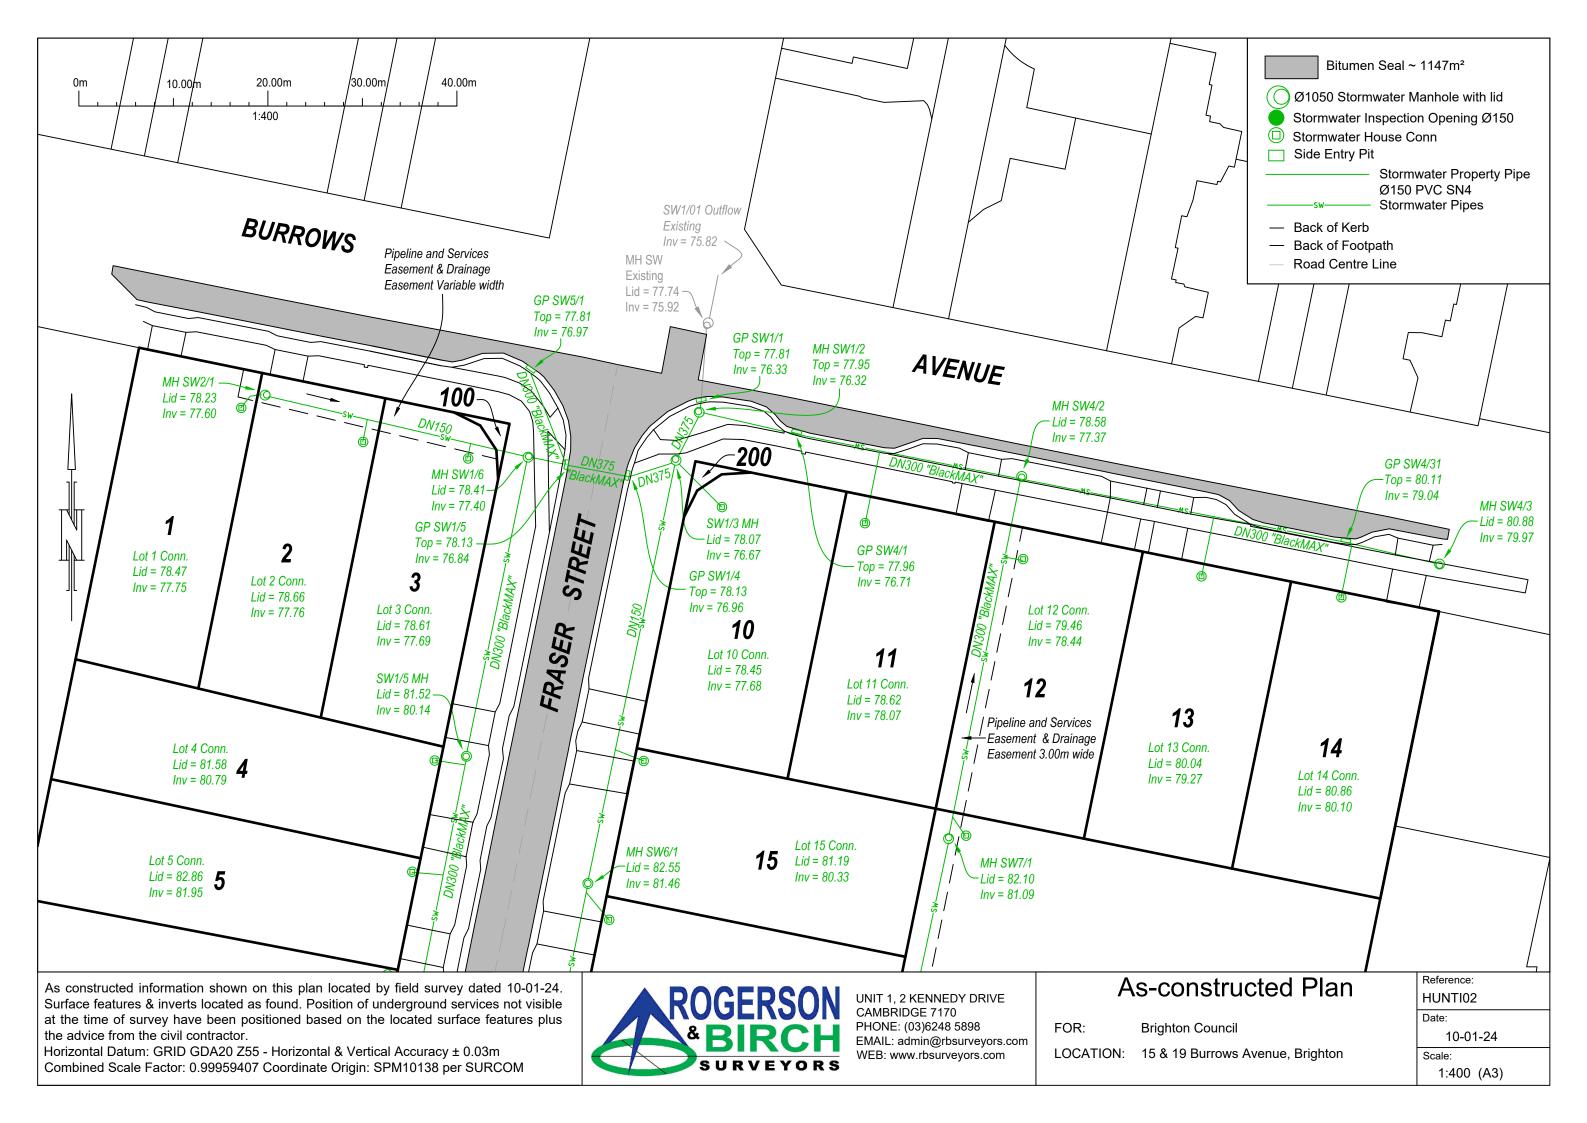Council notice date 17/12/2024

TasWater Reference No. TWDA 2024/01453-BTN

Date of response 23/12/2024

Amendment date 26/03/2025

TasWater Contact Timothy Carr

Phone No. 0419 306 130

Response issued to

Council name BRIGHTON COUNCIL

Contact details development@brighton.tas.gov.au

Development details

Address 7 SILVERGUM ST, BRIGHTON

Property ID (PID) 9255376

Description of development Multiple dwellings x 7

Schedule of drawings/documents

Prepared by	Drawing/document No.	Revision No.	Issue date
Pinnacle Drafting	Site Plan / AO.02	DA-02	20/03/2025
Pinnacle Drafting	Landscaping Plan / L.01	DA-02	20/03/2025

### **Conditions**

Pursuant to the *Water and Sewerage Industry Act* 2008 (TAS) Section 56P(1) TasWater imposes the following conditions on the permit for this application:

### **CONNECTIONS, METERING & BACKFLOW**

 A suitably sized water supply with metered connections and sewerage system and connections to the development must be designed and constructed to TasWater's satisfaction and be in accordance with any other conditions in this permit.



- 2. Any removal/supply and installation of water meters and/or the removal of redundant and/or installation of new and modified property service connections must be carried out by TasWater at the developer's cost.
- 3. Prior to commencing construction /use of the development, any water connection utilised for construction/the development must have a backflow prevention device and water meter installed, to the satisfaction of TasWater.

### TREES NEAR TASWATER PIPES

4. Trees with a canopy diameter of 2m or greater located within 2m of existing or proposed TasWater sewerage infrastructure must have the root system contained within a tub, raised garden bed or other suitable root barrier system designed to mitigate the potential for the tree roots to infiltrate the pipe trench and/or the pipe.

### **DEVELOPER CHARGES**

- 5. Prior to TasWater issuing a Certificate(s) for Certifiable Work (Building) and/or (Plumbing), the applicant or landowner as the case may be, must pay a developer charge totalling \$7,028.00 to TasWater for water infrastructure for 4.00 additional Equivalent Tenements, indexed by the Consumer Price Index All groups (Hobart) from the date of this Submission to Planning Authority Notice until the date it is paid to TasWater.
- 6. Prior to TasWater issuing a Certificate(s) for Certifiable Work (Building) and/or (Plumbing), the applicant or landowner as the case may be, must pay a developer charge totalling \$9,224.25 to TasWater for sewerage infrastructure for 5.25 additional Equivalent Tenements, indexed by the Consumer Price Index All groups (Hobart) from the date of this Submission to Planning Authority Notice until the date it is paid to TasWater.
- 7. In the event Council approves a staging plan, prior to TasWater issuing a Certificate(s) for Certifiable Work (Building) and/or (Plumbing) for each stage, the developer must pay the developer charges commensurate with the number of Equivalent Tenements in each stage, as approved by Council.

### **DEVELOPMENT ASSESSMENT FEES**

8. The applicant or landowner as the case may be, must pay a development assessment fee of \$403.51 to TasWater, as approved by the Economic Regulator and the fees will be indexed, until the date paid to TasWater.

The payment is required within 30 days of the issue of an invoice by TasWater.

### **Advice**

### General

For information on TasWater development standards, please visit <a href="https://www.taswater.com.au/building-and-development/technical-standards">https://www.taswater.com.au/building-and-development/technical-standards</a>
For application forms please visit <a href="https://www.taswater.com.au/building-and-development/development-application-form">https://www.taswater.com.au/building-and-development/development-application-form</a>

### **Developer Charges**

For information on Developer Charges please visit the following webpage – <a href="https://www.taswater.com.au/building-and-development/developer-charges">https://www.taswater.com.au/building-and-development/developer-charges</a>



### **Water Submetering**

As of July 1 2022, TasWater's Sub-Metering Policy no longer permits TasWater sub-meters to be installed for new strata developments. Please ensure plans submitted with the application for Certificate(s) for Certifiable Work (Building and/or Plumbing) reflect this. For clarity, TasWater does not object to private sub-metering arrangements. Further information is available on our website (<a href="www.taswater.com.au">www.taswater.com.au</a>) within our Sub-Metering Policy and Water Metering Guidelines.

### **Trees near TasWater Pipes**

Section 56X(1) of the Water and Sewerage Industry Act 2008 (No. 13 of 2008) states that a regulated entity (TasWater) may, by notice in writing, require the owner of any land to remove any tree on that land if the regulated entity reasonably decides that the tree is obstructing or damaging the regulated entity's works or that it is likely to obstruct or damage them. The developer should carefully consider the type of trees planted within the proximity of TasWater infrastructure to avoid the possibility of removal by TasWater at the owners cost at some time in the future.

### **Service Locations**

Please note that the developer is responsible for arranging to locate the existing TasWater infrastructure and clearly showing it on the drawings. Existing TasWater infrastructure may be located by a surveyor and/or a private contractor engaged at the developers cost to locate the infrastructure.

- (a) A permit is required to work within TasWater's easements or in the vicinity of its infrastructure. Further information can be obtained from TasWater.
- (b) TasWater has listed a number of service providers who can provide asset detection and location services should you require it. Visit <a href="https://www.taswater.com.au/building-and-development/service-locations">https://www.taswater.com.au/building-and-development/service-locations</a> for a list of companies.

### **Declaration**

The drawings/documents and conditions stated above constitute TasWater's Submission to Planning Authority Notice.