



Application for Planning Approval

Land Use Planning and Approvals Act 1993

APPLICATION NO.

DA2023/093

LOCATION OF AFFECTED AREA

397 BOYER ROAD, DROMEDARY

DESCRIPTION OF DEVELOPMENT PROPOSAL

SECOND RESIDENCE

A COPY OF THE DEVELOPMENT APPLICATION MAY BE VIEWED AT www.brighton.tas.gov.au AND AT THE COUNCIL OFFICES, 1 TIVOLI ROAD, OLD BEACH, BETWEEN 8:15 A.M. AND 4:45 P.M., MONDAY TO FRIDAY OR VIA THE QR CODE BELOW. ANY PERSON MAY MAKE WRITTEN REPRESENTATIONS CONCERNING AN APPLICATION UNTIL 4:45 P.M. ON **04/07/2023**. ADDRESSED TO THE GENERAL MANAGER AT 1 TIVOLI ROAD, OLD BEACH, 7017 OR BY EMAIL AT development@brighton.tas.gov.au. REPRESENTATIONS SHOULD INCLUDE A DAYTIME TELEPHONE NUMBER TO ALLOW COUNCIL OFFICERS TO DISCUSS, IF NECESSARY, ANY MATTERS RAISED.

**DAVID ALLINGHAM
ACTING General Manager**



Brighton
going places

**Planning Application for Proposed Ancillary Dwelling
at
397 Boyer Road, Dromedary
for
E&G Batstone**

Drawing List (11 sheets)

Sheet A1	-	Proposed Site plan
Sheet A2	-	Driveway & Parking Plan
Sheet A3	-	Concept Services Plan
Sheet A4	-	Proposed Floor Plan 1:100
Sheet A4a	-	Proposed floor plan 1:75
Sheet A5	-	Elevations
Sheets M1-M5	-	SWMP plans

NOTES TO PLANS

To be read in conjunction with plans and specifications

- 1- Figured dimensions to be used. Do not scale drawings.
- 2- It is considered mandatory that a registered surveyor be engaged to confirm all dimensions. It is incumbent upon the builder to instigate this process. Discrepancies are to be notified to this office immediately.
- 3- All materials and work, including installation methods to be in accordance with the relevant AS code, BCA and Manufacturers recommendations. (Refer (4) below)
- 4- It is incumbent and expected that the builder and/or tradesman will be familiar with, and apply exactly, all of the relevant Manufacturers directions and instructions (including those contained within the BCA) for the various materials and systems used in this project. This office can provide this information on request.
- 5- Although every care is taken, R & M Jackson accepts no responsibility for interpretation, error or omission. It is expected that all building work will be carried out in a professional manner in accordance with the relevant AS codes however where ambiguity or doubt exists on the plans the builder MUST notify this office immediately. It is also expected that the builder will be familiar with and understand all aspects of the construction before commencement.
- 6- These drawings to be read in conjunction with engineers reports and other associated reports and details.
- 7- All plumbing and drainage to AS 3500 and Local Authority requirements
- 8- All electrical work to be in accordance with the relevant AS codes.
- 9- Aerial imagery courtesy of Google Maps Aust. where supplied.
- 10- Any changes to the drawings (as constructed) after submission to the building surveyor are at the cost of the owner and/or the builder and to be paid for prior to lodgement.

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R & M Jackson
Drafting Services
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Phone: 03 62 391019
Email: jacksondrafting@gmail.com

Accredited Building Practitioner
Licence No: CC340Y

**PROJECT No.
23P0403**

Contractor to verify the location of all current underground services shown on the plans including but not limited to electricity, telecom, gas, sewer, stormwater, NBN etc. prior to excavation. (DBYD www.1100.com.au)


ALL DIMENSIONS & LEVELS TO BE CONFIRMED BY BUILDER ON SITE PRIOR TO COMMENCEMENT.
DISCREPANCIES TO BE REFERRED TO THIS OFFICE IMMEDIATELY

**Brighton Council
Interim Planning Scheme 2015
Zone :Rural Living**

Overlays :
 * Bushfire Prone Area
 * Waterway & Coastal Protection Area
 * Priority Vegetation Area
 * Low Coastal Inundation Hazard Band
 * Future Coastal Refugia Area

OH&S HAZARD
 Type: public safety
 Solution: provision of safety fencing around construction area


DISCRETIONS REQUESTED :
 Rural Living Zone - 13.4.2 -20m setback required all boundaries.
 Permission is sought to vary this as shown and offer the following in support.
 * new building is a single storey residence in a cutting in the landscape
 * existing residence is currently 16m from boundary
 * existing absorption area from the AWTS exists at this location. Siting of new building is to ensure minimum disturbance to this area
 * the site is in a rural area with no close neighbours other than the dwelling to the east.
 * the visual impact from Boyer Road will be negligible due to the FFL of the building being below road level.

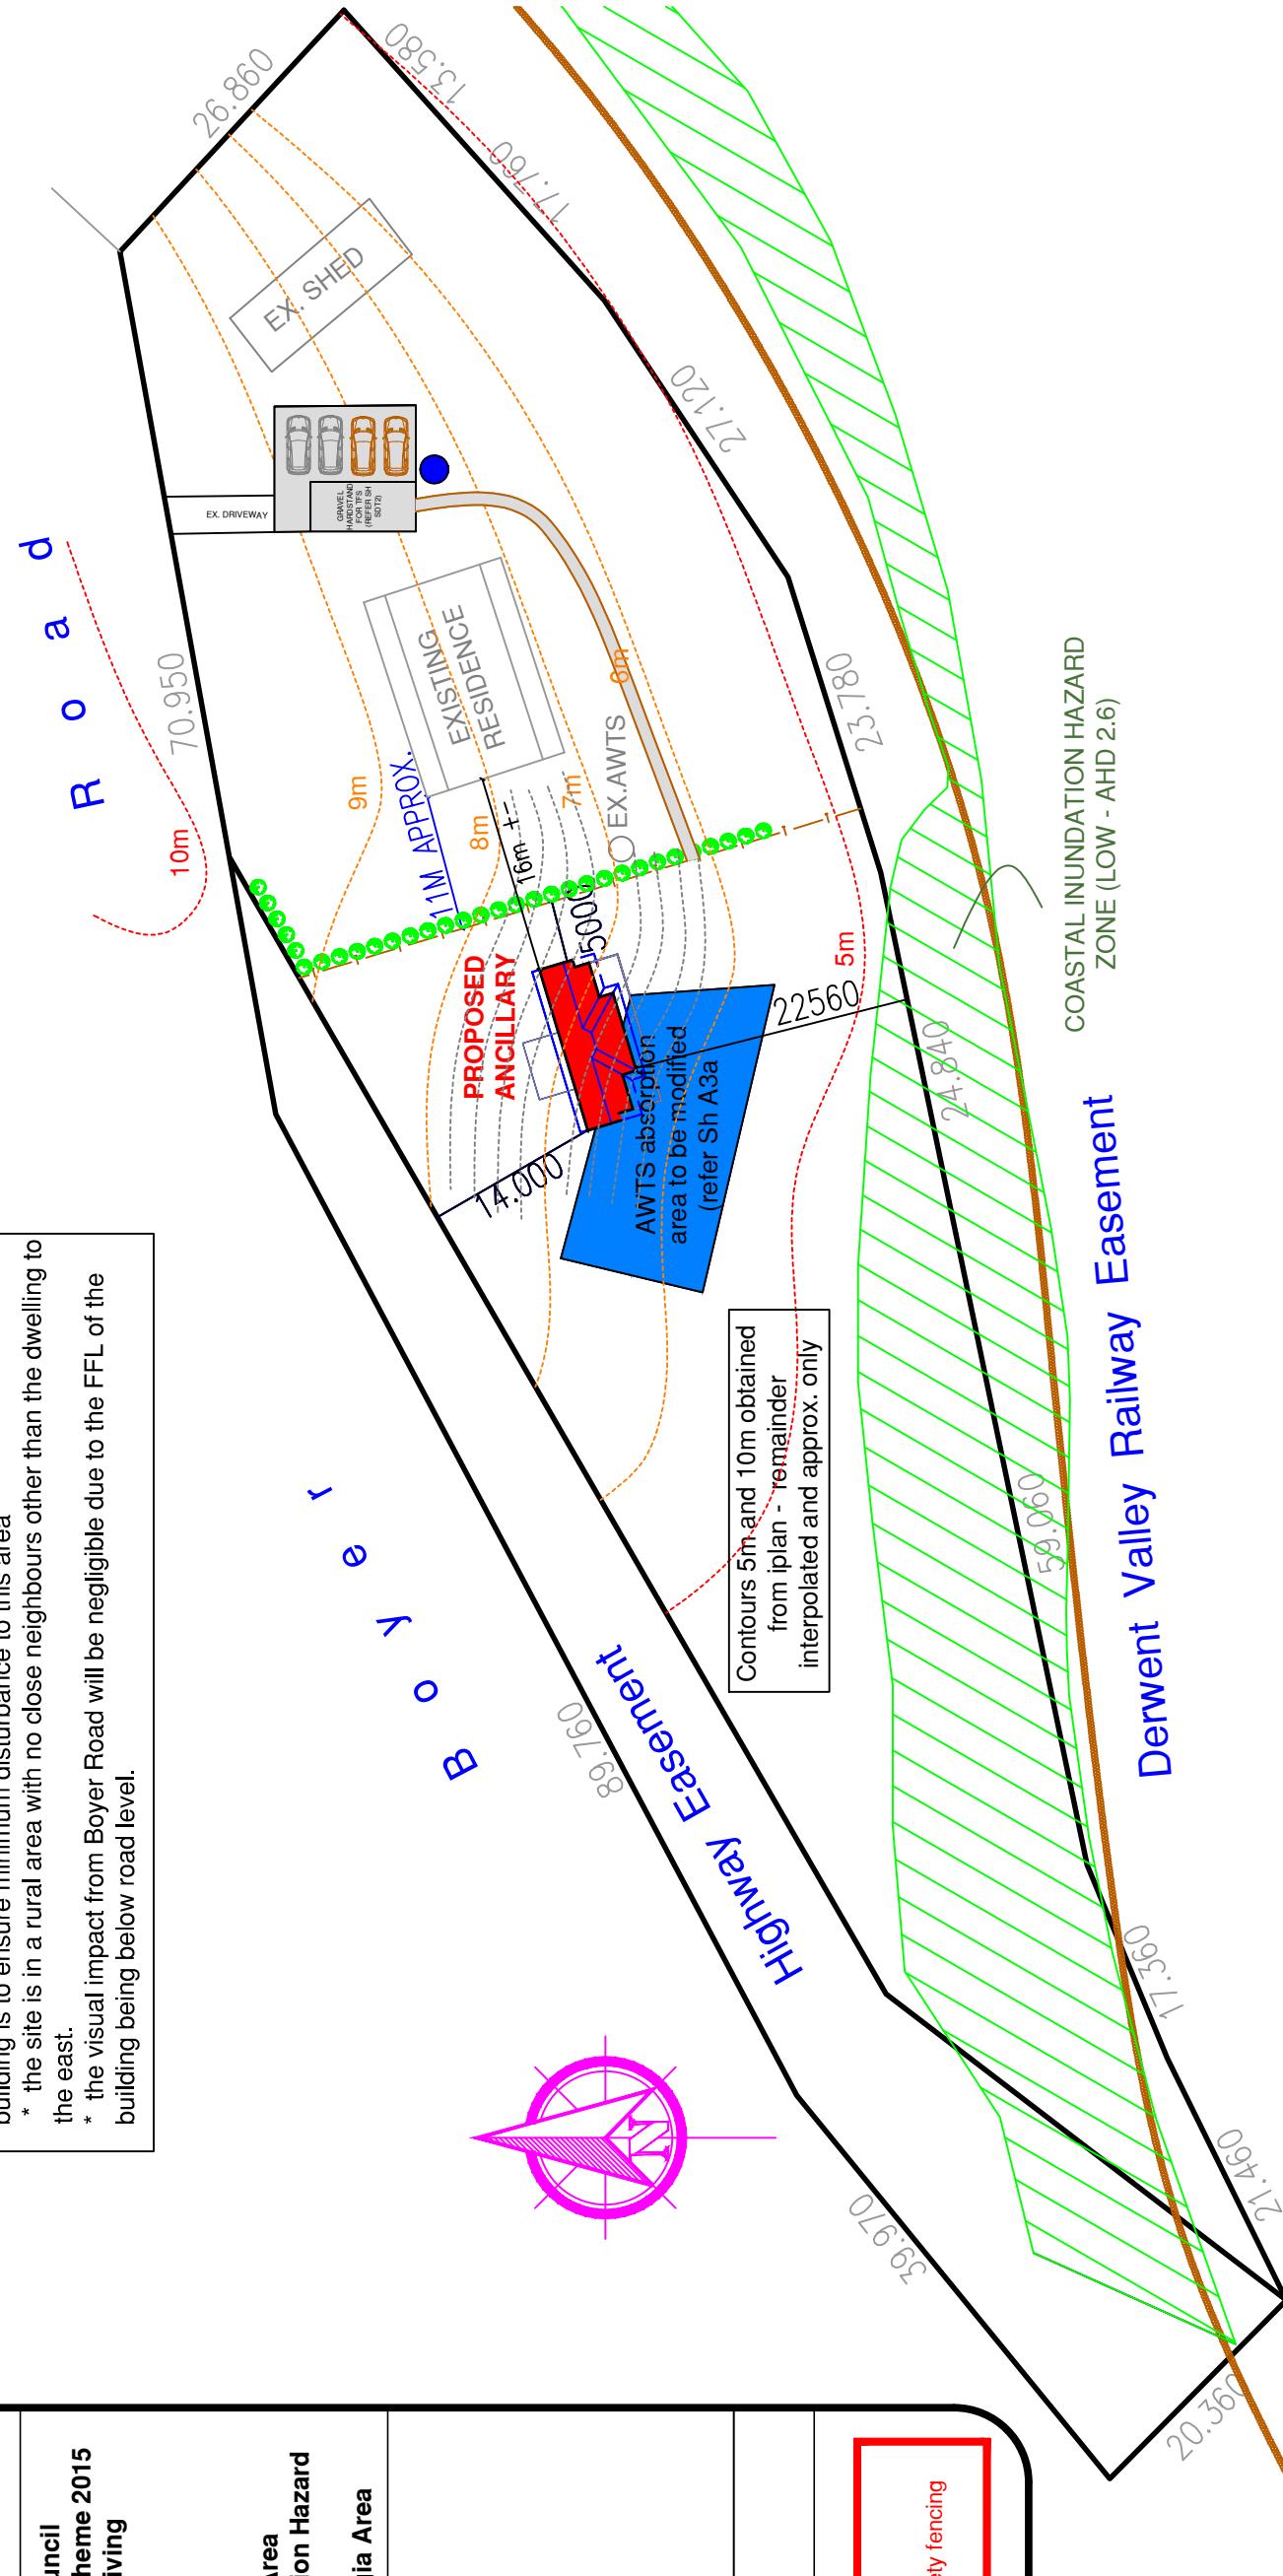

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R o a d
B o y e r



EXISTING RESIDENCE

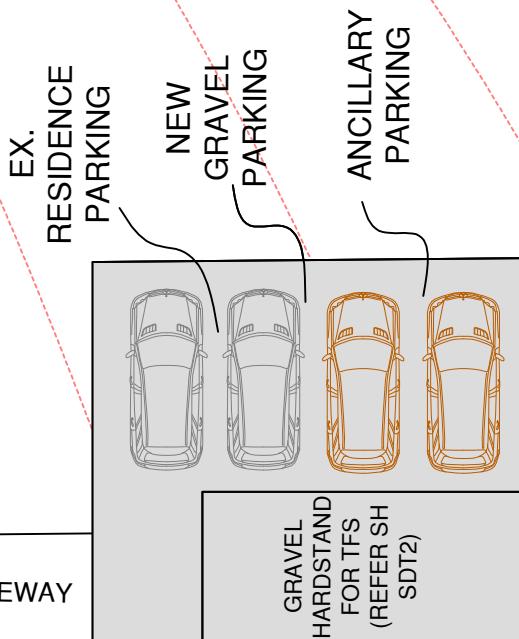NEW PATHWAY TO ANCILLARY



EXISTING AWTS

PROPOSED ANCILLARY DWELLING


Date	Rev.	Description
		Title: Lot 1 - D 21805 - 6599m ²
		Wind speed to AS4055 : N
		Soil Class to AS 2870 : -
		Energy: refer report
		BAL:

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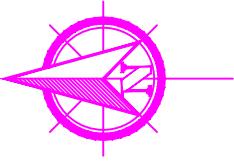
Driveway plan

Hanna Batstone
Client : 397 Boyer Rd., Dromedary, Tasmania 7030
Issue : **DRAFT**
Drawn by : DC / RJ
(not to be used for construction)
Sheet size A3
Project No 23P0403
Date : April 2023

A2
Scale 1:200

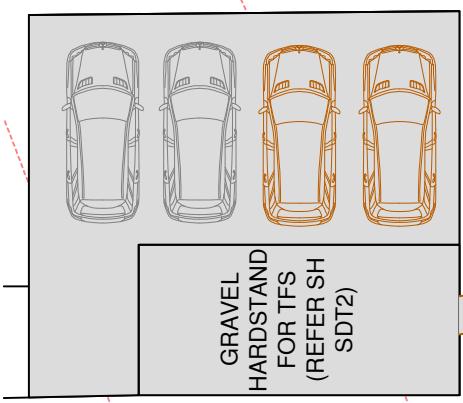

10,000L FIRE TANK



EXISTING RESIDENCE

60m

EXISTING AWTS

DN100

ex. 1000

new DN100

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DN100

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CONFIRMED BY BUILDER ON SITE
PRIOR TO COMMENCEMENT.
DISCREPANCIES TO BE REFERRED
TO THIS OFFICE IMMEDIATELY

NOTES:-

1. Kitchen to be provided with rangehood vented externally.
 2. All MLV's to be vented externally (can interconnect in roof space) and to be provided with time delay switches.
 3. All cupboards adjacent to external walls to be provided with air vents
 4. ARTIFICIAL LIGHTING -
 - max. 5 watts/m² for living areas
 - max. 4 watts/m² for balconies, verandas and porches
 - max. 3 watts/m² for Class 10a buildings (assoc. with Class 1a)
 5. All windows are to be positioned centrally within walls UNO
 6. Provide 12mm ply blocking between studs at positions of handrails etc in WC's and bathrooms etc.
 7. All internal doors, UNO to be 2040x820
 - 3. WC door to either inward swing with removable hinges, outward swing, slide, or inward swing with 200mm min. between doorway and pan

Door & window Tag Legend

W Single Glazed Safety Glass Window (1000h x 900w)
(sizes examples only - refer to floor plan for actual)

10/09	Single Glazed Window (1000h x 1800w)
10/09	Double Glazed Window (1000h x 1800w)
10/18	Single Glazed Sliding Doors (2100h x 1800w)
10/18	Double Glazed Sliding Doors (2100h x 1800w)
	Double Hung Window (1800h x 600w)
	DG Safety Glass Window (1000h x 900w)

SGSW Single Glazed Sliding Window
15/15

SGFD Single Glazed French Doors
21/16

d/h denotes double hung / **slid.** denotes sliding / **aw.** denotes awning

NOTE: * bathroom and wc glazing to be obscure unless directed otherwise by owners
* **Where windows are > 2m (bedrooms) and > 4m (all others)**
above external surface refer table above

MLV Denotes mech. light & ventilation to AS1668.2

Denotes wired-in smoke detector to AS 3786

 HWS Denotes Hot Water System

 WH Denotes Wood Heater with Flue

 DP Denotes 75mm PVC Downpipe

 HC Denotes Hose Cock

NOTE: All to be interconnected to operate simultaneously

NOTE: ALL WINDOWS TO BE ALUM EBAMED

REFER ENERGY ASSESSMENT RE: U and SHGC values
NOTE: ALL WINDOWS TO BE ALUMI. FINISHED

FLOOR AREAS	-	60 m²
living	-	
TOTAL	-	60 m²
		(overall)



EXTERNAL FLOOR AREA - 60m²

The floor plan illustrates the layout of the house and its external spaces. Internal rooms include a Living room (4950), two Bed rooms (2800 each), a Bath (900), a Kitchen, and a central Bath (900). External areas consist of a Northern terrace (4730) and a Southern terrace (4500). The plan shows various doors (sliding and French), windows, and built-in wardrobes (e.g., SGD 09/18, SGD 21/27, DHW 12/75). Eaves heights are indicated as 600 mm. A compass rose is located in the bottom left corner.

Proposed Floor Plan

R & M Jackson
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Accredited Building Practitioner Licence No: CCC

A4	Scale 1:100	Date : April 2023	Drawn by : DC / RJ	Client : 397 Boyer Rd, Dromedary, Tasmania 7030	Hanna Balstone
			Issue : DRAFT <small>(not to be used for construction)</small>		
			Sheet size	Project No	A3
					23P0403

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NOTES:-

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- All cupboards adjacent to external walls to be provided with air vents
- ARTIFICIAL LIGHTING - max. 5 watts/m² for living areas max. 3 watts/m² for Class 10a buildings (assoc. with Class 1a)
- All windows are to be positioned centrally within walls UNO
- Provide 12mm ply blocking between studs at positions of handrails etc in WC's and bathrooms etc.
- All internal doors, UNO to be 2040x920
- WC door to either inward swing with removable hinges, outward swing, slide, or inward swing with 1200mm min. between doorway and pan

Door & window Tag Legend

(sizes examples only - refer to floor plan for actual)
SGW 10/09 Single Glazed Safety Glass Window (1000h x 900w)
SGW 10/09 Single Glazed Window (1000h x 1800w)
DGW 10/18 Double Glazed Window (1000h x 1800w)
SGSD 21/18 Single Glazed Sliding Doors (2100h x 1800w)
DGSD 21/18 Double Glazed Sliding Doors (2100h x 1800w)
DHW 10/09 Double Hung Window (1800h x 800w)
DGSA 10/09 Double Glazed Safety Glass Window (1000h x 900w)
SGSW 15/15 Single Glazed Sliding Window
SGFD 21/16 Single Glazed French Doors

dh denotes double hung / solid denotes sliding / aw. denotes awning
* Where windows are > 2m (bedrooms) and > 4m (all others) above external surface refer table above
MLV Denotes mech. light & ventilation to AS 1668.2
SD Denotes wired-in smoke detector to AS 3786
HWS Denotes Hot Water System
WH Denotes Wood Heater with Flue
DP Denotes 75mm PVC Downpipe
HC Denotes Hose Cock

NOTE: ALL WINDOWS TO BE ALUM. FRAMED
REFER ENERGY ASSESSMENT RE: U and SHGC values



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Proposed Floor Plan

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A4a
Scale 1:75

Hanna Batstone
Client : 397 Boyer Rd., Dromedary, Tasmania 7030
Issue : **DRAFT**
Drawn by : DC / RJ
(not to be used for construction)
Sheet size A3
Project No 23P0403



Date	Rev.

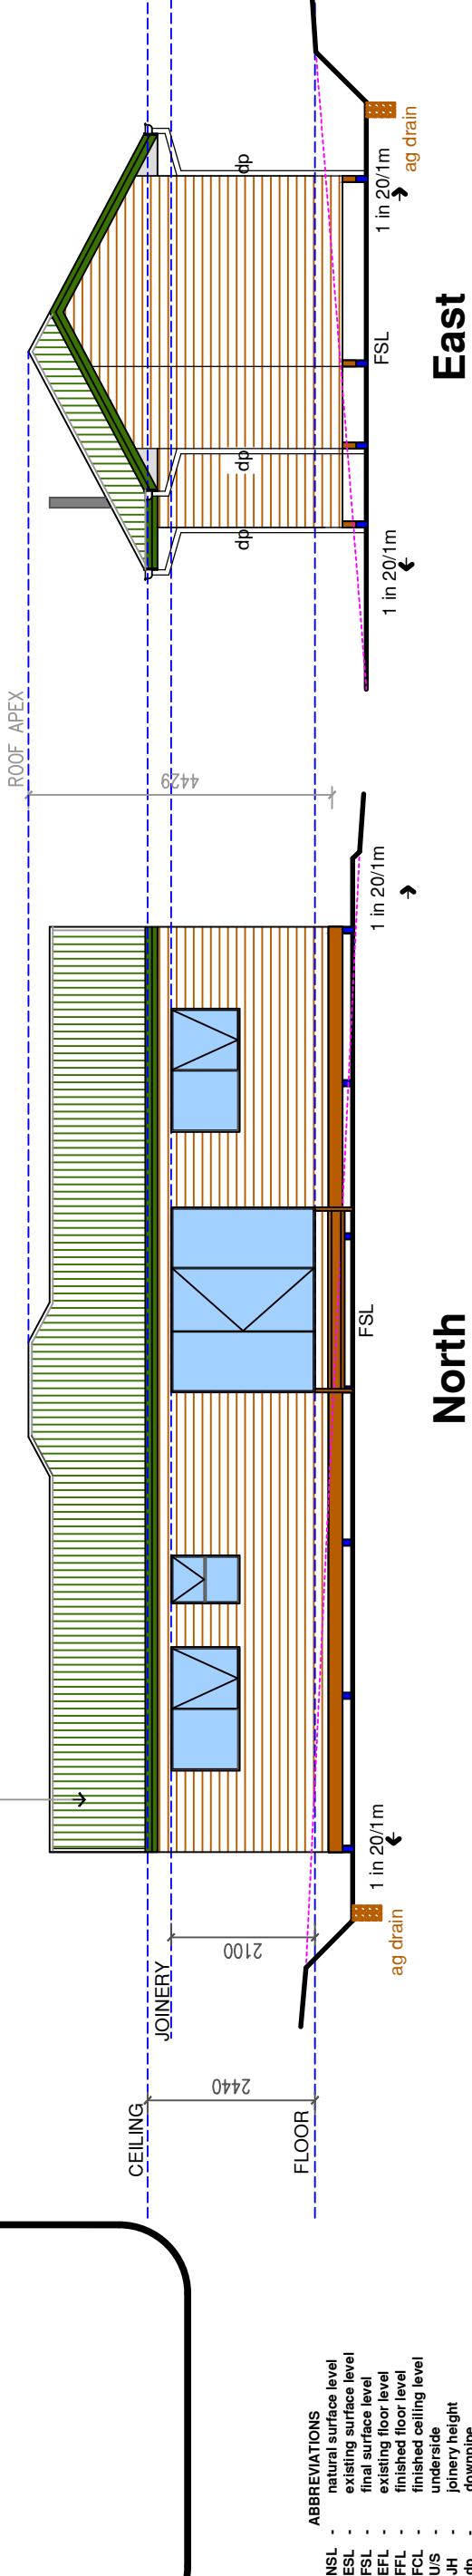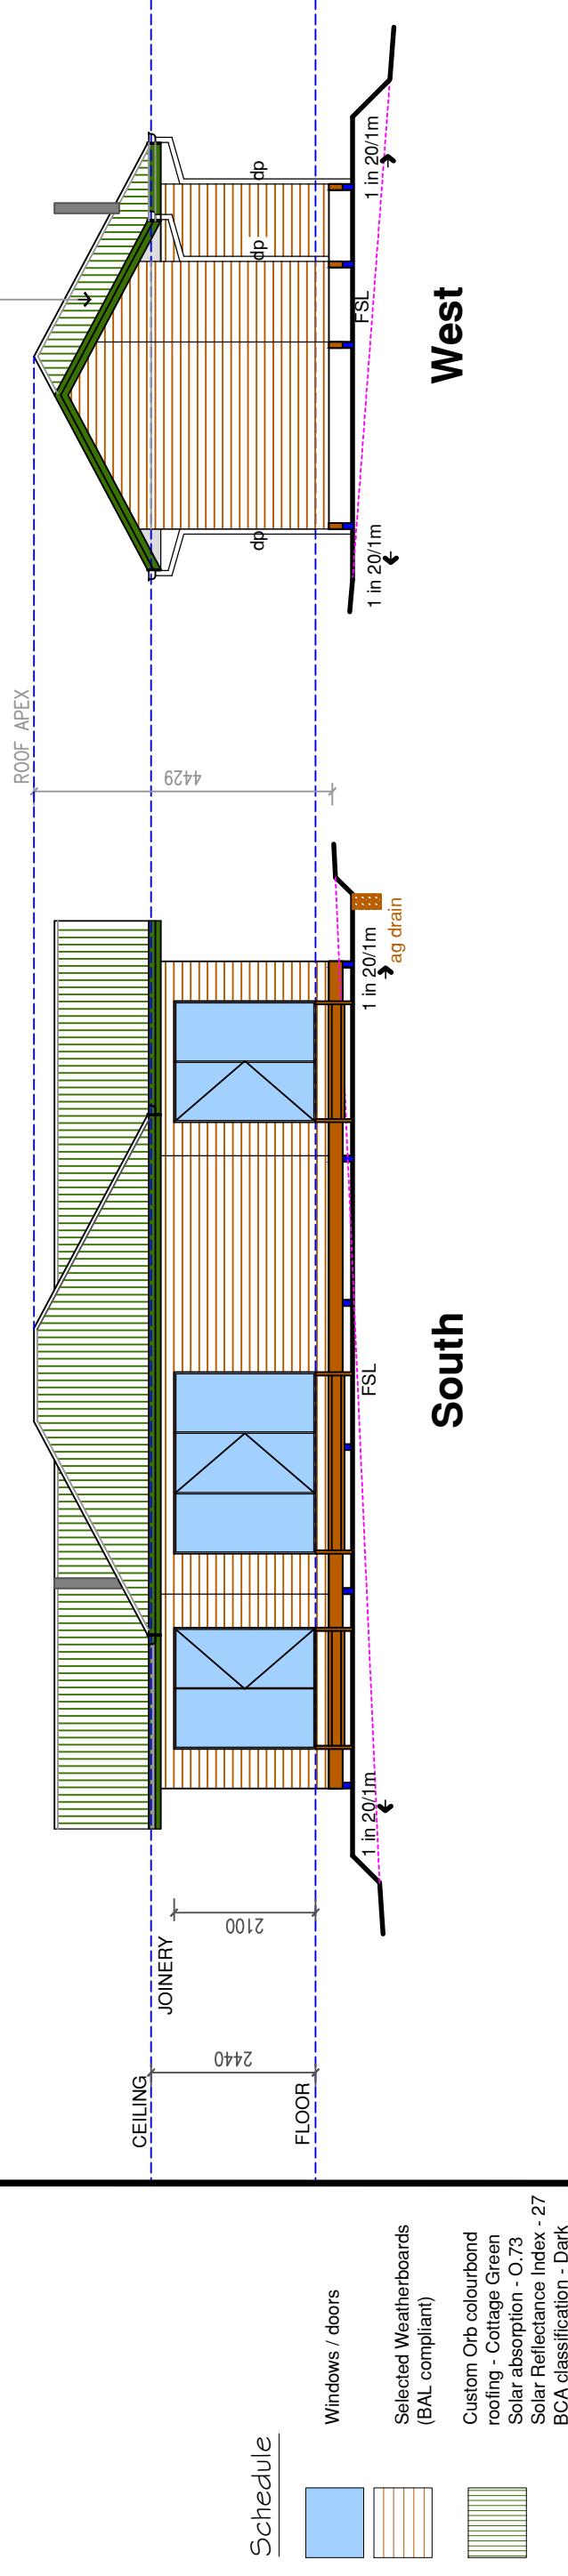Title: Lot 1 - D 21805 - 6599m²
Wind speed to AS4055 : **N**
Soil Class to AS 2870 : **-**
Energy: **refer report**
BAL:

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Accredited Building Practitioner Licence No: CC340Y

Client : 397 Boyer Rd., Dromedary, Tasmania 7030		Hanna Batstone	
		Issue : DRAFT	
Drawn by : DC / RJ		(not to be used for construction)	
Date :	April 2023	Sheet size	Project No
		A3	23P0403

SOLID WASTE MATERIAL TO BE STORED AND REMOVED FROM SITE REGULARLY.

REMOVABLE WC TO BE INSTALLED ON SITE DURING CONSTRUCTION UPTO THE POINT WHERE MAIN SEWER LINE IS CONNECTED.

STOCK PILES TO BE STABILISED AS SHOWN ON DETAIL SD9.

VEHICLES/MACHINERY
ACCEESSING THE SITE TO USE HARDENED ACCESS POINT AND TO BE THOROUGHLY WASHED (HIGH PRESSURE) TO REMOVE SOIL AND PLANT MATERIAL BEFORE LEAVING SITE.


REMOVE ANY SOIL, CONCRETE, PAINT OR OTHER POTENTIAL POLLUTANTS FROM ANY AREA NOT WITHIN THE SITE BOUNDARY, TO MINIMISE POLLUTION THROUGH RUN OFF IN THE RETICULATED STORMWATER SYSTEM.

RETICULATED WATER MAINS AND ELECTRICAL CONNECTION TRENCHED TOGETHER. NOTES AS PER SEWER AND STORMWATER TRENCHING ABOVE.

WATER DIVERSION BARRIER (DIVERSION OF UPSLOPE WATER) CONSTRUCTED FROM SAND OR GRAVEL FILLED BAGS IN ACCORDANCE WITH DRAWING SD1.

SILT TRAP/STORM WATER PIT PROVIDE FILTRATION BARRIER AS PER DETAIL SD10.

IT IS THE BUILDERS RESPONSIBILITY TO VERIFY THE LOCATION OF ALL UNDERGROUND SERVICES, INCLUDING BUT NOT LIMITED TO; GAS, WATER, SEWER, STORM WATER, ELECTRICITY, TELECOMMUNICATIONS.

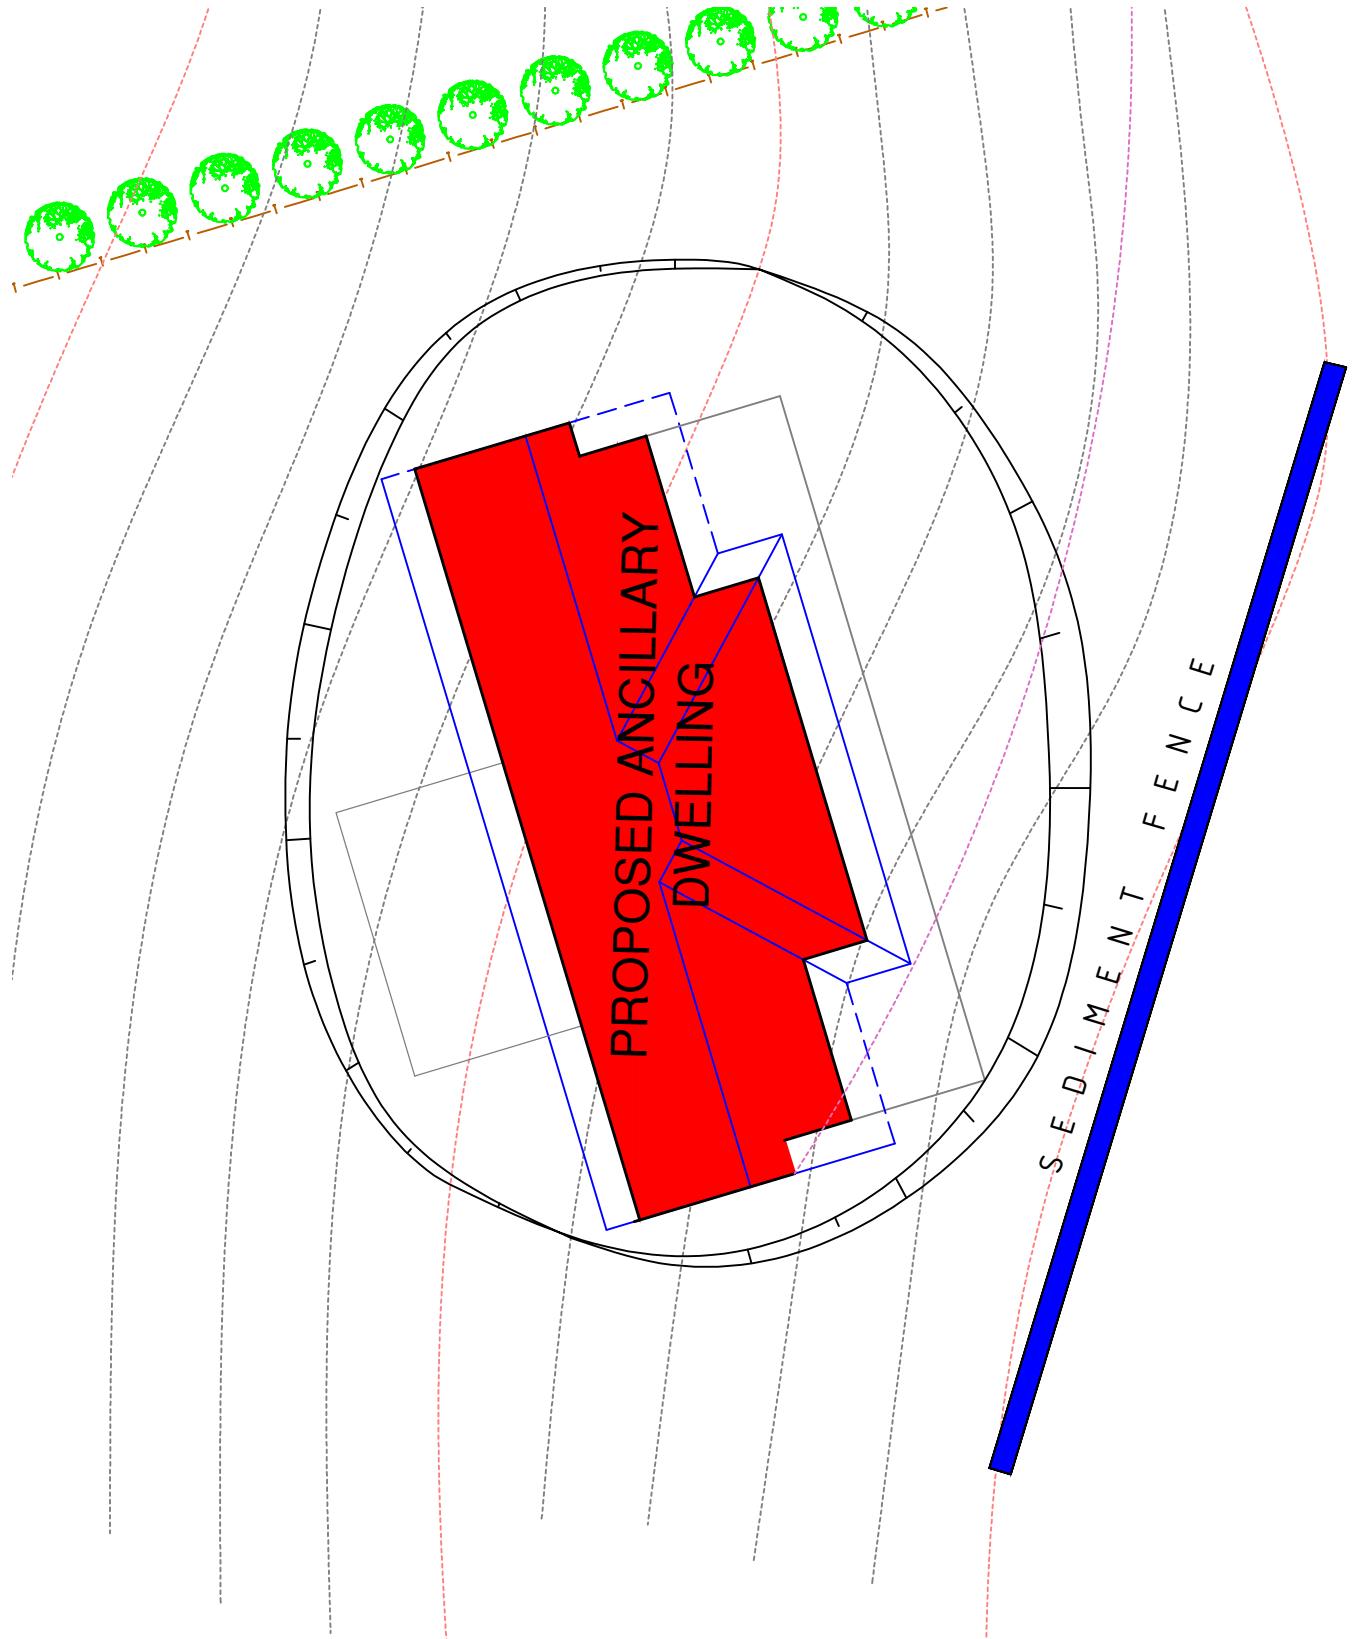


REVEGETATION & LONG TERM EROSION
CONTROLS:
ONLY REMOVE VEGETATION AS REQUIRED DURING CONSTRUCTION. TREAT HEAVILY CLAYED SOILS WITH GYPSUM OR LIME AT A RATE OF 10t/ha TO STABILISE CLAY PARTICLES. TEMPORARY STABILISATION CAN BE GAINED BY SOWING RYECORN/OATS AT 40kg/ha AND RYEGRASS var. CONCORDE AT 10kg/ha OR SIMILAR FAST ROOTING GRASSES/CROPS (WITH ADVICE FROM AGRONOMIST) TO HOLD TOGETHER TOP SOIL. PERMANENT GROUND STABILISATION CAN BE ACHIEVED USING TURF OR OTHER GRASS MIXES OF FINE LEAF RYES, FESCUSES, POA, CLOVERS, ETC. GARDEN AREAS TO BE MULCHED WITH WATER EFFICIENT PLANTINGS THAT HAVE QUICK ESTABLISHMENT TIMES TO BE USED IN INITIAL GARDEN BEDS.

WHERE TUNNEL EROSION IS EVIDENT THE TUNNELED AREA MUST BE COMPLETELY BROKEN UP AND RECONSOLIDATED TO INTERRUPT CHANNELLED FLOWS OF WATER AND THEN STABILISED WITH VEGETATION. DEEP RIP ACROSS THE SLOPE MAKING SURE THAT THESE RIP LINES ARE DEEPER THAN THE BOTTOM OF THE TUNNELS. COMPACT USING RUBBER WHEELED TRACTOR ON AREAS OF SHALLOW TUNNELING. TUNNELS DEEPER THAN THE RIPPERS ARE BEST EXCAVATED AND REPACKED.

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		Energy: refer report
		BAL:

M1	R & M Jackson	Drafting Services
Scale: NTS	P. 03 62391019 E. jacksondrating@gmail.com	Accredited Building Practitioner Licence No: CC340Y
SWMP 1		

Hanna Batstone	Client : 397 Boyer Rd., Dromedary, Tasmania 7030
	Issue : DRAFT
	(not to be used for construction)
Sheet size	Project No
A3	23P0403

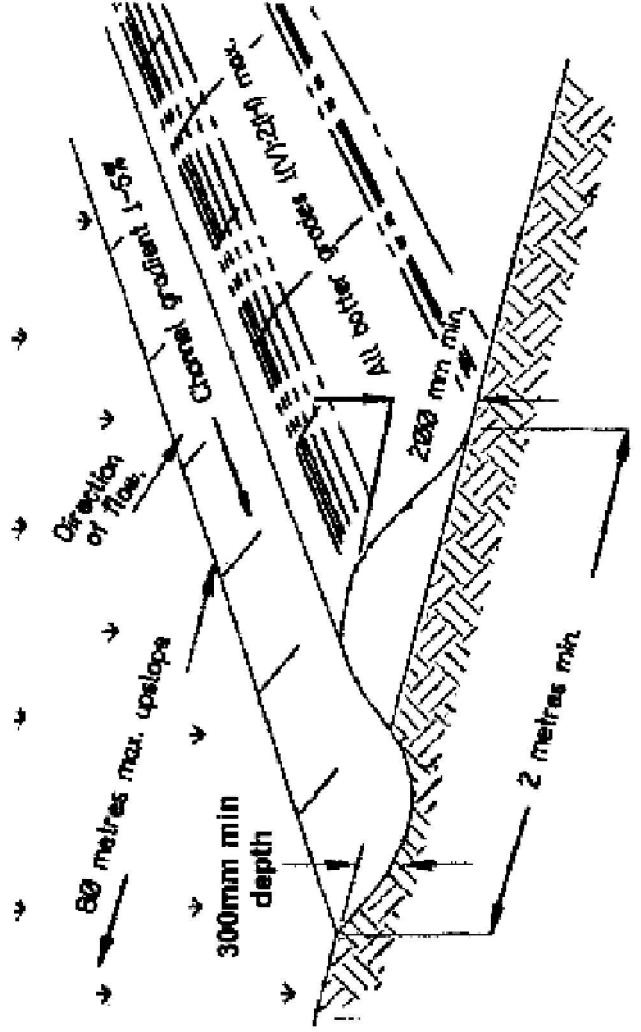

Construction Notes

1. Construct along gradient as specified.
2. Maximum spacing between banks shall be 80 metres.
3. Channels to be of parabolic or trapezoidal cross section not V-shaped.
4. Earth banks to be adequately compacted in order to prevent failure.
5. Construction is of a temporary nature and shall be completed at the end of day's work or immediately prior to rain.
6. All cutouts from disturbed banks are to feed into a sediment basin or similar.
7. Discharge runoff collected from undisturbed lands onto either a stabilised or an undisturbed disposal site within the same subcatchment area from which the water originated.
8. Compact with a suitable implement in situations where they are required to function for more than five days.
9. Earth banks to be free of projections or other irregularities that will impede normal flow.

SD 1 - Diversion of Upslope Water - CatchDrains

DETAILS EXTRACTED FROM "GUIDELINES FOR SOIL AND WATER MANAGEMENT" BY THE DEPARTMENT OF PRIMARY INDUSTRIES WATER AND ENVIRONMENT - JUNE 1999 ENDORSED BY BRIGHTON, CLARENCE, GLENORCHY, HOBART AND KINGBOROUGH CITY AND MUNICIPAL COUNCILS.

Title: Lot 1 - D 21805 - 6599m²
 Wind speed to AS4055 : **N**
 Soil Class to AS 2870 : **-**
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 BAL:

R & M Jackson




M2

SWMP 2

Hanna Batstone


Client : 397 Boyer Rd, Dromedary Tasmania 7030	Issue : DRAFT
Drawn by : DC / RJ	(not to be used for construction)
Date : April 2023	Sheet size A3
	Project No 23P0403

WHEN EXCAVATING TRENCH...

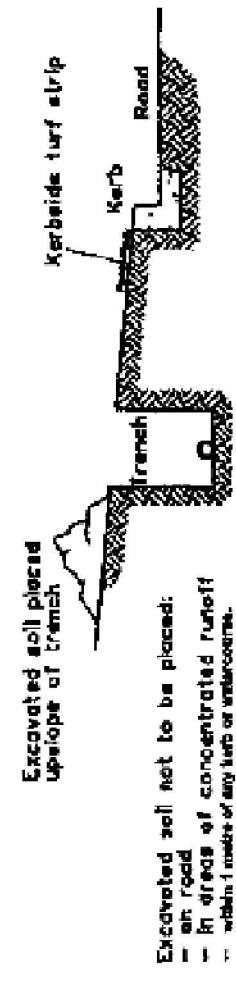


WHEN BACKFILLING TRENCH...

Backfilled trench backfilled with imported and compacted
topsoil or sand. If no topsoil available, the subsoil must
be removed and replaced by imported topsoil from a reliable
supplier. Remove all debris from the trench.

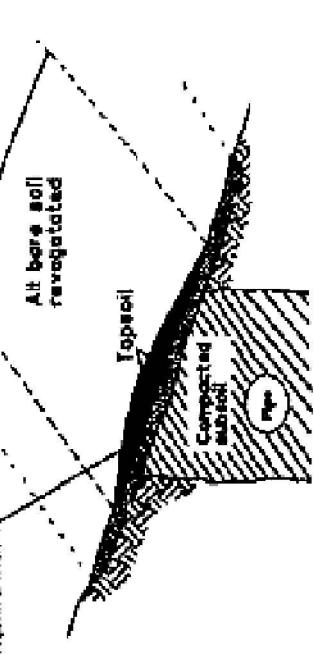

ON STEEP AND/OR LONG SECTIONS OF TRENCH...

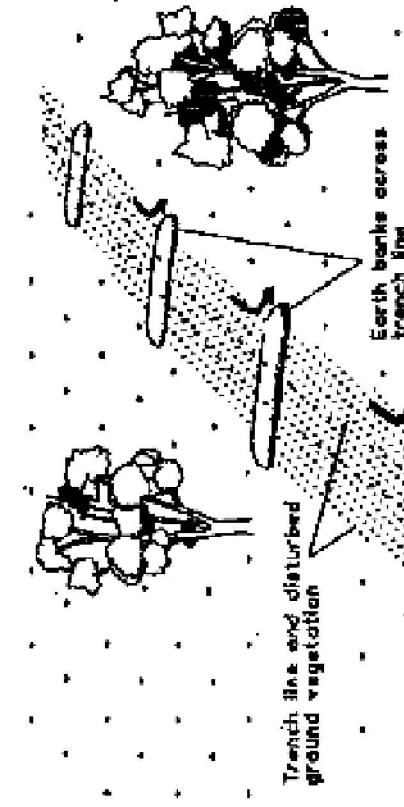

Construction Notes

1. Do not open any trench unless it is likely to be closed in three days.
2. Place excavated material upstream of trench.
3. Stockpile topsoil separately from subsoil.
4. Divert runoff from the line of the cut
5. Rehabilitate in accordance with specification.

SD 3 - Service Installation


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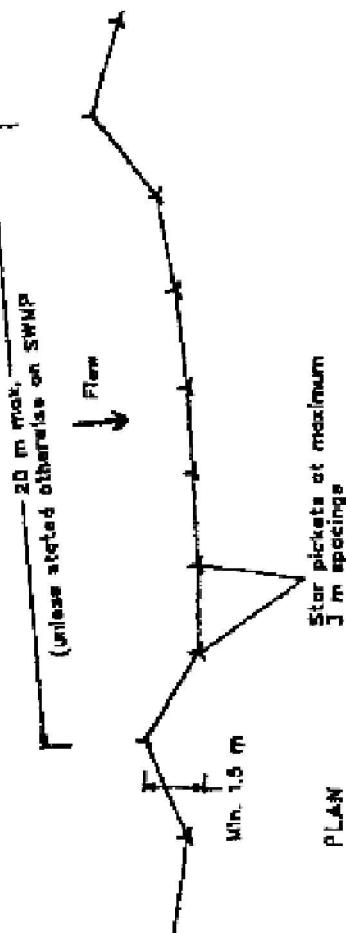
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[See Appendix B - Standard Drawing SD 3 for installation and construction details]

DETAILS EXTRACTED FROM "GUIDELINES FOR SOIL AND WATER MANAGEMENT" BY THE DEPARTMENT OF PRIMARY INDUSTRIES WATER AND ENVIRONMENT - JUNE 1999 ENDORSED BY BRIGHTON, CLARENCE, GLENORCHY, HOBART AND KINGBOROUGH CITY AND MUNICIPAL COUNCILS.




SECTION DETAIL

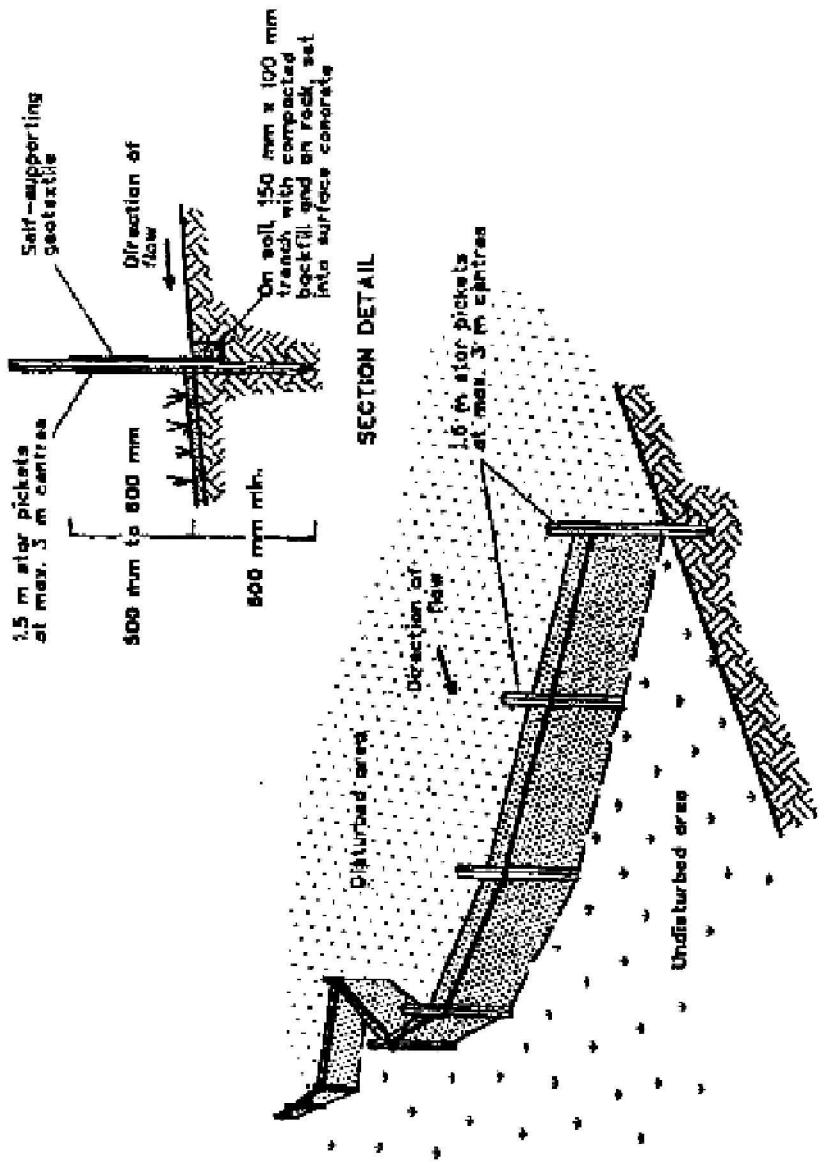

Construction Notes

1. Construct sediment fence as close as possible to parallel to the contours of the site.
2. Drive 1.5 metre long star pickets into ground, 3 metres apart.
3. Dig a 150 mm deep trench along the upslope line of the fence for the bottom of the fabric to be entrenched.
4. Backfill trench over base of fabric.
5. Fix self-supporting geotextile to upslope side of posts with wire ties or as recommended by geotextile manufacturer.
6. Join sections of fabric at a support post with a 150 mm overlap.

SD 8 - SEDIMENT FENCE

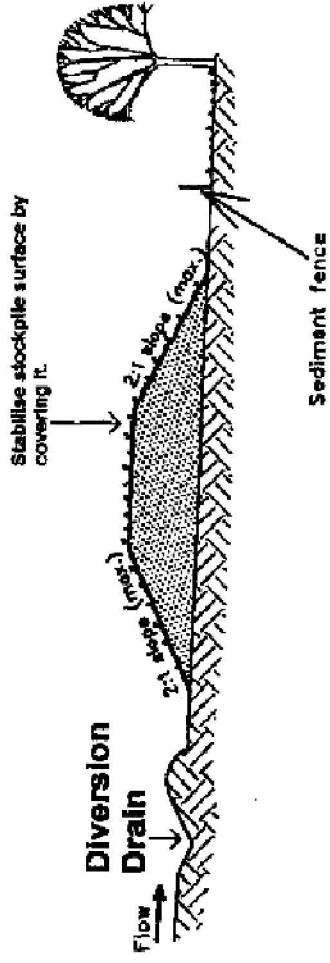

Construction Notes

1. Construct a diversion drain on upslope side of stockpile to divert water around stockpile and install a sediment fence 1-2 metres downslope of stockpile.
2. Locate stockpile at least 5 metres from existing bushland, concentrated water flows roads and other hazard areas.
3. Construct stockpile on the contour as a low, flat, elongated mound.
4. Where there is sufficient space, topsoil stockpiles shall be less than 2 metres high.
5. Rehabilitate in accordance with the SWMP.

SD 9 - STABILISING STOCKPILES

DETAILS EXTRACTED FROM "GUIDELINES FOR SOIL AND WATER MANAGEMENT" BY THE DEPARTMENT OF PRIMARY INDUSTRIES WATER AND ENVIRONMENT - JUNE 1999 ENDORSED BY BRIGHAM, CLARENCE, GLENORCHY, HOBART AND KINGBOROUGH CITY AND MUNICIPAL COUNCILS.

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R & M Jackson



Drafting Services
P. 03 6239 0119 E.:jacksondrafting@gmail.com
Accredited Building Practitioner Licence No: CC340Y

M4

Hanna Batstone
Client : 397 Boyer Rd, Dromedary Tasmania 7030
Issue : DRAFT
(not to be used for construction)

Project No
A3
Sheet size
23P0403

SWMP 4

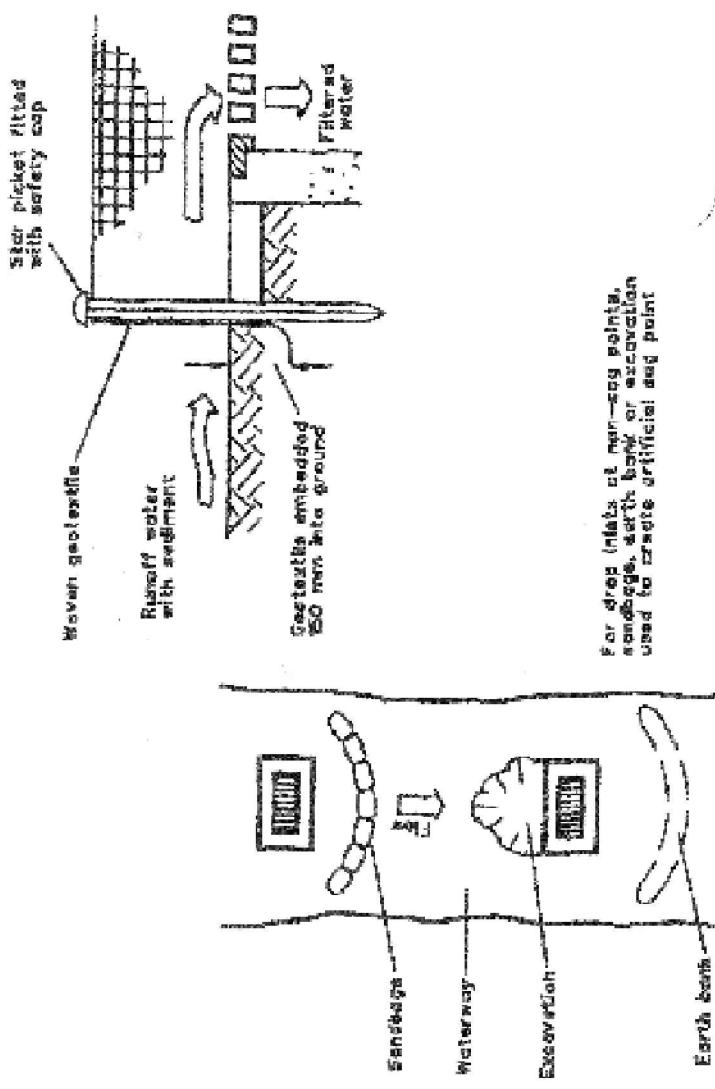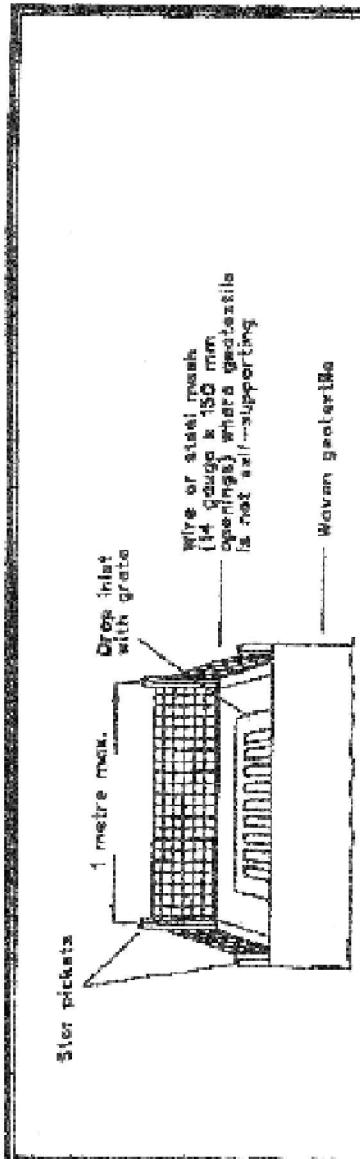

Construction Notes

1. Fabricate a sediment barrier made from geotextile.
2. Support geotextile with mesh tied to posts at 1 metre centres.
3. Do not cover inlet with geotextile.
4. Construction details are similar to those of SD 8.

SD 10 - Protecting on-site stormwater outlets

DETAILS EXTRACTED FROM "GUIDELINES FOR SOIL AND WATER MANAGEMENT" BY THE DEPARTMENT OF PRIMARY INDUSTRIES WATER AND ENVIRONMENT - JUNE 1999 ENDORSED BY BRIGHTON, CLARENCE, GLENORCHY, HOBART AND KINGBOROUGH CITY AND MUNICIPAL COUNCILS.

Title: Lot 1 - D 21805 - 6599m²
Wind speed to AS4055 : **N**
Soil Class to AS 2870 : **-**
Energy: refer report
BAL:

SWMP 5

R & M Jackson

Drafting Services
P. 03 6239 1019 E.:jacksondrafting@gmail.com
Accredited Building Practitioner Licence No: CC340Y

M5

Hanna Batstone

Client : 397 Boyer Rd., Dromedary Tasmania 7030
Issue : **DRAFT**
(not to be used for construction)
Drawn by : DC / RJ
Date : April 2023
Sheet size A3
Project No 23P0403