

Application for Planning Approval

Land Use Planning and Approvals Act 1993

APPLICATION NO.

DA2023/076

LOCATION OF AFFECTED AREA

2A VOLCANIC DRIVE, BRIGHTON

DESCRIPTION OF DEVELOPMENT PROPOSAL

DWELLING

A COPY OF THE DEVELOPMENT APPLICATION MAY BE VIEWED AT <u>www.brighton.tas.gov.au</u> AND AT THE COUNCIL OFFICES, 1 TIVOLI ROAD, OLD BEACH, BETWEEN 8:15 A.M. AND 4:45 P.M., MONDAY TO FRIDAY OR VIA THE QR CODE BELOW. ANY PERSON MAY MAKE WRITTEN REPRESENTATIONS CONCERNING AN APPLICATION UNTIL 4:45 P.M. ON **15/6/2023**. ADDRESSED TO THE GENERAL MANAGER AT 1 TIVOLI ROAD, OLD BEACH, 7017 OR BY EMAIL AT <u>development@brighton.tas.gov.au</u>. REPRESENTATIONS SHOULD INCLUDE A DAYTIME TELEPHONE NUMBER TO ALLOW COUNCIL OFFICERS TO DISCUSS, IF NECESSARY, ANY MATTERS RAISED.

JAMES DRYBURGH General Manager







Proposed Residential Development – Lot 2 Volcanic Drive, Brighton

Bushfire Hazard Report

Applicant: Wilson Homes Job No. 713350



November 2022 J5855v1.0

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Attachment 1 – Bushfire Hazard Management Plan Attachment 2 - Certificate of Others (form 55)

Disclaimer

The measures contained in Australian Standard 3959-2018 cannot guarantee that a building will survive a bushfire event on every occasion. This is substantially due to the unpredictable nature and behaviour of fire and extreme weather conditions.

Reasonable steps have been taken to ensure that the information contained within this report is accurate and reflects the conditions on and around the lot at the time of assessment. The assessment has been based on the information provided by you or your designer.

Authorship

This report was prepared by Mark Van den Berg BSc. (Hons.) FPO (planning) of Geo Environmental Solutions. Base data for mapping: TasMap, Digital and aerial photography: Mark Van den Berg, GoogleEarth.

1.0 Purpose

This bushfire hazard report is intended to provide information in relation to the proposal. It will demonstrate compliance with the *Building Regulations 2016*, and the *Directors Determination – Bushfire Hazard Areas*, *version 1.1, 12th April 2021*. Provide a certificate of others (form 55) as specified by the Director of Building Control for bushfire hazard and give guidance by way of a certified bushfire hazard management plan which shows a means of protection from bushfires in a form approved by the Chief Fire Officer of the Tasmania Fire Service.

2.0 Summary

Site details & compliance

Title reference	ТВА
PID	ТВА
Address	Lot 2 Volcanic Drive, Brighton
Applicant	Wilson Homes
Municipality	Brighton
Planning Scheme	Tasmanian Planning Scheme - Brighton
Zoning	Rural Living
Land size	~0.5Ha
Bushfire Attack Level	BAL-12.5
Certificate of others (form 55)	Complete and attached
Bushfire Hazard Management Plan	Certified & Attached

Development of a new class 1a building at Lot 2 Volcanic Drive, Brighton requires demonstrated compliance with *Building Regulations 2016*, and the *Directors Determination – Bushfire Hazard Areas*, *version 1.1, 12th April 2021*, the site is located in a bushfire prone area. The Bushfire attack level has been determined as BAL-12.5, provisions for construction standards, hazard management areas, property access and water supplies for firefighting will be required as detailed in this report and on the Bushfire Hazard Management Plan (BHMP).

3.0 Introduction

This bushfire hazard report has been completed to form part of supporting documentation for a building permit application for the proposed development. The proposed development site has been identified as being in a bushfire prone area. A site-specific bushfire hazard management plan has been provided for compliance purposes.

4.0 Proposal

The proposal is for the construction of a new class 1a building at Lot 2 Volcanic Drive, Brighton (appendix B). Construction standards for buildings, property access, water supplies for firefighting and hazard management areas will be required (as appropriate) to meet the standards outlined in the '*Directors Determination – Bushfire Hazard Areas, version 1.1, 12th April 2021*' and '*Australian Standard 3959-2018 Construction of Buildings in Bushfire-prone Areas.*

5.0 Bushfire Attack Level (BAL) Assessment

5.1 Methods

The Bushfire attack level has been determined through the application of section 2 of AS3959-2018 'Simplified Procedure'. Vegetation has been classified using a combination of onsite observations and remotely sensed data to be consistent with table 2.3 of AS359-2018. Slope and distances have been determined by infield measurement and/or the use of remotely sensed data (aerial/satellite photography, GIS layers from various sources) analysed with proprietary software systems. Where appropriate vegetation has been classified as low threat.

5.2 Site Description

The proposal is located at Lot 2 Volcanic Drive, Brighton, in the municipality of Brighton and is zoned rural living under the Tasmanian Planning Scheme - Brighton. Access to the lot will be by an existing crossover from Volcanic Drive, a council-maintained road. The lot is ~0.5 Ha, is irregular in shape and is located approximately 3.7 km south-east of Winton Hill (Figure 1).

Adjacent lands surrounding the lot are zoned rural living and carry bushfire prone vegetation. At a landscape scale the lot occurs in a rural setting characterised by grassland vegetation with dispersed residential development. The lot is has gentle to moderate slopes a northerly aspect which may influence fire behaviour.

Vegetation surrounding the lot was assessed (Table 1) and described as 'grassland' or excluded from tyeh assessment as low threat vegetation (as per AS3959-2018). The classified vegetation potentially having the greatest impact on the site occurs to the north of the site (Figure 2). The vegetation classification system as defined in AS 3959-2018 Table 2.3 and Figure 2.4 (A to H) has been used to determine vegetation types within 100 metres of the site (Table 1).

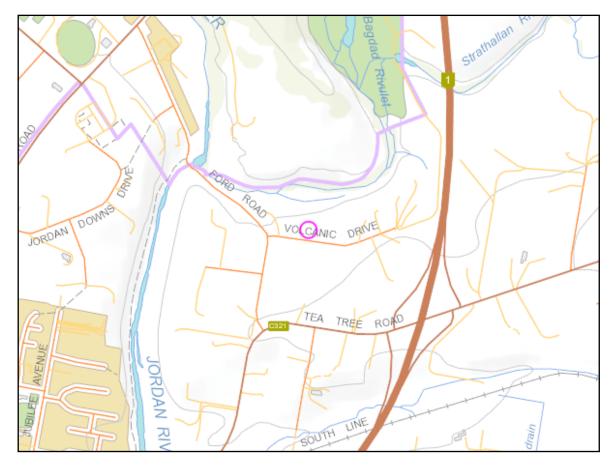


Figure 1. The site in a topographical context (lot outlined in pink).



Figure 2. Shows the approximate location of the site (pink line) in the context of the adjacent lands and classified vegetation.

Table 1. Bushfire Attack Level (BAL) Assessment

Azimuth	Vegetation Classification	Effective Slope	Distance to Bushfire-prone vegetation	Hazard management area width	Bushfire Attack Level
	Grassland^	>10° to 15° downslope	0 to 100 metres		
North				22 metres	BAL-12.5
	Grassland^	flat 0°	0 to 11 metres		
	Exclusion 2.2.3.2 (e, f)^^			541 1 014	
East				11 metres BAL-L	BAL-LOW
	Grassland^	flat 0°	0 to 21 metres		
	Exclusion 2.2.3.2 (e, f)^^	flat 0°	21 to 37		
South	Grassland^	flat 0°	37 to 100 metres	14 metres	BAL-12.5
	Grassland^	flat 0°	0 to 10 metres		
	Exclusion 2.2.3.2 (e, f)^^	flat 0°	11 to 45 metres		
West	Low Open Woodland	flat 0°	45 to 100 metres	10 metres	BAL-12.5

Vegetation classification as per AS3959-2018 and Figures 2.4(A) to 2.4(H).
Low threat vegetation as per Bushfire Prone Areas Advisory Note (BHAN) No.1-2014, version 3, 8/11/2017.
Exclusions as per AS3959-2018, section 2.2.3.2, (a) to (f).

6.0 Results

The bushfire attack level for the site has been determined as BAL-12.5. While the risk is considered to be low, there is a risk of ember attack and a likelihood of low levels of radiant heat impacting the site. The construction elements are expected to be exposed to a heat flux not greater than 12.5 kW/m².

6.1 Property Access

Property access is not required to access a firefighting water connection point, in this circumstance there are no addition design or construction specifications required for property access.

6.2 Water Supplies for Firefighting

Dedicated water supplies for firefighting will be provided by an existing fire hydrant connected to a reticulated water supply system managed by Tas Water. The existing hydrant will be required to conform with the following specifications;

• The building area to be protected must be located within 120 metres of a fire hydrant; and

• The distance must be measured as a hose lay, between the firefighting water point and the furthest part of the building area.

6.3 Hazard Management Area.

A hazard management area will need to be established and maintained for the life of the development and is shown on the BHMP. Guidance for the establishment and maintenance of the hazard management area is given below and on the BHMP.

A hazard management area is the area, between a habitable building or building area and the bushfire prone vegetation, which provides access to a fire front for firefighting, which is maintained in a minimal fuel condition and in which there are no other hazards present which will significantly contribute to the spread of a bushfire. This can be achieved through, but is not limited to the following strategies;

- Remove fallen limbs, sticks, leaf and bark litter;
- Maintain grass at less than a 100mm height;
- Avoid the use of flammable mulches (especially against buildings);
- Thin out under-story vegetation to provide horizontal separation between fuels;
- Prune low-hanging tree branches (<2m from the ground) to provide vertical separation between fuel layers;
- Remove and or prune larger trees to maintain horizontal separation between canopies;
- Minimise the storage of flammable materials such as firewood;
- Maintain vegetation clearance around vehicular access;
- Use low-flammability plant species for landscaping purposes where possible;
- Clear out any accumulated leaf and other debris from roof gutters and other debris accumulation points.

7.0 Compliance

Table 3. Compliance with the Directors Determination Requirements for Building in Bushfire Hazard Areas, *version 1.1, 12th April 2021*.

Requirements	Compliance
2.3.1 Design & Construction Requirements	Clause 2.3.1 requires buildings to be constructed in accordance with AS3959-2018 or NASH standard – Steel Framed Construction in Bushfire Areas consistent with the BAL determined for the site.
	The BHMP specifies construction to BAL-12.5 standards of AS3959-2018.
	If the proposed buildings are designed and constructed in accordance with BAL-12.5 construction standards the development will comply with clause 2.3.1.
2.3.2 Property Access	Clause 2.3.2 requires property access to be designed and constructed to comply with table 2 of the determination and is applicable from the public roadway to within (at minimum) 90 metres of the furthest part of the building/s and includes access to a hardstand for the firefighting water point. There are no specific requirements for property access in this circumstance, the proposal is compliant with table 2.
	If the property access is designed and constructed in accordance with the requirements of section 6.1 of this report, the proposal will comply with clause 2.3.2.
2.3.3 Water Supply for Firefighting	Clause 2.3.3 requires that a new building constructed in a bushfire-prone area is provided with a dedicated firefighting water supply in accordance with tables 3A or 3B.
	Reticulated water supplies consistent with table 3A have been specified in this report and are required for compliance on the BHMP.
	If the requirements of section 6.2 of this report are implemented the proposal will comply with clause 2.3.3.
2.3.4 Hazard management areas	Hazard management areas specified which are consistent with table 4 and which achieve the minimum separation dimensions required for the BAL assessed of table 2.6 of AS3959.
3. Bushfire hazard management plan and certificate	A bushfire hazard management plan has been prepared for work for which this division applies and has been certified in accordance with the Chief Officers requirements by an accredited person.
4.5 Emergency Plan	The proposal is for alterations and additions to a class 1a building and therefore in this circumstance Emergency Plans are not required for compliance.

8.0 Guidance

The defendable space (hazard management area) around a building is critical for providing occupants and/or fire fighters with safe access to the building in order that fire fighting activities may be under taken. The larger the defendable space, the safer it will be for those defending the structure. Some desirable characteristics of a hazard management area are:

- The area directly adjacent to the building has a significant amount of flammable material removed such that there is little to no material available to burn around the building;
- Includes non flammable areas such as paths, driveways, short cropped lawns;
- Establishment of orchards, vegetable gardens, dams or waste water effluent disposal areas on the fire prone side of the building;
- Creating wind breaks and radiation shields such as non combustible fences and low flammability hedges;
- It is not necessary to remove all vegetation from the defendable space, trees can provide protection from wind borne embers and radiant heat in some circumstances.

9.0 Further Information

For further information on preparing yourself and your property for bushfires visit the Tasmania Fire Service website at <u>www.fire.tas.gov.au</u> or phone 1800 000 699 for information on:

- Preparing a bushfire survival plan
- Preparing yourself and your home for a bushfire
- Guidelines for development in bushfire prone areas in Tasmania
- Fire resisting plants for the urban fringe and rural areas
- Using fire outdoors
- Fire permits
- Total fire bans
- Bushfires burning in Tasmania

10.0 References

Australian Building Codes Board, *National Construction Code, Building Code of Australia,* Australian Building Codes Board, Canberra.

Building Amendment (Bushfire-Prone Areas) Regulations 2016

Directors Determination – Bushfire Hazard Areas, version 1.1, 12th April 2021

The Bushfire Planning Group 2005, *Guidelines for development in bushfire prone areas of Tasmania* – *Living with fire in Tasmania*, Tasmania Fire Service, Hobart.

Tasmania Fire Service 2013, Building for Bushfire – Planning and Building in Bushfire-Prone Areas for Owners and Builders.

Tasmanian Planning Scheme - Brighton. Tasmanian Planning Commission Hobart 2020.

Standards Australia, AS3959-2018 Construction of buildings in bushfire-prone areas. Sydney, NSW., Australia.

11.0 Limitations Statement

This Bushfire Hazard Report has been prepared in accordance with the scope of services between Geo-Environmental Solutions Pty. Ltd. (GES) and the applicant named in section 2. To the best of GES's knowledge, the information presented herein represents the Client's requirements at the time of printing of the Report. However, the passage of time, manifestation of latent conditions or impacts of future events may result in findings differing from that described in this Report. In preparing this Report, GES has relied upon data, surveys, analyses, designs, plans and other information provided by the Client and other individuals and organisations referenced herein. Except as otherwise stated in this Report, GES has not verified the accuracy or completeness of such data, surveys, analyses, designs, plans and other information.

The scope of this study does not allow for the review of every possible bushfire hazard condition and does not provide a guarantee that no loss of property or life will occur as a result of bushfire. As stated in AS3959-2018 "It should be borne in mind that the measures contained in this Standard cannot guarantee that a building will survive a bushfire event on every occasion. This is substantially due to the degree of vegetation management, the unpredictable nature and behaviour of fire, and extreme weather conditions". In addition, no responsibility is taken for any loss which is a result of actions contrary to AS3959-2018 or the Tasmanian Planning Commission Bushfire code.

This report does not purport to provide legal advice. Readers of the report should engage professional legal practitioners for this purpose as required. No responsibility is accepted for use of any part of this report in any other context or for any other purpose by third party.

Appendix A - Site Photos



Figure 3. Northern azimuth from the site.




Figure 4. Eastern azimuth from the site.



Figure 5. Southern azimuth from the site.




Figure 6. Western azimuth from the site.

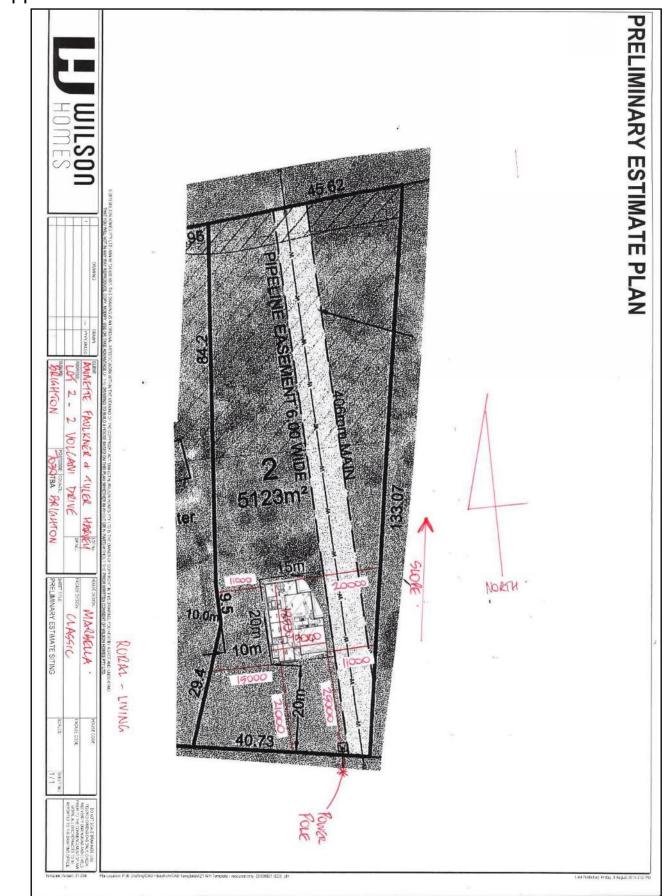

Appendix B – Site Plan

BUSHFIRE HAZARD MANAGEMENT PLAN

Bushfire Hazard Management Plan, Lot 2 Volcanic Drive, Brighton, October 2022 J5855v1. Tasmanian Planning Scheme - Brighton

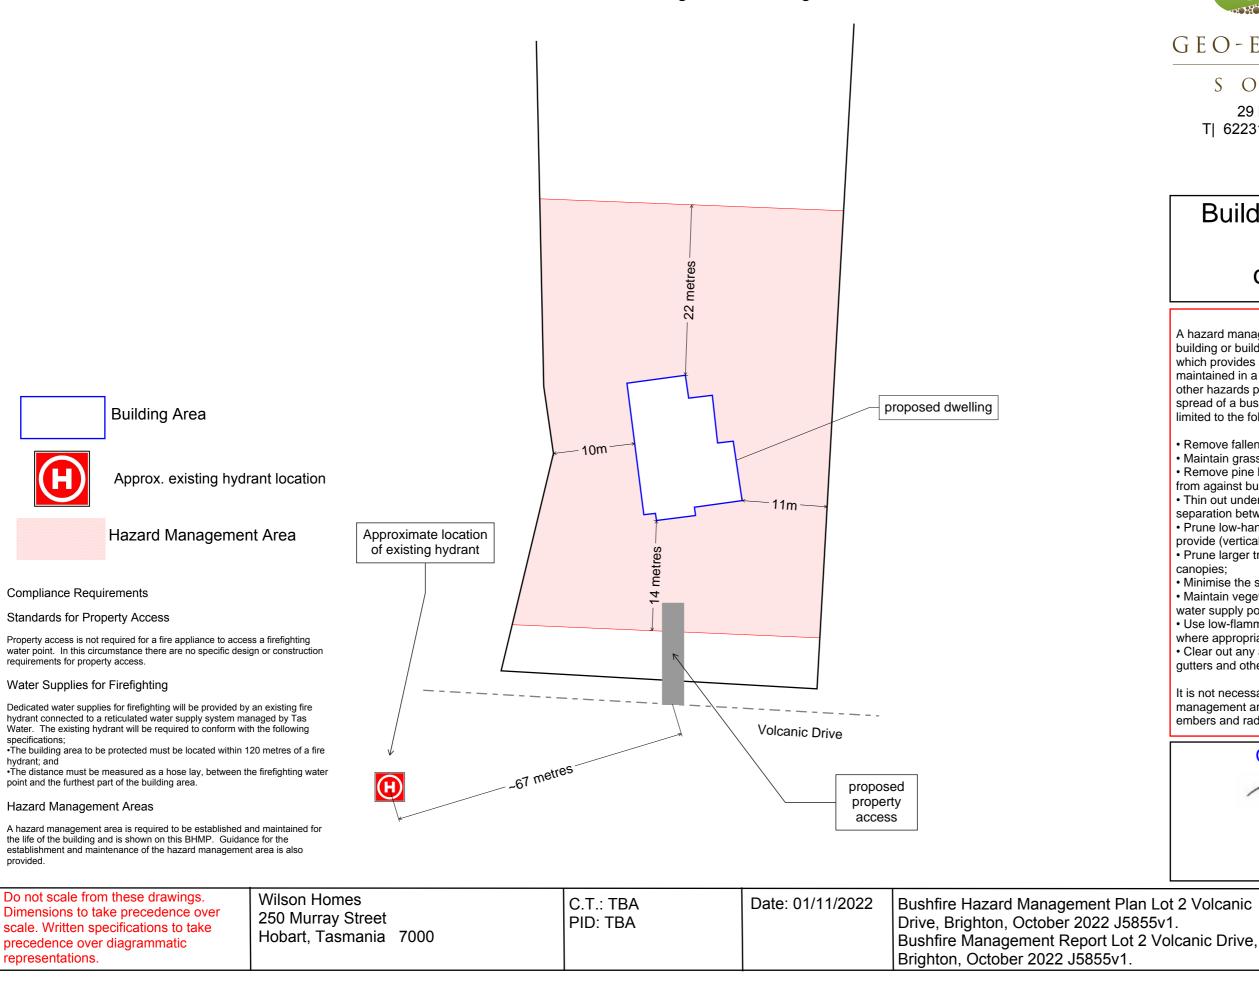



GEO-ENVIRONMENTAL

SOLUTIONS

29 Kirksway Place, Battery Point. T| 62231839 E| office@geosolutions.net.au

Building Specifications to BAL-12.5 of AS3959-2018

Hazard Management Area

A hazard management area is the area, between a habitable building or building area and the bushfire prone vegetation, which provides access to a fire front for firefighting, which is maintained in a minimal fuel condition and in which there are no other hazards present which will significantly contribute to the spread of a bushfire. This can be achieved through, but is not limited to the following actions;

- Remove fallen limbs, sticks, leaf and bark litter;
- Maintain grass at less than a 100mm height;
- · Remove pine bark and other flammable mulch (especially from against buildings);
- Thin out under-story vegetation to provide horizontal separation between fuels;
- Prune low-hanging tree branches (<2m from the ground) to provide (vertical separation between fuel layers;
- Prune larger trees to maintain horizontal separation between canopies:
- Minimise the storage of flammable materials such as firewood; Maintain vegetation clearance around vehicular access and water supply points;
- Use low-flammability species for landscaping purposes where appropriate;
- · Clear out any accumulated leaf and other debris from roof gutters and other accumulation points.

It is not necessary to remove all vegetation from the hazard management area, trees may provide protection from wind borne embers and radiant heat under some circumstances.

Certification No. J5855

Muladertra

Mark Van den Berg Acc. No. BFP-108 Scope 1, 2, 3A, 3B, 3C.

Drawing Number: A01

Sheet 1 of 1 Prepared by: MvdB

CERTIFICATE OF QUALIFIED PERSON – ASSESSABLE ITEM

Section 321

To:	Wilson Homes			Owner /Agent	55						
	250 Murray Street			Address	Form 55						
	Hobart TAS	7	000	Suburb/postcode							
Qualified perso	on details:										
Qualified person:	Mark Van den Berg										
Address:	29 Kirksway Place										
	Battery Point TAS	004	Fax No:								
Licence No:	BFP - 108 Email address: m	vand	enberg	@geosolutio	ns.net.au						
Qualifications and Insurance details:	Accredited to report on bushfin hazards under Part IVA of the Service Act. BFP-108 scope 1, 2, 3a, 3b, 3 Sterling Insurance PI policy No 17080170	Fire c.	Directo	ption from Column : r's Determination - alified Persons for A	Certificates						
Speciality area of expertise:	Analysis of bushfire hazards ir bushfire prone areas	1	Directo	iption from Column or's Determination - alified Persons for A	Certificates						
Details of work	(:										
Address:	Lot 2 Volcanic Drive				Lot No: TBA						
	Brighton TAS	7	030	Certificate of t	TBA						
The assessable item related to this certificate:	New building work (alterations additions) in a bushfire prone			certified) Assessable item i - a material; - a design - a form of con - a document - testing of a co system or plu							
Certificate deta	ails:										
Certificate type:	Bushfire Hazard		Schedule Determin	on from Column 1 c 1 of the Director's ation - Certificates k Persons for Assess	<i>by</i>						
This certificate is in relation to the above assessable item, at any stage, as part of - (<i>tick one</i>) building work, plumbing work or plumbing installation or demolition work:											

a building, temporary structure or plumbing installation:

In issuing this certificate the following matters are relevant –

Documents:	Bushfire Hazard Report Lot 2 Volcanic Drive, Brighton, October 2022 J5855v1.
	Bushfire Hazard Management Plan Lot 2 Volcanic Drive, Brighton, October 2022 J5855v1.
	And Form 55
Relevant	
calculations:	Not Applicable.
References:	
	Directors Determination – Bushfire Hazard Areas, version 1.1, 12 th April 2021. Consumer, Building and Occupational Services, Department of Justice, Tasmania. Building Amendment (Bushfire-Prone Areas) Regulations 2016 Standards Australia 2018, Construction of buildings in bushfire prone areas, Standards Australia, Sydney
	Substance of Cortificato: (what it is that is being earlierd)

Substance of Certificate: (what it is that is being certified)

The Bushfire Attack Level for the proposal is **BAL-12.5**. All specifications of the Bushfire hazard management plan and report to be implemented for compliance.

Scope and/or Limitations

Scope: This report was commissioned to identify the Bushfire Attack Level for the existing property. Limitations: The inspection has been undertaken and report provided on the understanding that;-1. The report only deals with the potential bushfire risk all other statutory assessments are outside the scope of this report. 2. The report only identifies the size, volume and status of vegetation at the time the site inspection was undertaken and cannot be relied upon for any future development. 3. Impacts of future development and vegetation growth have not been considered.

I certify the matters described in this certificate.

Qualified person:

Alada

Signed:

Certificate No: J5855 *Date:* 1/112022

SHEET INDEX

COVER SHEET
SITE PLAN 1:200
SITE PLAN 1:500
GROUND FLOOR PLAN
ELEVATIONS / SECTION
ELEVATIONS
WINDOW & DOOR SCHEDULES
ROOF DRAINAGE
FLOOR COVERINGS
KITCHEN DETAILS
BATHROOM DETAILS
WC DETAILS
ENSUITE DETAILS
LAUNDRY DETAILS

BUILDING INFORMATION

GROUND FLOOR TOP OF WALL HEIGHT(S): (CEILING HEIGHT 45mm LOWER THAN TOP ROOF PITCH (U.N.O.): ELECTRICITY SUPPLY: GAS SUPPLY:	
ROOF MATERIAL: ROOF COLOUR:	SHEET METAL DARK
WALL MATERIAL:	BRICK VENEER

INSULATION

10

11

12

13

14

INSULATION TO BE INSTALLED IN ACCORDANCE WITH N.C.C. AND RELEVANT AUSTRALIAN STANDARDS

MIN. 60mm FOIL FACED BLANKET UNDER ROOFING CEILING: R4.1 BATTS (EXCL. GARAGE, ALFRESCO & PATIO)

EXTERIOR WALLS: R2.0 BATTS (EXCL. GARAGE) WALL WRAP TO ENTIRE HOUSE INTERIOR WALLS: R2.0 BATTS WHERE SHOWN ON PLANS AND WHERE ADJACENT TO GARAGE / SUBFLOOR / ROOF SPACES / SKYLIGHTS

B&J WITH AIRCELL FLOOR INSULATION: R2.0 BATTS TO FLOOR SPACES ABOVE PORCH /ALFRESCO / GARAGE AREAS, IF APPLICABLE

SITE & ENGINEERING INFORMATION

DESIGN WIND CLASSIFICATION: CLIMATE ZONE: WIND REGION TERRAIN CATEGORY: SHIELDING FACTOR: TOPOGRAPHIC CLASSIFICATION: DESIGN WIND SPEED:

N3 ZONE 7 - COOL TEMPERATE А

SITE CLASSIFICATION: SLAB CLASSIFICATION:

SLAB TO BE IN ACCORDANCE WITH AS 2870. REFER TO ENGINEER'S DRAWINGS FOR ALL SLAB DETAILS.

PROVIDE BRICK CONTROL JOINTS IN ACCORDANCE WITH N.C.C.

ALL TIMBER FRAMING TO BE DESIGNED TO AS1684-2010

BAL-12.5 BUSHFIRE REQUIREMENTS

THE BUILDER USES MATERIALS THAT HAVE BEEN TESTED TO AS1530.8.1 IN ACCORDANCE WITH AS3959-2018 (CLAUSE 3.8).


- PROVIDE FOIL FACED BLANKET INSULATION TO COLORBOND SHEET ROOFING
- PROVIDE SARKING TO TILED ROOF WITH PRESTITE TO VALLEYS
- PROVIDE FLYSCREENS WITH CORROSION RESISTANT MESH TO ALL OPERABLE WINDOW SASHES (NO REQUIREMENT TO SCREEN BI-FOLD/FRENCH/SLIDING/STACKER DOORS) - PROVIDE BAL-12.5 RATED ALUMINIUM WINDOWS AND
- EXTERNAL GLASS SLIDING/STACKER DOORS
- SPECIFIED ALUMINIUM FRENCH DOORS HAVE BEEN TESTED TO AS1530.8.1 WITHOUT SCREENS
- SPECIFIED ALUMINIUM WINDOWS HAVE BEEN TESTED TO AS1530.8.1 WITHOUT SCREENS TO FIXED PANELS PROVIDE ALUMINIUM DOOR JAMBS TO ALL EXTERNAL
- TIMBER DOORS
- PROVIDE SPARK ARRESTORS TO EXTERNAL BRICKWORK - PROVIDE SEAL TO GARAGE DOOR
- EXTERNAL TIMBER POSTS TO BE FIRE RETARDANT
- PROVIDE COPPER WATER PIPES FROM WATER TANK TO HOUSE

(IF REQUIRED)

- PROVIDE MERBAU TIMBER POSTS AND EXPOSED BEAMS TO PATIO
- PROVIDE SAFETY SCREENS WITH CORROSION RESISTANT MESH AND DIAMOND GRILLE TO EXTERNAL HUNG DOORS



SITE LOCATION-

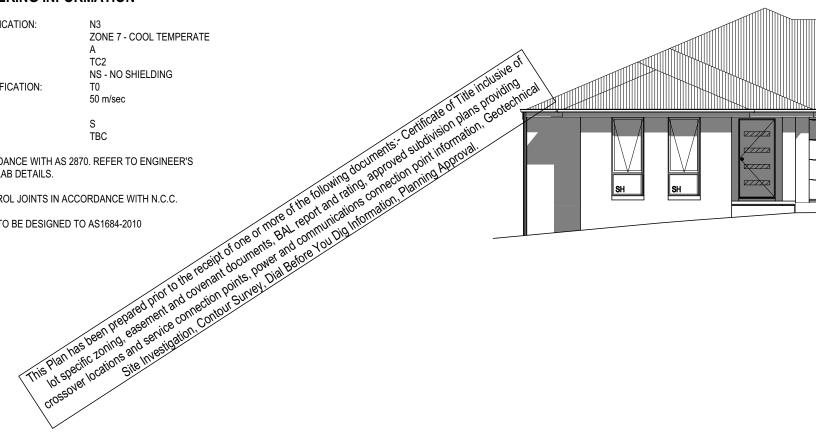

PRELIMINARY PLAN SET


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2	PRELIMINARY PLAN SET - INITIAL ISSUE	ALL	2023.04.04	SSL	MSP
No.	AMENDMENT	SHEET	DATE	DRAWN	CHECK

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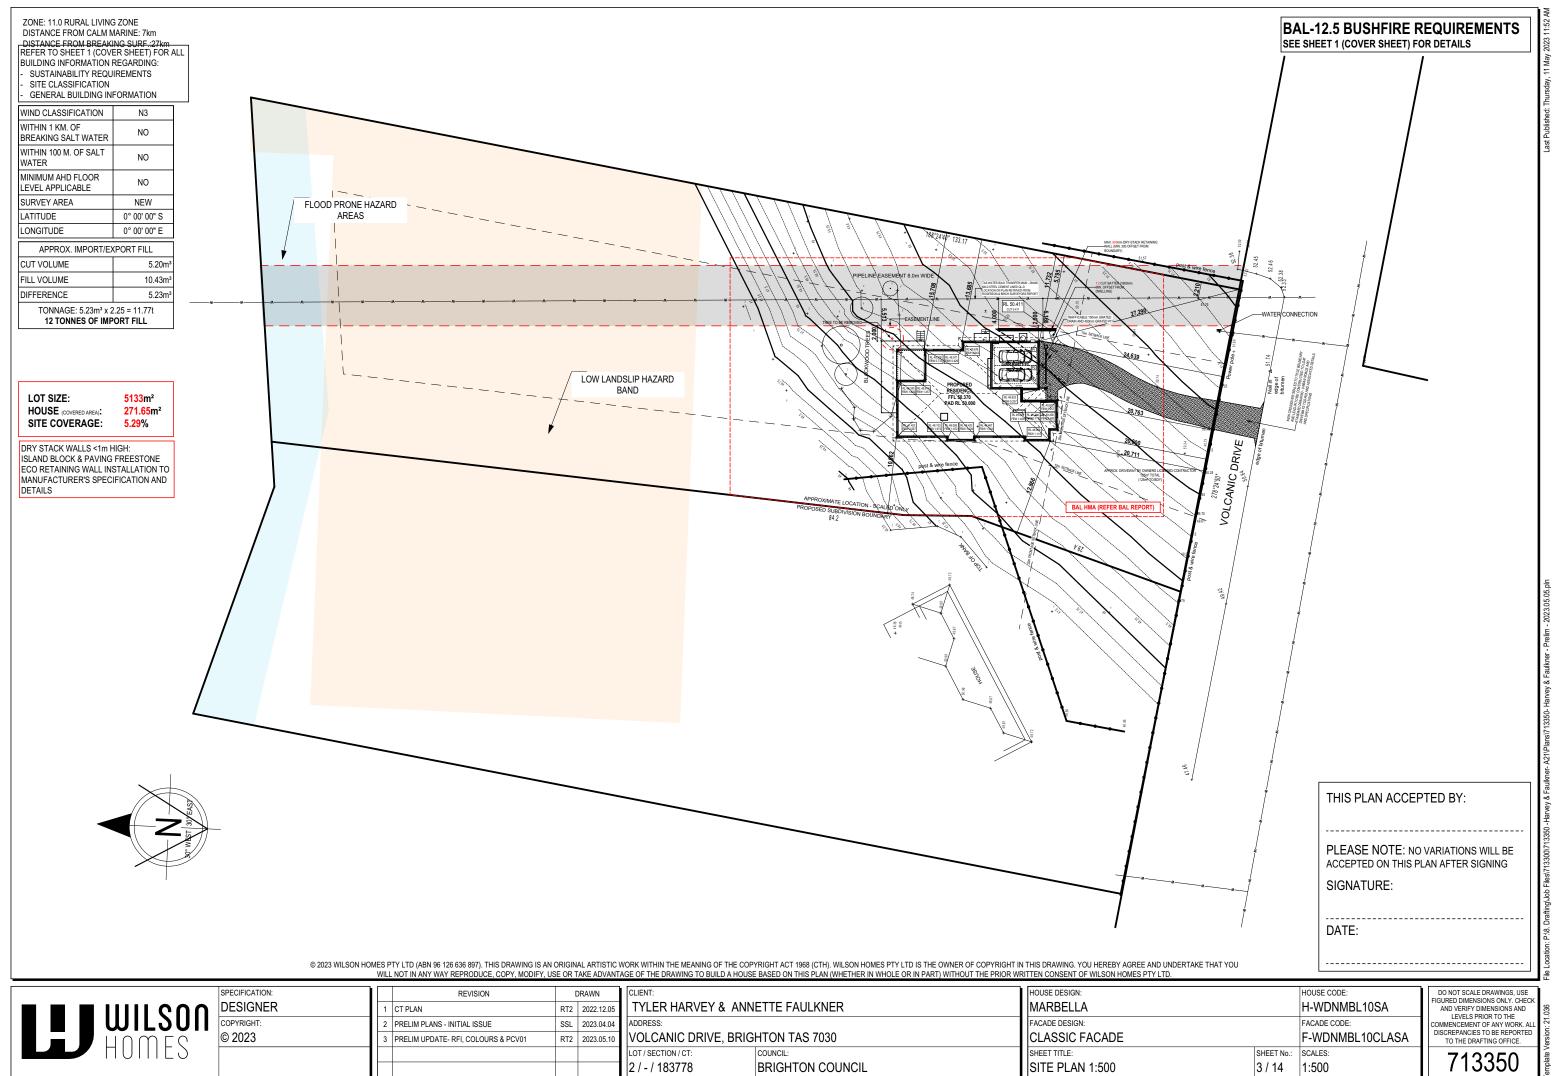
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		2	PRELIM PLANS - INITIAL ISSUE SSL	2023.04	04.04	ADDRESS:		FACADE DESIGN:
	© 2023	3	PRELIM UPDATE- RFI, COLOURS & PCV01 RT2	2023.0	05.10	VOLCANIC DRIVE, BRIG	HTON TAS 7030	CLASSIC FACADE
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						2 / - / 183778	BRIGHTON COUNCIL	COVER SHEET




LOCATION MAP THIS PLAN ACCEPTED BY: PLEASE NOTE: NO VARIATIONS WILL BE ACCEPTED ON THIS PLAN AFTER SIGNING SIGNATURE: -----DATE: -----HOUSE CODE DO NOT SCALE DRAWINGS, USE FIGURED DIMENSIONS ONLY, CHEC H-WDNMBL10SA AND VERIFY DIMENSIONS AND I EVELS PRIOR TO THE FACADE CODE: COMMENCEMENT OF ANY WORK. AL DISCREPANCIES TO BE REPORTED F-WDNMBL10CLASA TO THE DRAFTING OFFICE. SHEET No .: SCALES: 713350 1/14

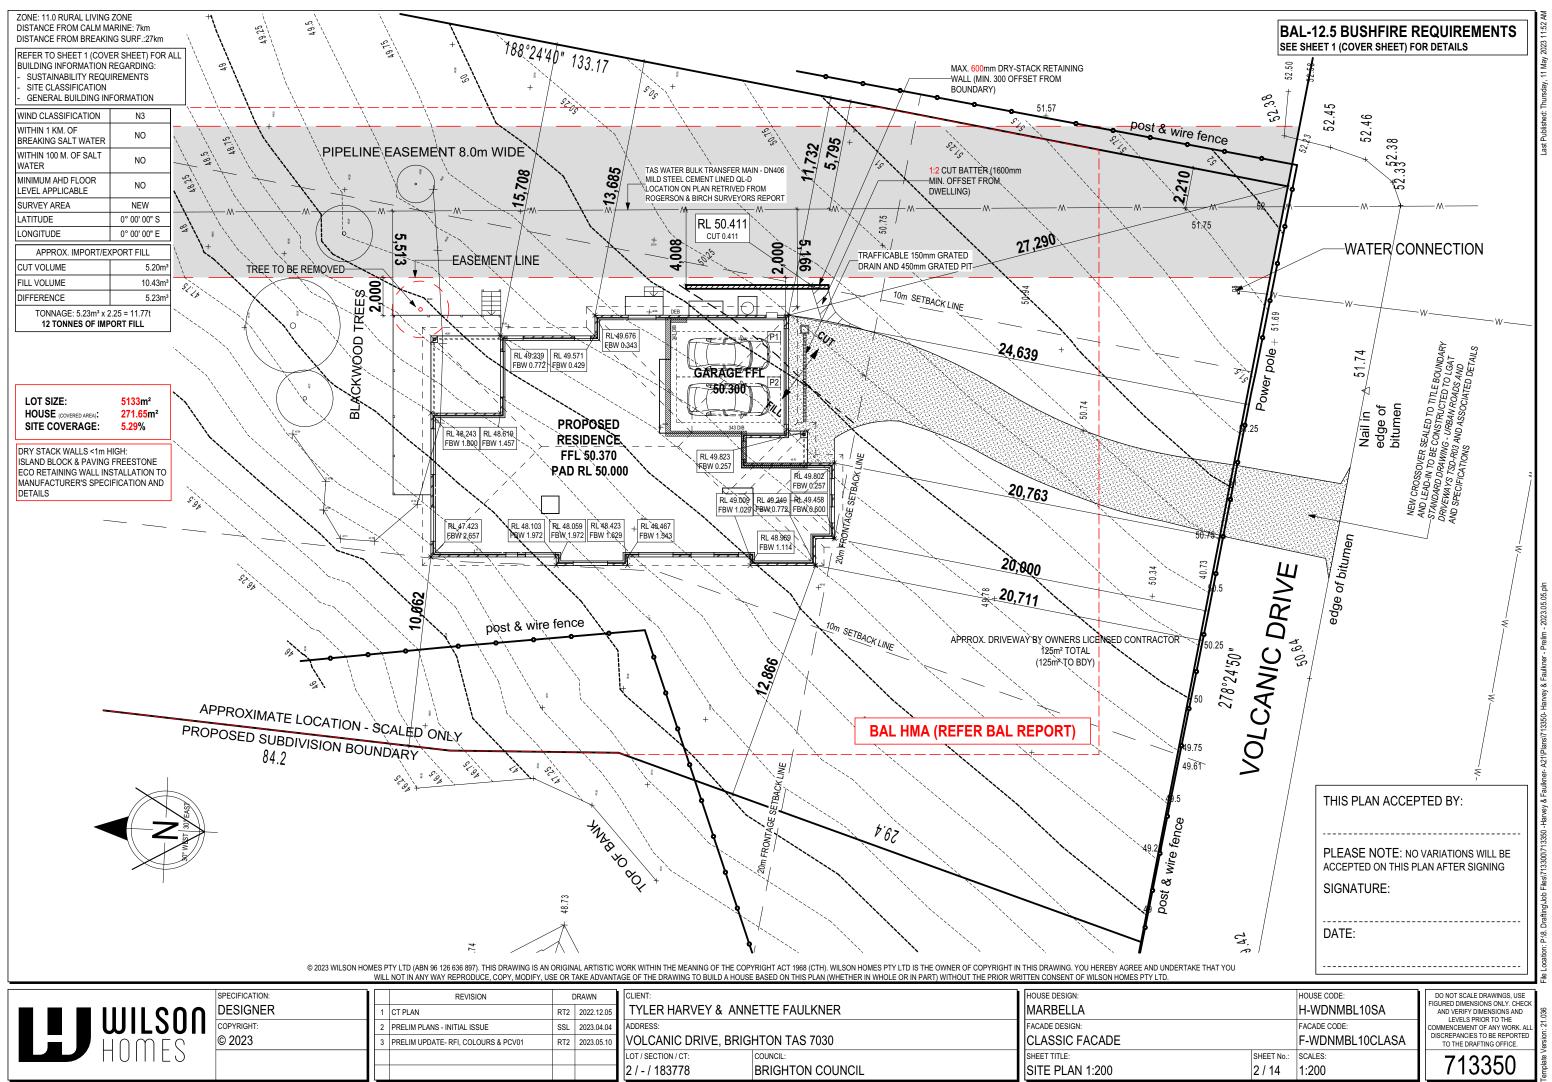


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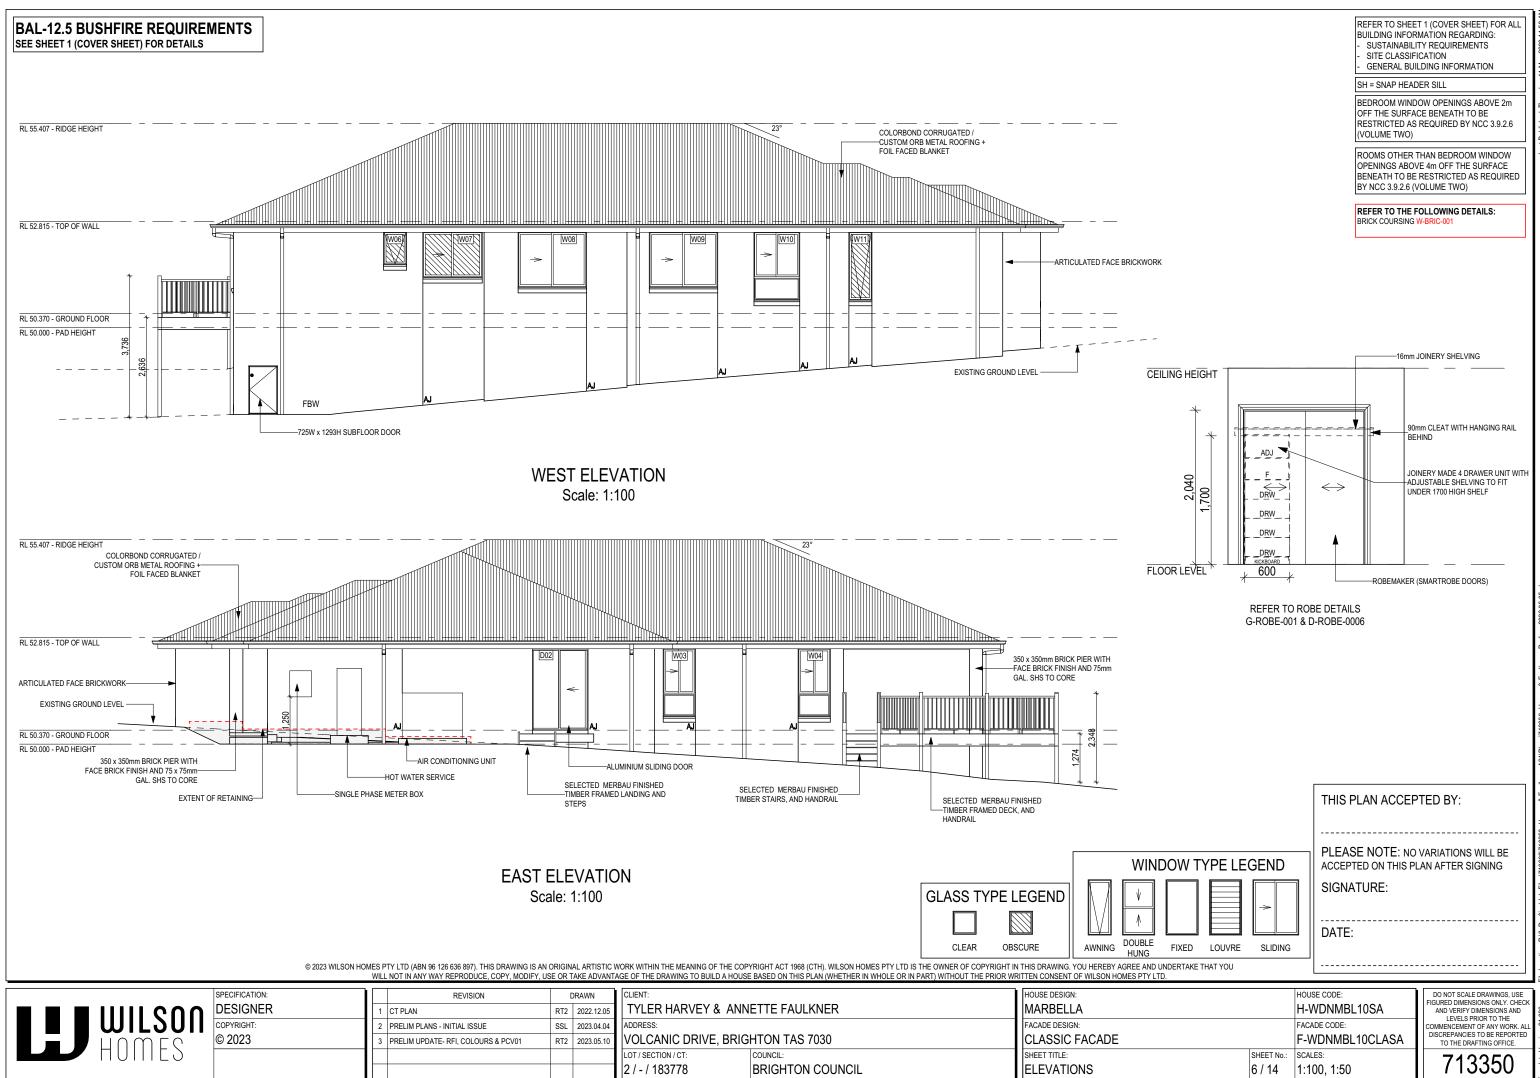
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HU	IIIES						LOT / SECTION / CT:	COUNCIL:	SHEET TITLE:
							2 / - / 183778	BRIGHTON COUNCIL	SITE PLAN 1:500



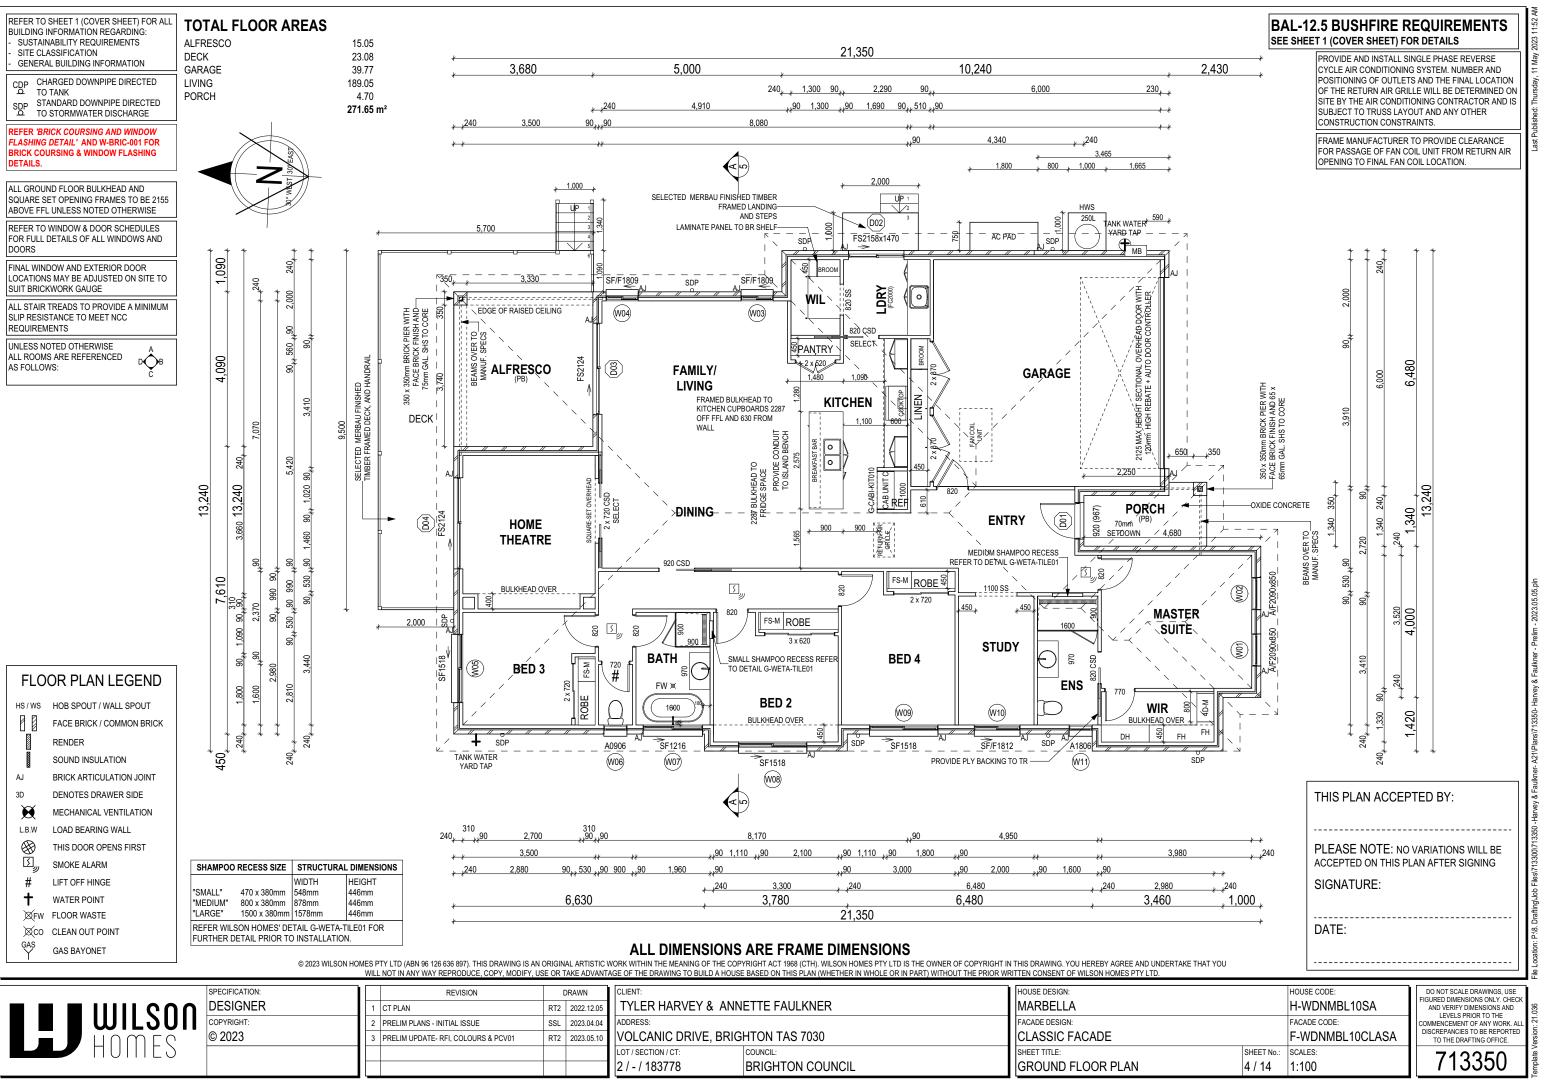

1/13530 - Haivey & Faukrier- Az Inflansv 135300- haivey & Faukrier - Fleiin - 2023.03.03.01

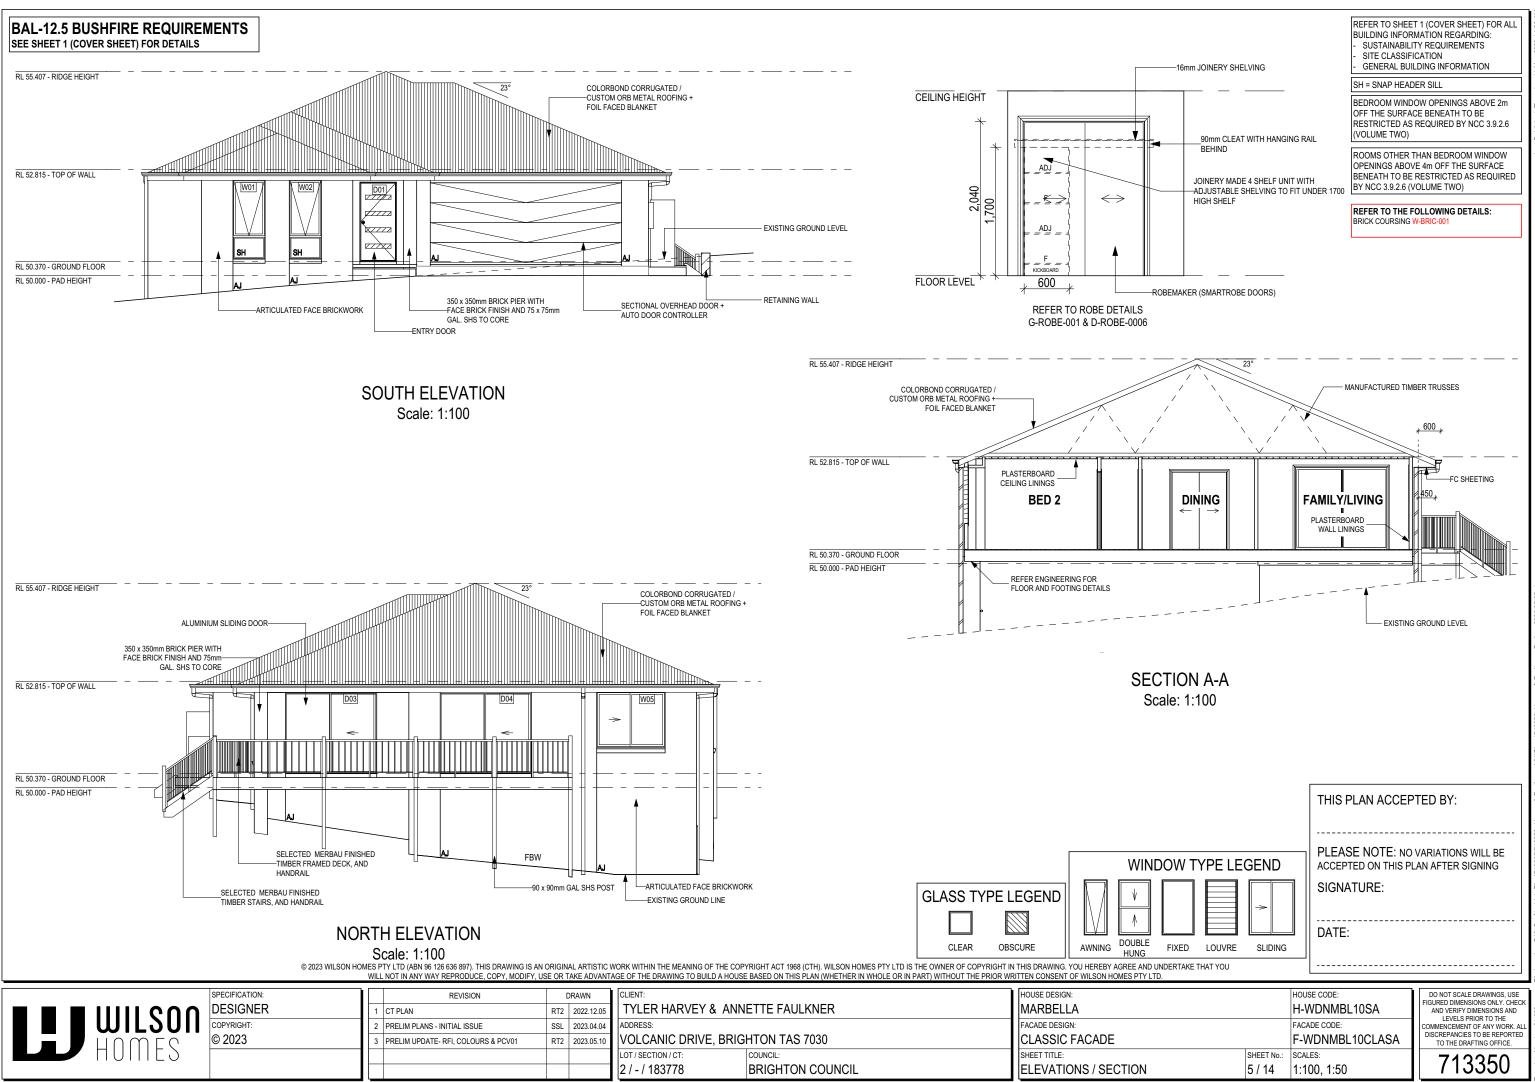nplate Version: 21.036



WINDOW SCHEDULE

^{0, 3} A	SSUME LOOKING FROM OUTSIDE	1, 2 ASSUME LOOKI	NG FROM INSIDE							
ID	CODEº	ROOM	HEIGHT	WIDTH	PERIMETER	AREA FRAME (m ²) TYPE	BAL RATING SILL TYPE	ORIENT.	GLAZING AREA (m²) GLAZING TYPE	ADDITIONAL INFORMATION ¹
W01	A/F2090x850	MASTER SUITE	2,090	850	5,880	1.78 ALUMINIUM	BAL-12.5 SNAP HEADER	S	1.40 CLEAR, DOUBLE GLAZED, TOUGHENED	BP 600
W02	2 A/F2090x850	MASTER SUITE	2,090	850	5,880	1.78 ALUMINIUM	BAL-12.5 SNAP HEADER	S	1.40 CLEAR, DOUBLE GLAZED, TOUGHENED	BP 600
W03	3 SF/F1809	FAMILY / LIVING	1,800	850	5,300	1.53 ALUMINIUM	BAL-12.5 ANGLED	E	1.24 CLEAR, DOUBLE GLAZED	BP 600
W04	SF/F1809	FAMILY / LIVING	1,800	850	5,300	1.53 ALUMINIUM	BAL-12.5 ANGLED	E	1.24 CLEAR, DOUBLE GLAZED	BP 600
WOS	5 SF1518	BED 3	1,460	1,810	6,540	2.64 ALUMINIUM	BAL-12.5 ANGLED	N	2.35 CLEAR, DOUBLE GLAZED	
WOG	6 A0906	WC	860	610	2,940	0.52 ALUMINIUM	BAL-12.5 ANGLED	W	0.35 OBSCURE, DOUBLE GLAZED, TOUGHENED	
W07	7 SF1216	BATH	1,200	1,570	5,540	1.88 ALUMINIUM	BAL-12.5 ANGLED	W	1.64 OBSCURE, DOUBLE GLAZED, TOUGHENED	
W08	3 SF1518	BED 2	1,460	1,810	6,540	2.64 ALUMINIUM	BAL-12.5 ANGLED	W	2.35 CLEAR, DOUBLE GLAZED	
WOS	9 SF1518	BED 4	1,460	1,810	6,540	2.64 ALUMINIUM	BAL-12.5 ANGLED	W	2.35 CLEAR, DOUBLE GLAZED	
W10) SF/F1812	STUDY	1,800	1,210	6,020	2.18 ALUMINIUM	BAL-12.5 ANGLED	W	1.83 CLEAR, DOUBLE GLAZED	BP 600
W11	I A1806	ENS	1,800	610	4,820	1.10 ALUMINIUM	BAL-12.5 ANGLED	W	0.81 OBSCURE, DOUBLE GLAZED, TOUGHENED	
						20.22			16.96	

NOTE Provide BAL - 12.5 rated aluminium windows and external glass sliding doors in lieu of standard.

Provide flyscreens with corrosion resistant mesh to all opening window sashes only

QTY TYPE

EXTERIOR DOOR SCHEDULE

0, 1 ASSUME LOOKING FROM C	OUTSIDE
----------------------------	---------

ID	CODEº	ROOM	HEIGHT	WIDTH	AREA FRAME (m ²) TYPE	BAL Rating	SILL TYPE	ORIENT.	GLAZING TYPE	DOOR TYPE	ADDITIONAL INFORMATION ¹
D01	920	ENTRY	2,106	967	2.04 TIMBER	BAL-12.5	SNAP HEADER	S	DOOR(S): OBSCURE - SIDELIGHT(S): N/A	SWINGING	LEAF SIZE: 2040 x 920mm
D02	FS2158x1470	LDRY	2,158	1,470	3.17 ALUMINIUM	BAL-12.5	SNAP HEADER	Е	CLEAR, DOUBLE GLAZED, TOUGHENED	SLIDING	
D03	FS2124	FAMILY / LIVING	2,158	2,410	5.20 ALUMINIUM	BAL-12.5	SNAP HEADER	Ν	CLEAR, DOUBLE GLAZED, TOUGHENED	SLIDING	
D04	FS2124	HOME THEATRE	2,158	2,410	5.20 ALUMINIUM	BAL-12.5	SNAP HEADER	Ν	CLEAR, DOUBLE GLAZED, TOUGHENED	SLIDING	
					15.01 3						

15.61 m²

INTERIOR DOOR SCHEDULE

QTY	CODE	TYPE	HEIGHT	WIDTH	GLAZING	ADDITIONAL INFORMATION
1	1100 SS	SQUARE SET OPENING	2,155	1,100	N/A	
1	2 x 520	SWINGING	2,040	1,040	N/A	
2	2 x 720	SMARTROBE SLIDING	2,040	1,460	N/A	
1	2 x 720 CSD	CAVITY SLIDING	2,040	1,440	N/A	SELECT
2	2 x 870	SWINGING	2,040	1,740	N/A	
1	3 x 620	SMARTROBE SLIDING	2,040	1,860	N/A	
1	720	SWINGING	2,040	720	N/A	LIFT-OFF HINGES
1	770	SWINGING	2,040	770	N/A	
6	820	SWINGING	2,040	820	N/A	
1	820 CSD	CAVITY SLIDING	2,040	820	N/A	
1	820 CSD	CAVITY SLIDING	2,040	820	N/A	SELECT
1	820 SS	SQUARE SET OPENING	2,155	820	N/A	
1	920 CSD	CAVITY SLIDING	2,040	920	N/A	

BAL-12.5 BUSHFIRE REQUIREMENTS SEE SHEET 1 (COVER SHEET) FOR DETAILS

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DESIGNER	1 CT PLAN	RT2 2022.12.0	TYLER HARVEY & ANN	NETTE FAULKNER	MARBELLA
COPYRIGHT:	2 PRELIM PLANS - INITIAL ISSUE	SSL 2023.04.0	ADDRESS:		FACADE DESIGN:
© 2023	3 PRELIM UPDATE- RFI, COLOURS & PCV01	RT2 2023.05.1	VOLCANIC DRIVE, BRIG	GHTON TAS 7030	CLASSIC FACADE
			LOT / SECTION / CT:	COUNCIL:	SHEET TITLE:
			2 / - / 183778	BRIGHTON COUNCIL	WINDOW & DOOR SCHEDULES

PICTURE / TV RECESS & SQUARE SET WINDOW SCHEDULE

HEIGHT WIDTH AREA (m²)

Manufacturer - Clark Windows			
Window Type	Glazing	U-Value	SHGC
Awning	Single	6.5	0.67
	Double	4.1	0.57
Fixed	Single	5.9	0.75
	Double	3.2	0.67
Sliding	Single	6.4	0.76
	Double	4.2	0.59
Fixed Pane	Single	5.9	0.75
	Double	3.2	0.67
Fixed Glass Panel Hinged Door	Single	6.0	0.62
	Double	4.3	0.55
Sliding Door	Single	6.1	0.74
	Double	3.6	0.66
Stacking Door	Single	6.3	0.74
	Double	3.8	0.66
135 deg. Awning Bay Window	Single	6.5	0.67
	Double	4.1	0.57
135 deg. Sliding Bay Window	Single	6.5	0.76
	Double	4.2	0.59
90 deg. Awning Bay Window	Single	6.5	0.67
	Double	4.1	0.57
90 deg. Sliding Bay Window	Single	6.5	0.76
	Double	4.2	0.59
Bifold Doors	Single	6.1	0.61
	Double	4.4	0.53
NOTE:			

NOTE: Windows supplied MUST HAVE Uw better and or equal to stated figures and SHGC within +/- 5% of stated figures. Restricted windows to have their openability restricted as per N.C.C 3.9.2.5.

SINGLE GLAZING UNO. REFER TO GENERAL NOTES FOR FURTHER DETAIL AND REQUIREMENTS.

REFER TO SHEET 1 (COVER SHEET) FOR ALL BUILDING INFORMATION REGARDING: SUSTAINABILITY REQUIREMENTS - SITE CLASSIFICATION - GENERAL BUILDING INFORMATION


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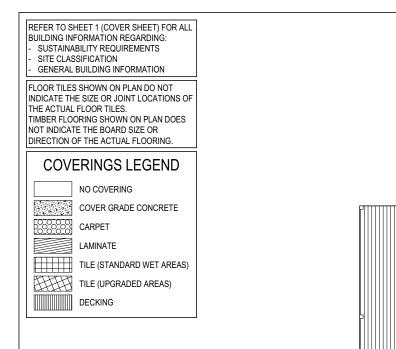
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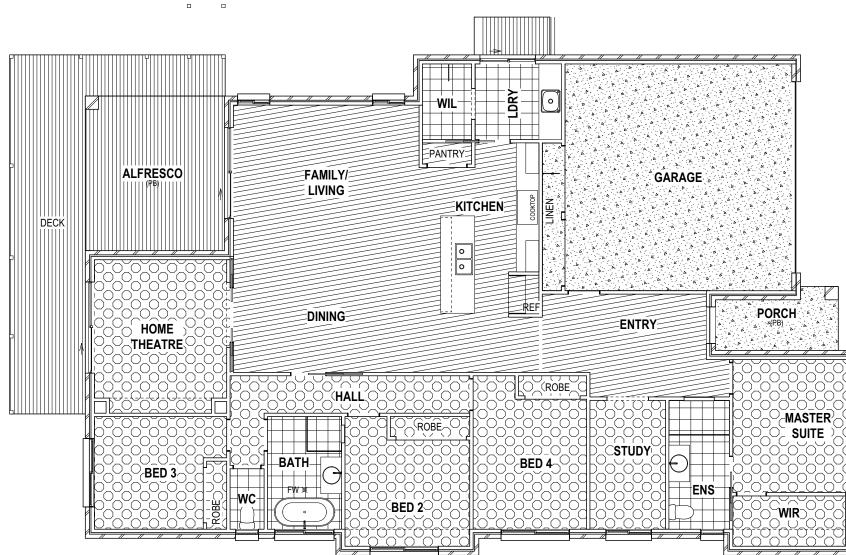
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S	SHEET No.: 7 / 14	SCALES:	713350	Femplate V



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				COUNCIL:	SHEET TITLE:
			2 / - / 183778	BRIGHTON COUNCIL	ROOF DRAINAGE



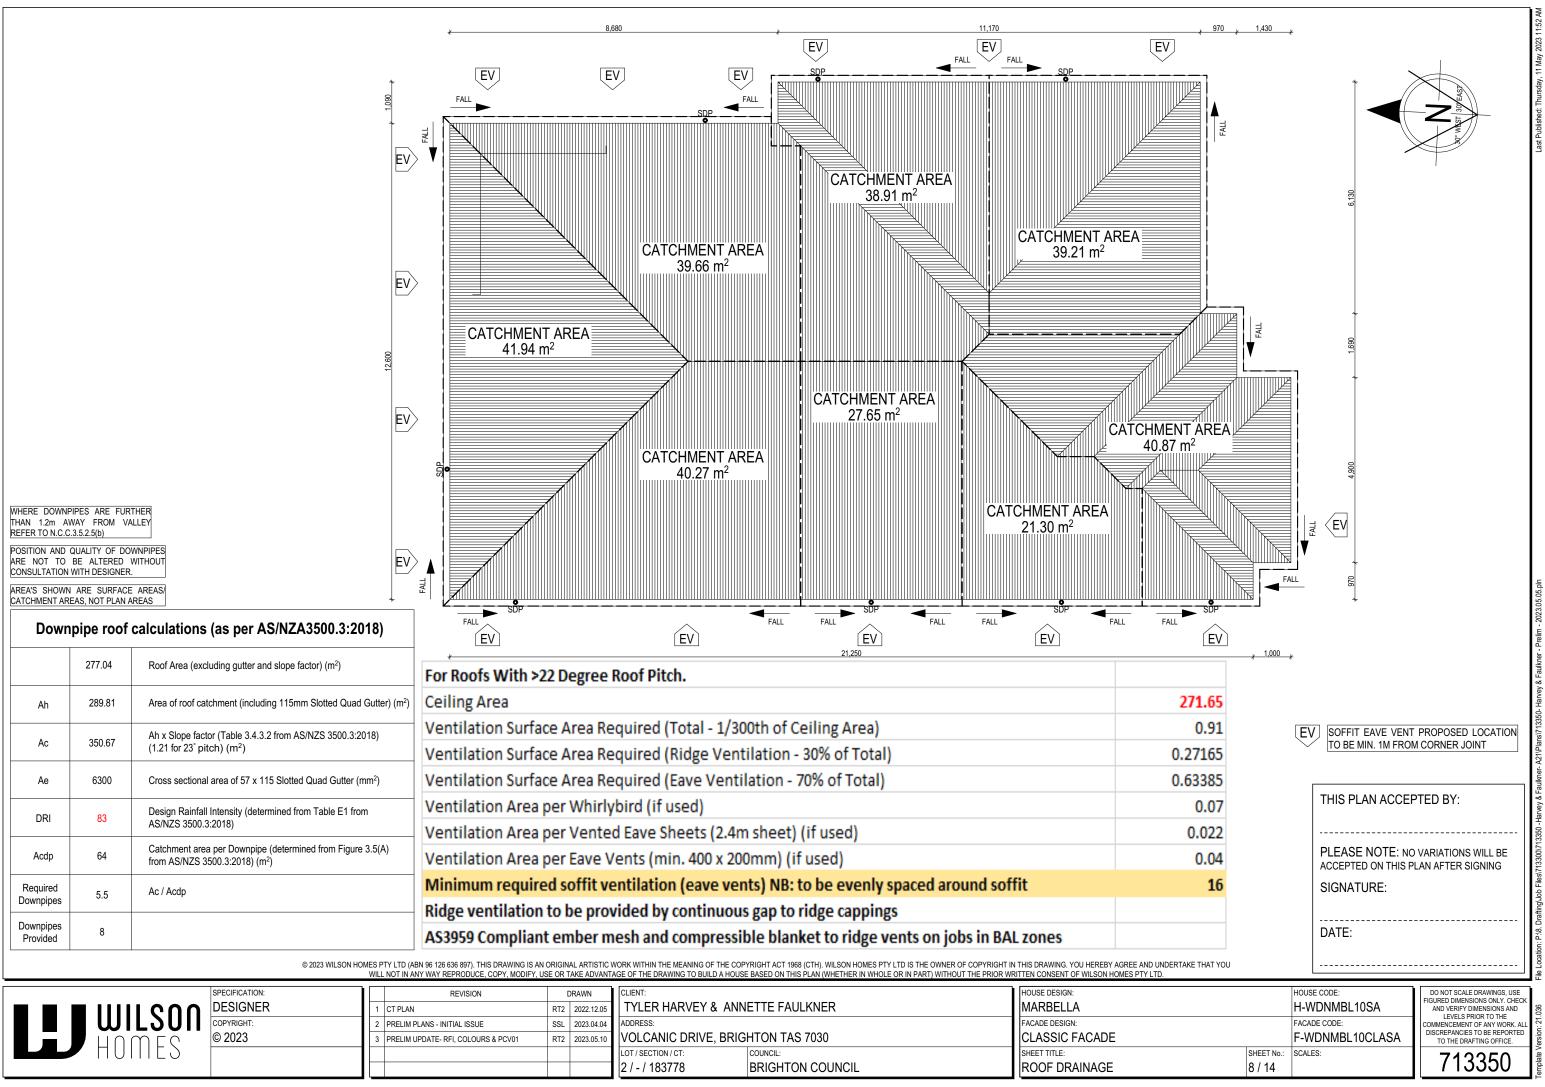

FLOOR COVERINGS Scale: 1:100

BAL-12.5 BUSHFIRE REQUIREMENTS SEE SHEET 1 (COVER SHEET) FOR DETAILS

WILSON Homes

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			2 / - / 183778 BRIGHTON COUNCIL	FLOOR COVERINGS	9 / 14		713350


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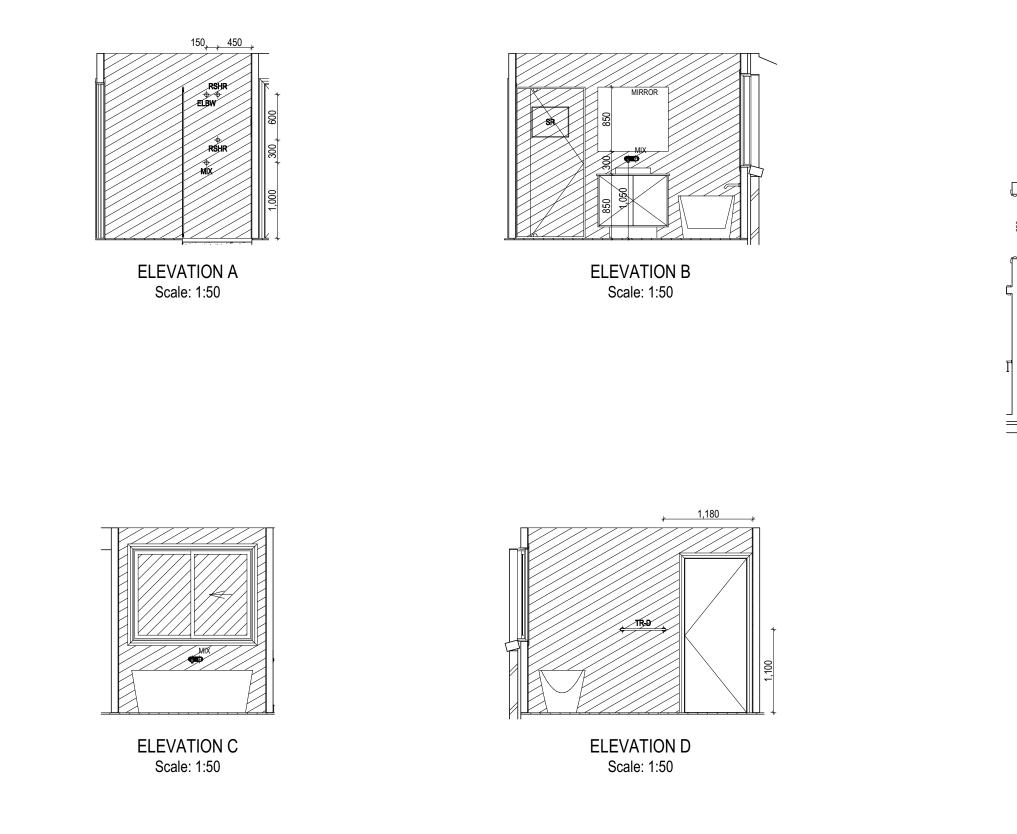
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DETAILS DEPICTED ON THIS SHEET ARE A REPRESENTATION ONLY. JOINER MAY ADJUST CABINETRY AS REQUIRED.
GAS CONNECTION FOR COOKTOP TO BE LOCATED 700mm TO RIGHT HAND SIDE OF CENTRE OF COOKTOP

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SHEET NO.: 10 / 14	scales: 1:50	713350	Template V


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	2 1				ADDRESS:		FACADE DESIGN:	
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						LOT / SECTION / CT:	COUNCIL:	SHEET TITLE:
						2 / - / 183778	BRIGHTON COUNCIL	BATHROOM DETAILS

WINDOW OVER BATH HOB D-WIND-ALU001 STANDARD BATH HOB D-WIND-ALU001 STANDARD BATH HOB D-WETA-BATH003 WET AREA TILING LAYOUTS D-WETA-TILE002 SQUARE SET WINDOWS G-WIND-SSET02 FULL HEIGHT TILING D-LINI-WETA

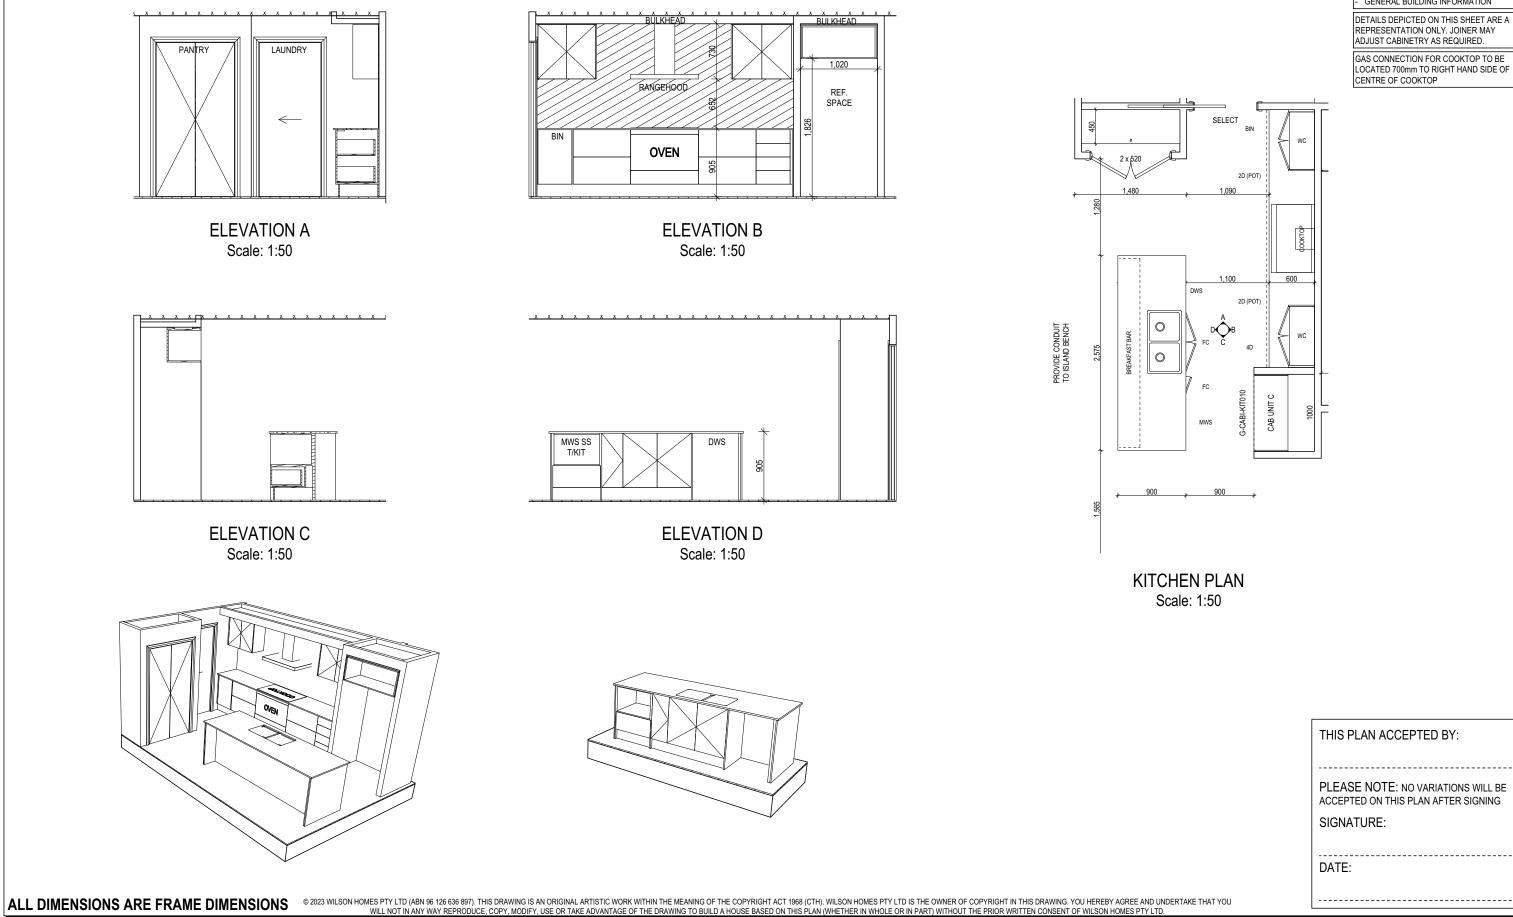

DOB FWັ⊠

 \rightarrow

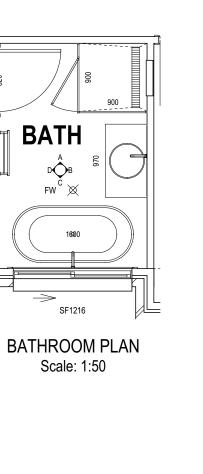1600

LEGEND RSHR RAIL SHOWER

	ZE STRUCTURAL DIMENSIONS					
		SR	SHAMPOO RECESS			
	-		SHELF			
		RH	ROBE HOOK			
		RNG				
		MB	TUMBLER HOLDER			
		TR	TOWEL RACK			
		тн	TOWEL LADDER			
		TI	TOWEL LADDER			
	TR-D					
	Т	R-S	TOWEL RAIL - SINGLE			
	Т	TRH	TOILET ROLL HOLDER			
		SC	STOP COCK			
	١	WS	WALL SPOUT			
		HS	HOB SPOUT			
		СТ	COLD TAP			
		HT	HOT TAP			
MIX		MIX	CONNECTION MIXER TAP			
	E	LBW	SHOWER ELBOW			
	R	OSE	SHOWER ROSE			

SHAMPOO	RECESS SIZE	STRUCTURAL DIMENSIONS					
"Small" "Medium" "Large"	470 x 380mm 800 x 380mm 1500 x 380mm	548mm 878mm	HEIGHT 446mm 446mm 446mm				
REFER WILSON HOMES' DETAIL G-WETA-TILE01 FOR FURTHER DETAIL PRIOR TO INSTALLATION.							


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	Πυιιες							LOT / SECTION / CT:	COUNCIL:	SHEET TITLE:
								2 / - / 183778	BRIGHTON COUNCIL	WC DETAILS

- GENERAL BUILDING INFORMATION
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WINDOW OVER BATH HOB D-WIND-ALU001 STANDARD BATH HOB D-WIND-ALU001 STANDARD BATH HOB D-WETA-BATH003 WET AREA TILING LAYOUTS D-WETA-TILE002 SQUARE SET WINDOWS G-WIND-SSET02 FULL HEIGHT TILING D-LINI-WETA

RSHR



WC PLAN Scale: 1:50

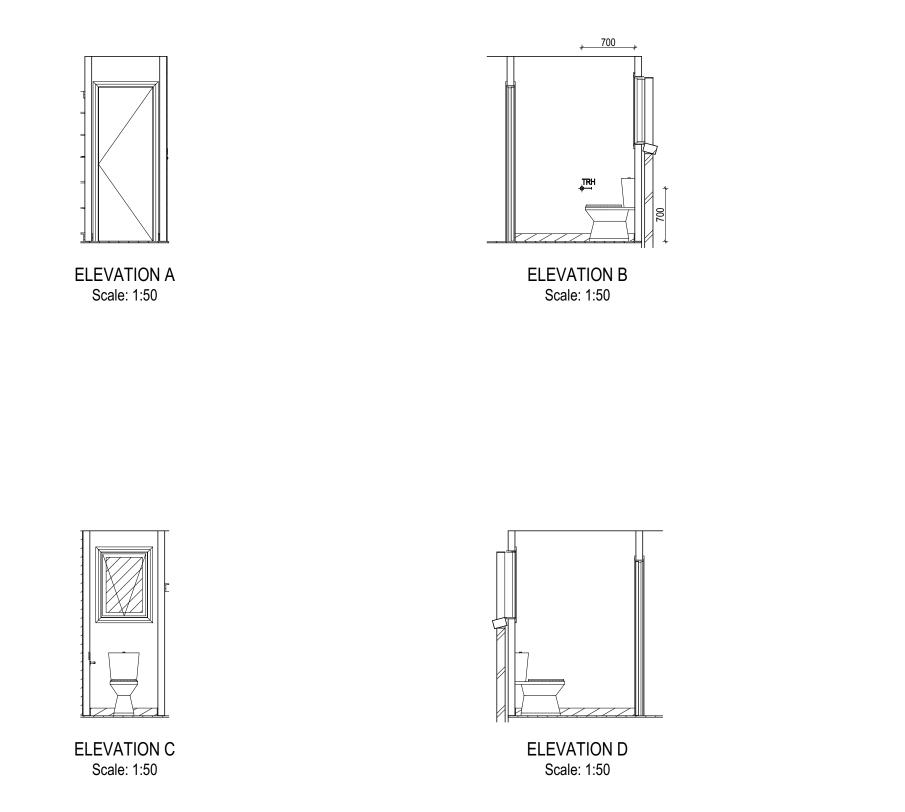A0906

LEGEND
RAIL SHOWER
SHOWER ROSE
SHOWER ELBOV

ROSE	SHOWER ROSE
ELBW	SHOWER ELBOW CONNECTION
MIX	MIXER TAP
ΗT	HOT TAP
СТ	COLD TAP
HS	HOB SPOUT
WS	WALL SPOUT
SC	STOP COCK
TRH	TOILET ROLL HOLDER
TR-S	TOWEL RAIL - SINGLE
TR-D	TOWEL RAIL - DOUBLE
TL	TOWEL LADDER
TH	TOWEL HOLDER
TR	TOWEL RACK
TMB	TUMBLER HOLDER
RNG	TOWEL RING
RH	ROBE HOOK
SHLF	SHELF
SR	SHAMPOO RECESS
SOAP	SOAP HOLDER

SHAMPOO	RECESS SIZE	STRUCTURAL DIMENSIONS				
"Small" "Medium" "Large"	470 x 380mm 800 x 380mm 1500 x 380mm	WIDTH 548mm 878mm 1578mm	HEIGHT 446mm 446mm 446mm			
REFER WILSON HOMES' DETAIL G-WETA-TILE01 FOR FURTHER DETAIL PRIOR TO INSTALLATION.						


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SHEET No.: SCALES:	
12 / 14 1:50	713350




Scale: 1:50

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DESIGNER COPYRIGHT: © 2023	DESIGNER	1 CT PLAN	RT2 2022.12.05	TYLER HARVEY & ANN	IETTE FAULKNER	MARBELLA
		2 PRELIM PLANS - INITIAL ISSUE	SSL 2023.04.04			FACADE DESIGN:
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				LOT / SECTION / CT:	COUNCIL:	SHEET TITLE:
				2 / - / 183778	BRIGHTON COUNCIL	ENSUITE DETAILS

REFER TO SHEET 1 (COVER SHEET) FOR ALL BUILDING INFORMATION REGARDING: SUSTAINABILITY REQUIREMENTS SITE CLASSIFICATION GENERAL BUILDING INFORMATION DETAILS DEPICTED ON THIS SHEET ARE A REPRESENTATION ONLY

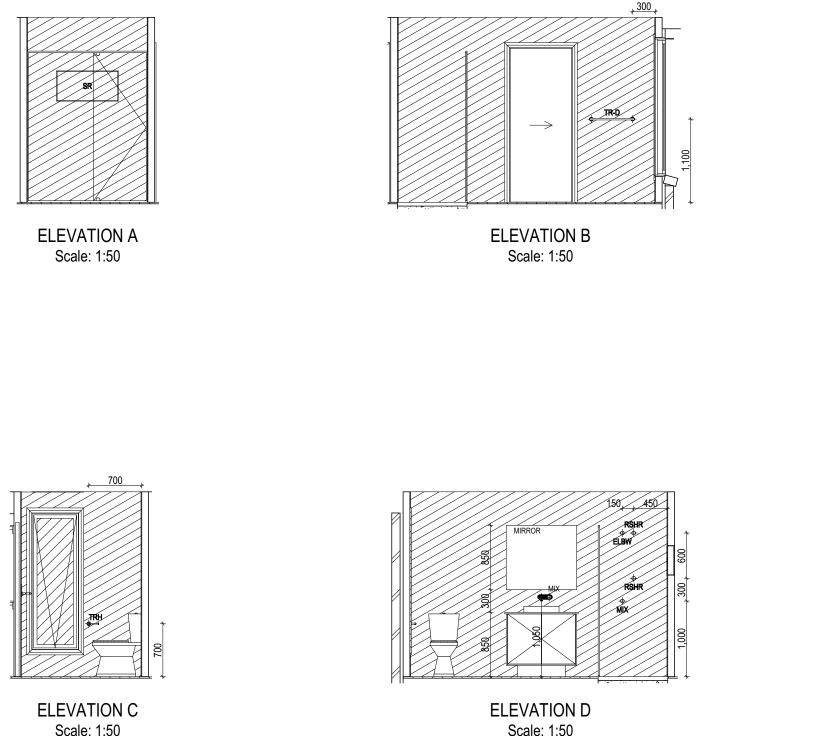REFER TO THE FOLLOWING DETAILS: WINDOW OVER BATH HOB D-WIND-ALU00 WINDOW OVER BATH HOB D-WETA-BATHO03 STANDARD BATH HOB D-WETA-BATHO03 WET AREA TILING LAYOUTS D-WETA-TILE002 SQUARE SET WINDOWS G-WIND-SSET02 FULL HEIGHT TILING D-LINI-WETA

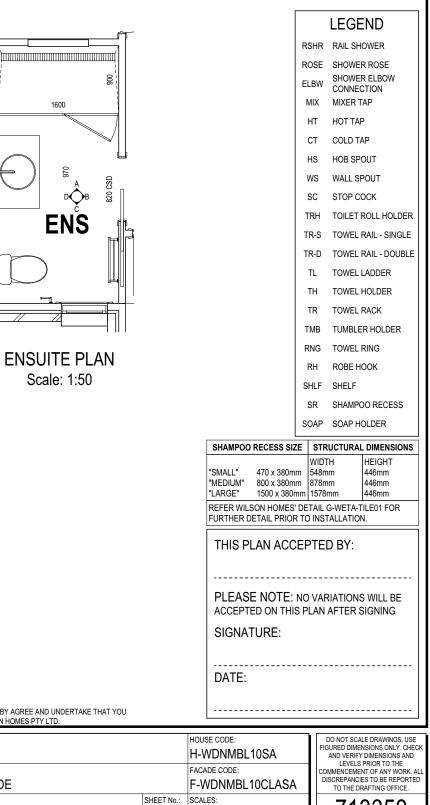

13/14 1:50

1600


713350



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	COPYRIGHT: © 2023	2 PRELI	IM PLANS - INITIAL ISSUE	SSL	2023.04.04			FACADE DESIGN:
		3 PRELI	IM UPDATE- RFI, COLOURS & PCV01	RT2	2023.05.10	VOLCANIC DRIVE, BRIGHTON TAS 7030		CLASSIC FACADE
HUIIIES						LOT / SECTION / CT:	COUNCIL:	SHEET TITLE:
						2 / - / 183778	BRIGHTON COUNCIL	LAUNDRY DETAILS

REFER TO SHEET 1 (COVER SHEET) FOR ALL BUILDING INFORMATION REGARDING: SUSTAINABILITY REQUIREMENTS SITE CLASSIFICATION GENERAL BUILDING INFORMATION

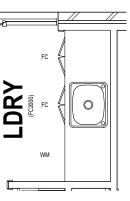

LAUNDRY PLAN Scale: 1:50

820 CSD

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	FACADE CODE: F-WDNMBL10CLASA	COMMENCEMENT OF ANY WORK. ALL DISCREPANCIES TO BE REPORTED TO THE DRAFTING OFFICE.
SHEET No.: 14 / 14	scales: 1:50	713350