

Land Use Planning and Approvals Act 1993

APPLICATION NO.

DA2022/262

LOCATION OF AFFECTED AREA

2 FLORENCE COURT, PONTVILLE

DESCRIPTION OF DEVELOPMENT PROPOSAL


DWELLING

A COPY OF THE DEVELOPMENT APPLICATION MAY BE VIEWED AT www.brighton.tas.gov.au AND AT THE COUNCIL OFFICES, 1 TIVOLI ROAD, OLD BEACH, BETWEEN 8:15 A.M. AND 4:45 P.M., MONDAY TO FRIDAY OR VIA THE OR CODE BFI OW. ANY PFRSON MAY MAKE WRITTEN REPRESENTATIONS CONCERNING AN APPLICATION UNTIL 4:45 P.M. ON 11/1/2023. ADDRESSED TO THE GENERAL MANAGER AT 1 TIVOLI ROAD, OLD BEACH, 7017 OR BY EMAIL development@brighton.tas.gov.au. REPRESENTATIONS SHOULD INCLUDE A DAYTIME TELEPHONE NUMBER TO ALLOW COUNCIL OFFICERS TO DISCUSS, IF NECESSARY, ANY MATTERS RAISED.

JAMES DRYBURGH General Manager






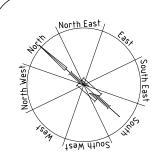

CONTENTS

- 1 Site Plan
- 2 Preliminary Plan
- 3 Preliminary Elevations
- 4 Shed Plan
 5 Shed Elevations
- 6 Stormwater Plan 7 Plumbing Notes

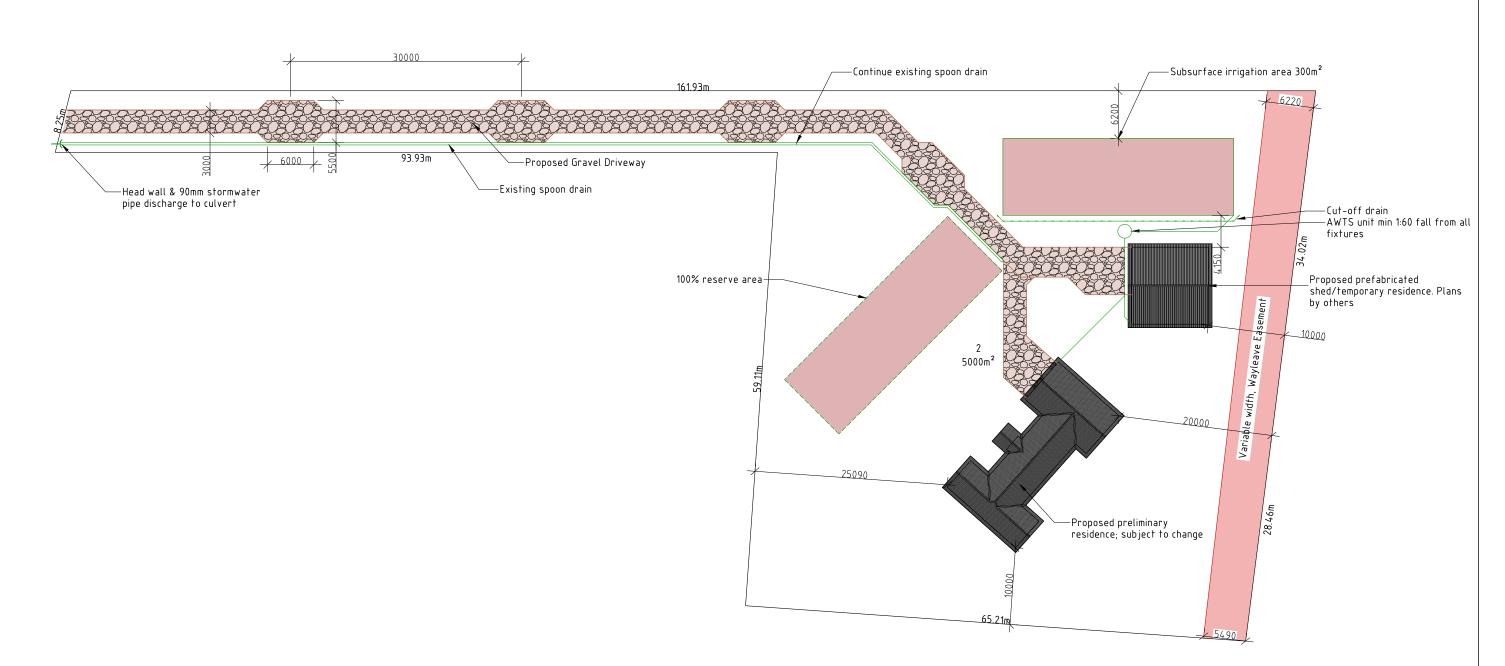

NOTE: PLANS TO BE READ IN CONJUNCTION WITH SHED PLANS BY FAIRDINKUM SHEDS


NOTE: SEE WASTE WATER REPORT BY GES PTY LTD FOR SUB SURFACE IRRIGATION AREAS AND LOCATIONS


DEVELOPMENT DRAWINGS ONLY NOT FOR CONSTRUCTION


PROPOSED SHED/TEMPORARY DWELLING FOR
BRODIE LANE AT
2 FLORENCE COURT, PONTVILLE


SITE PLAN		DATE 02/12/22	DRAWN BY G Tilley email: qltilley7@biqpond.com phone ph 0400 671 582	
SCALE	1:500	AMENDED	DRAWING NO. OI OF O7	Accreditation No.CC62OH Copuright 2022 3922




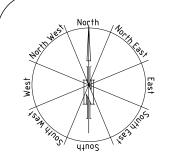


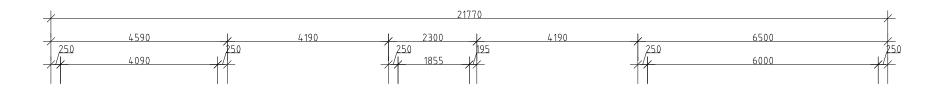

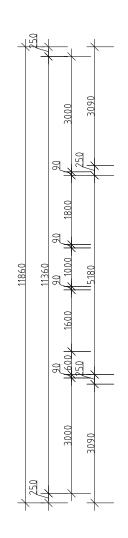

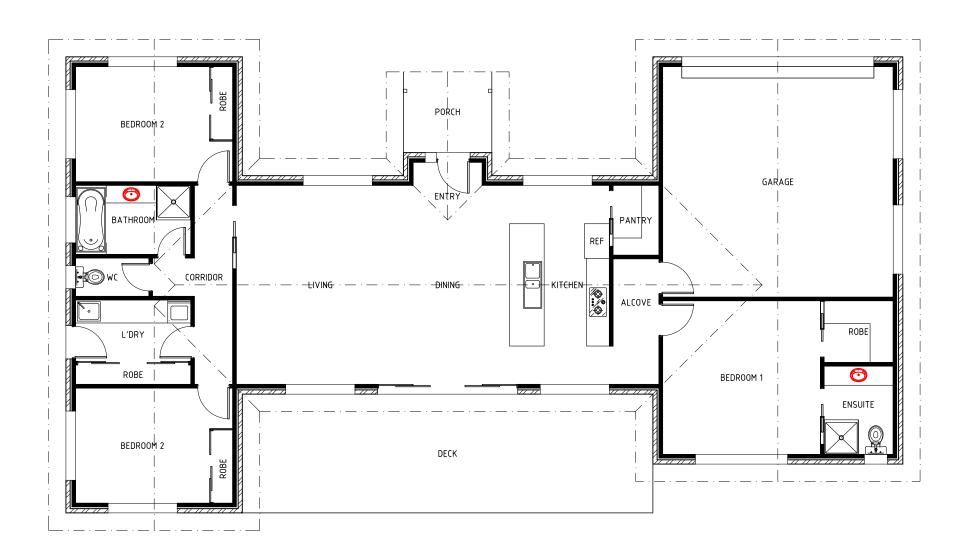

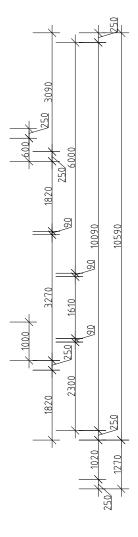

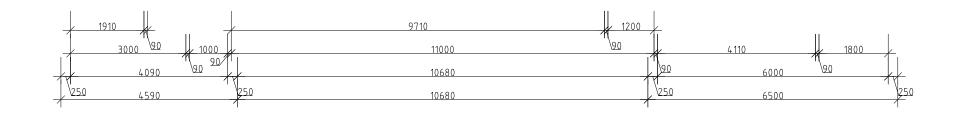

AREA Residence: 185.31m² Deck: 33.00m² Porch: 4.83m²

DEVELOPMENT DRAWINGS ONLY NOT FOR CONSTRUCTION

PRELIMINARY PLANS OF RESIDENCE ONLY; SUBJECT TO CHANGE


PROPOSED SHED / TEMPORARY DWELLING FOR
BRODIE LANE AT
2 FLORENCE COLIRT, PONTVILLE

PLAN







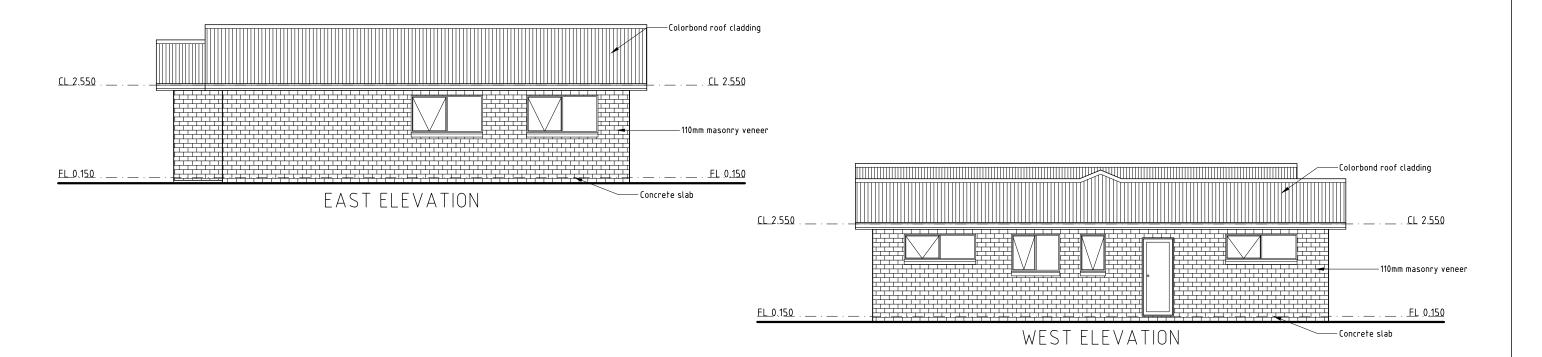


DEVELOPMENT DRAWINGS ONLY NOT FOR CONSTRUCTION


PRELIMINARY PLANS OF RESIDENCE ONLY; SUBJECT TO CHANGE


PROPOSED SHED / TEMPORARY DWELLING	FOR
BRODIE LANE AT	
2 FLORENCE COURT, PONTVILLE	


ELEVATIONS		DATE 02/12/22	DRAWN BY A Tilley email: qltilley7@biapond.com phone ph 0400 671 582	
SCALE 1:100	AMENDED	DRAWING NO. 03 OF 07	Accreditation No.CC62OH copyright 2022 3922	



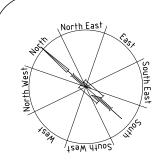

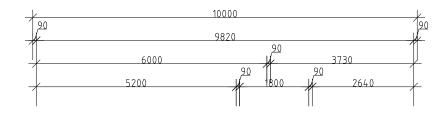

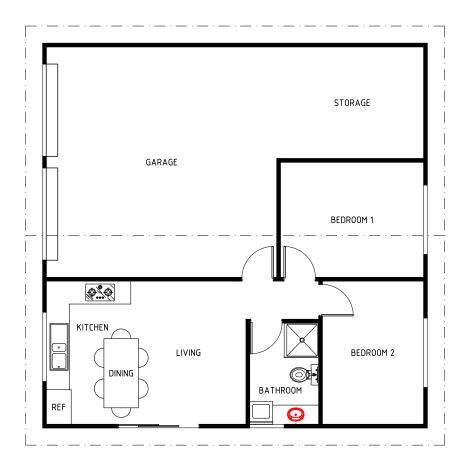

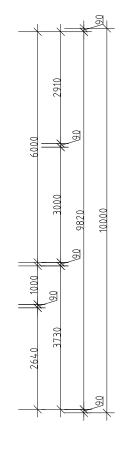

AREA

Non-habitable: Ancillary: Total:

48.82m² 51.18m² 100m²


NOTE: PLANS TO BE READ IN CONJUNCTION WITH SHED PLANS BY FAIRDINKUM SHEDS


DEVELOPMENT DRAWINGS ONLY NOT FOR CONSTRUCTION


PROPOSED SHED/TEMPORARY DWELLING FOR
BRODIE LANE AT
2 FLORENCE COURT, PONTVILLE


PLAN		DATE 02/12/22	DRAWN BY G Tilley email: qltilley7@blapond.com phone ph 0400 671 582
5CALE 1:100	AMENDED	DRAWING NO. 04 OF 07	Accreditation No.CC62OH C) copyright 2022 3922



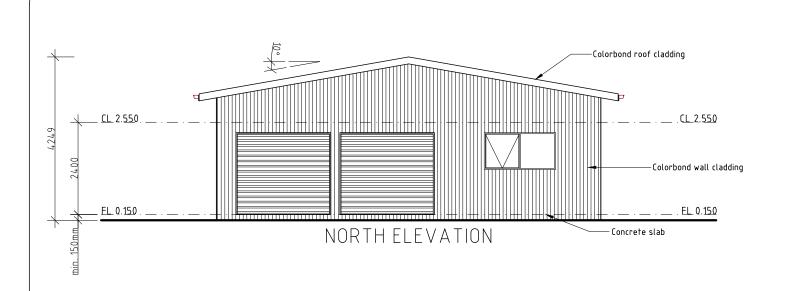

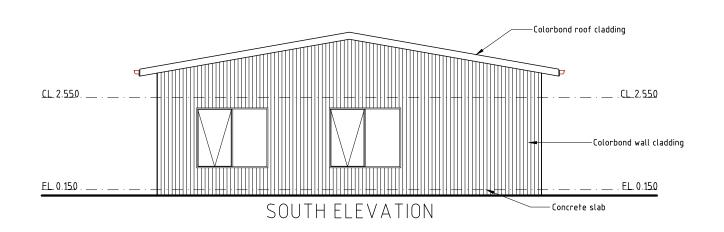

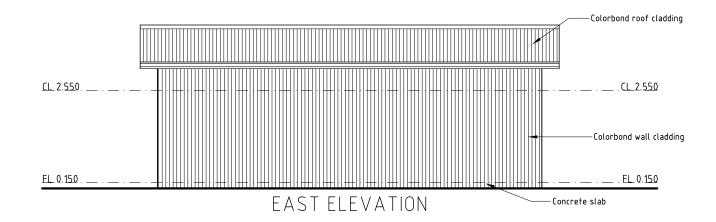

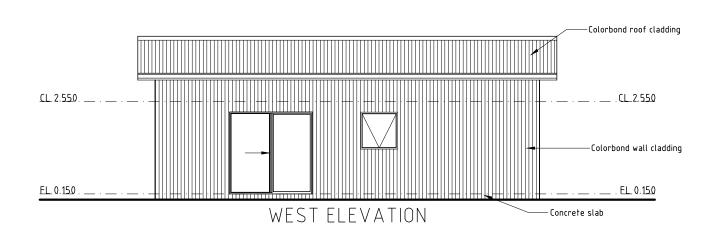



DEVELOPMENT DRAWINGS ONLY NOT FOR CONSTRUCTION

PROPOSED SHED/TEMPORARY DWELLING FOR BRODIE LANE AT 2 FLORENCE COURT, PONTVILLE


ELEVATIONS	
SCALE 1:100	AMENDED

DRAWN BY G Tilley DATE email: altilley7@biapond.com phone ph 0400671582 02/12/22

DRAWING NO. 05 OF 07

Accreditation No.CC620H

(C) copyright 2022 3922

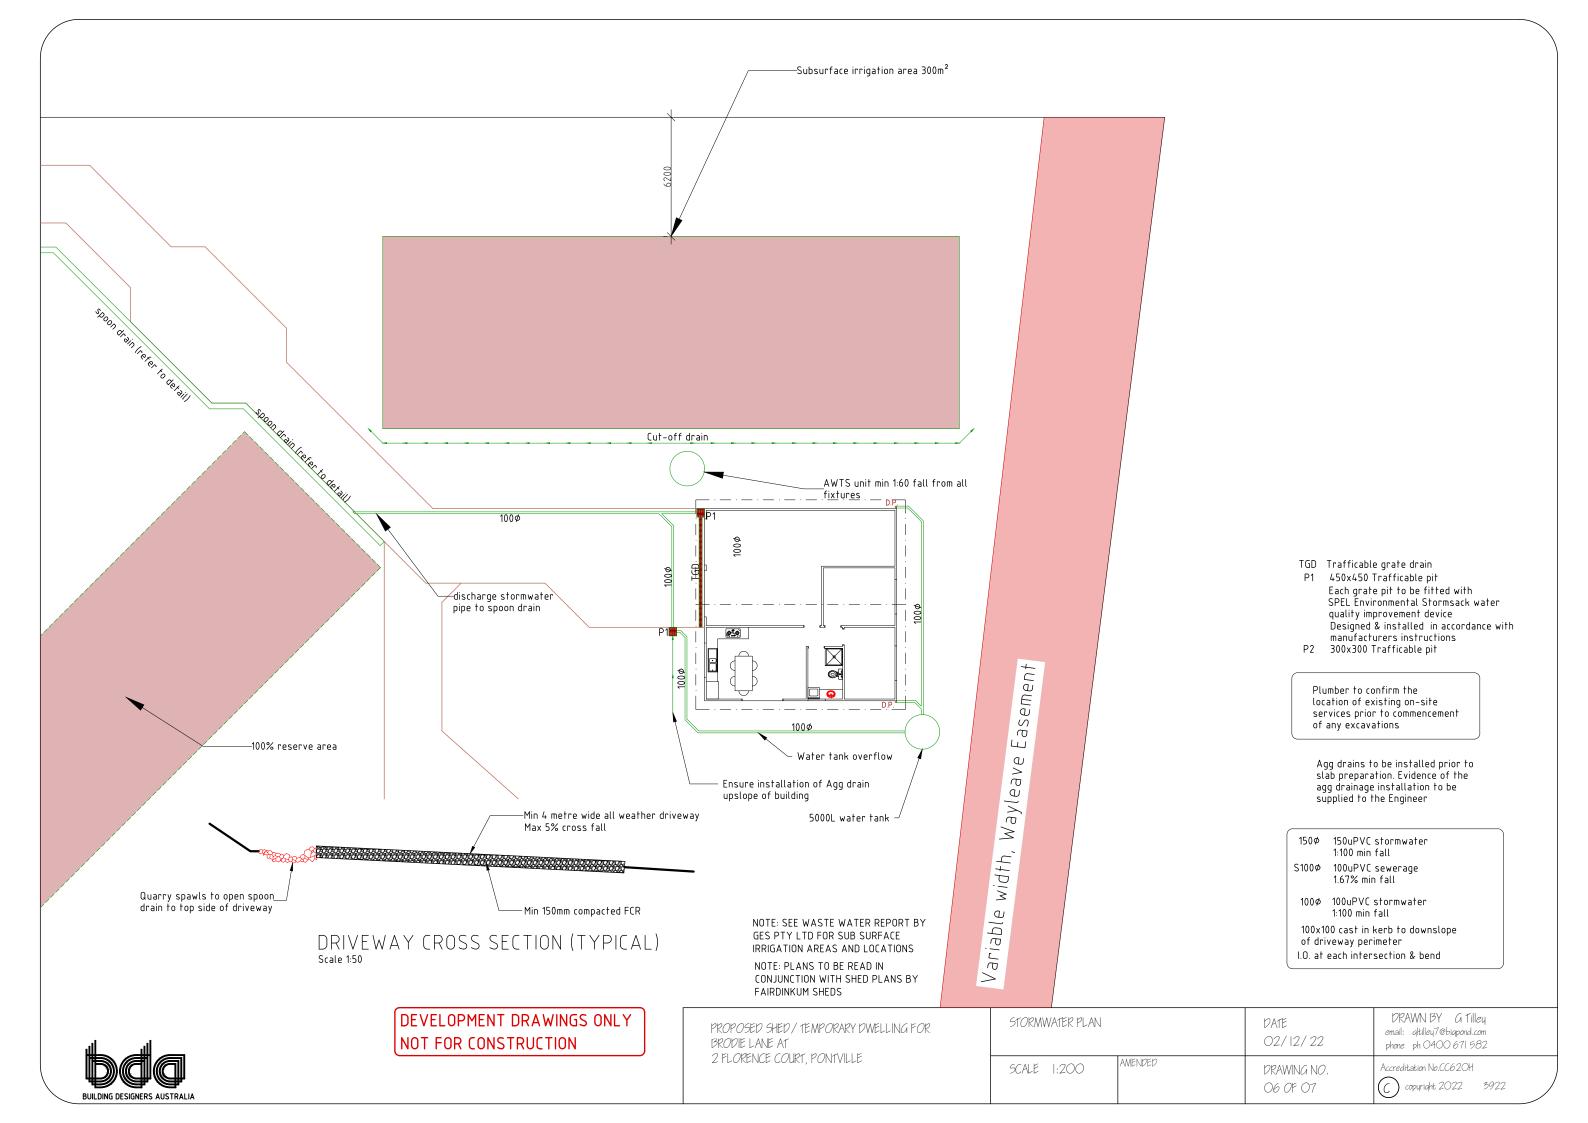

... 1166 2 0 4 0 1 4 6 2 7 4 0

VESSELS OR AREA WHERE THE FIXTURE IS INSTALLED	FLOORS AND HORIZONTAL SURFACES	WALLS	WALL JUNCTIONS AND JOINTS	WALL/FLOOR JUNCTIONS	PENETRATIONS
Shower areas (Ensuite & Bathro	om)				
Without hob or step-down	Waterproof floor in shower area. Membrane 'M01' Ceramic floor tiles.	Waterproof walls in shower area to min. 150mm above the floor substrate. Membrane 'M01' Water resistant walls in shower area to min. 1800mm above FFL of the shower. Ceramic tiles	within shower aréa. Membrane 'M01'	Waterproof wall/floor junctions within shower area Membrane 'M01'	'M01' Waterproof tap & spout penetrations with 'Waterbar'
With preformed shower base	N/A	Water resistant walls in shower area to min. 1800mm above FFL of the shower. Ceramic tiles.	Waterproof wall junctions within shower area. Membrane 'M01'	Waterproof wall/floor junctions within shower area. Membrane 'M01'	
Area outside shower area (Ensu			•	•	
For concrete and compressed fibre-cement sheet flooring	Min. water resistant floor of the room. Membrane 'M01' to entire floor of room. Ceramic floor tiles.		N/A	Waterproof wall/floor junctions Membrane 'M02'	N/A
Areas adjacent to baths and sp					
For concrete and compressed fibre-cement sheet flooring & Inserted baths & spas	Min. water resistant floor of the room. Membrane 'M01' to entire floor of room. Waterproof shelf area with waterstop under the bath lip. Membrane 'M01' Ceramic tiles.	(a) Min. 150mm high ceramic tile splashback to bath perimeter (b) Ceramic tile upstand from floor level to underside of bath lip.	Water resistant junctions within 150mm above bath with white silicone (3xwalls).	Water resistant ceramic tile upstand to extent of bath.	Waterproof tap and spout penetrations in horizontal surface with 'Waterbar' tap penetration flange & silicone.
Other areas					
Laundries and WC	Water resistant floor of the room. Ceramic floor tiles	N/A	N/A	Water resistant wall/floor junctions. Membrane 'M02' & ceramic tile skirting.	N/A
Walls adjoining sink, basin, or laundry tub	N/A	extent of the vessel, where the	Waterproof wall junctions where a vessel is fixed to a wall with silicone	N/A	Waterproof tap & spout penetrations if within splashback with 'Waterbar' tap penetration flange & silicone,

1800H Semi-frameless shower screens to comply with BCA Table 3.6.5. & AS1288. Minimum 4mm thick Grade A toughened safety glass, labelled to comply with industry standards.

WATERPROOFING OF UNENCLOSED SHOWERS FLOOR: Waterproof entire floor

WALLS: Waterproof to not less than 150mm above the shower floor substrate or not less than 25mm above the maximum retained water level with the remainder being water resistant to a height of not less than 1800mm above the finished floor level.

WALL JUNCTIONS AND JOINTS: Waterproof internal and external corners and horizontal joints within a height of 1800mm above the floor level with not less than 40mm width either side of the junction PENETRATIONS: Waterproof all penetrations

AREAS OUTSIDE THE SHOWER ON CONCRETE SLAB:

FLOORS:Water risistant to entire floor WALL JUNCTIONS AND JOINTS; Waterproof all wall/floor junctions Where a flashing is used the horizontal leg must be not less than 40mm

AREAS OUTSIDE THE SHOWER ON TIMBER FLOOR;

FLOORS: Waterproof entire floor

WALL JUNCTIONS AND JOINTS; Waterproof all wall/floor junctions Where a flashing is used the horizontal leg must be not less than 40mm WATERPROOFING

Enclosed shower with preformed shower base Walls to be water resistant to a height of not less than 1800mm above finished floor level Waterproof internal & external corners and horizontal joints within a height of 180mm above the floor level with not less than 40mm width either side of the junctions

Waterproof all penetrations

HYDRAULIC NOTES:

- 1 All plumbing shall be in accordance with the Tasmanian plumbing regulations, AS3500 and to the local authority approval.

 2 The location of the existing services where shown are approximate only and shall be confirmed on site where possible. Determine location of existing power, Telstra, water and drainage
- services prior to commencing new work.

 3 Conceal all pipework in ceiling space, ducts, cavities, wall
- chases, cupboards etc unless otherwise approved.
 4 Refer to designers drawings and fixture and equipment
- technical specifications for pipework connections.

 Make good all disturbed surfaces to match existing
- 6 Remove all excess soil and surplus materials from site.
 7 All plumbing to be installed by a licenced Plumber.

Surface drainage to conform with BCA Vol2 Part 3.1.2.2. NOTE: 50mm fall required over the first 1 meter from the building

Install inspection openings at major bends for stormwater and all low points of downpipes. All plumbing & drainage to be in accordance with local Council requirements. levelled pad prior to commencing footing excavation. Stormwater line (100mm UPVC) Sewer line (100mm UPVC)

The heated water system must be designed and installed with Part B2 of NCC Volume Three -Plumbing Code of Australia.

sunlight; and

b) be able to withstand the temperatures within the piping: and

c) use thermal insulation in accordance with AS/NZS 4859.1

Heated water piping that is not within a conditioned space must be thermally insulated as follows:

1. Internal piping a) All flow and return internal piping that is -

ii) within an internal floor between storeys or

Must have a minimum R-Value of 0.2 (ie 9mm of closed cell

2. Piping located within a ventilated wall space,

cell polymer insulation)

3. Piping located outside the building or in an

a) All flow and return piping

heating system

Piping within an insulated timber framed wall, such as that passing through a wall stud, is considered to

Provide surface drain to back of bulk excavation to drain

Services

Membrane 'MO2' = Duntop (or similar) approved water based acrylic polyurethane membrane applied by either brush or roller in a consistent thickness to manufacturers recommendations

Thermal insulation for heated water piping must: a) be protected against the effects of weather and

i) within an unventilated wall space

iii) between ceiling insulation and a ceiling

polymer insulation)

an enclosed building subfloor or a roof space a) All flow and return piping

b) Cold water supply piping and Relief valve pipingwithin 500mm of the connection to central water heating system

Must have a minimum R-Value of 0.45 (ie 19mm of closed

unenclosed building sub-floor or roof space

b) Cold water supply piping and Relief valve pipingwithin 500mm of the connection to central water

Must have a minimum R-Value of 0.6 (ie 25mm of closed cell polymer insulation)

comply with the above insulation requirements

TYPICAL AGG DRAIN DETAIL NOTE: All materials and construction

Approx 300mm topsoil-

Geofabric or filter cloth

20mm aggregate approx 300mm deep-

Pervious backfill Approved filter material 14mm Nom Clean metal 100¢ nom subsoil drain-Geofabric wrap-


TRENCH WIDTHS			
Pipe diameter	Min trench width		
Less than 50mm	250		
75-100mm	450		
150-300mm	600		
>300mm	Ø plus 300mm		

to comply with AS3500.3.2003

Hot & Cold water nominal diamters Branch off takes Min DN20 Max off take length 6m **DN18** Max off take length 3m DN15 Max off take length 1m DN10


Insulation Schedule		
Heated water pipes		
Type	Size Range	Insulation
Circulating Line	32-40	25mm Rockwool with foil wrap
Branch Line	20-25	19mm Bradflex
Offtake	18	13mm Bradflex
Cold water pipes exposed		
Type	Size Range	Insulation
All	>20	13mm Bradflex
Other cold watere pipes		
Туре	Size Range	Insulation
All	All	Not required

NOTE: Water pipes associated directly with plant equipment shall be insulated in accordance with the manufacturers instructions for a typical installation

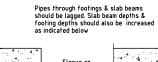


-100uPVC slotted pipe

ABSORPTION TRENCH (TYPICAL)

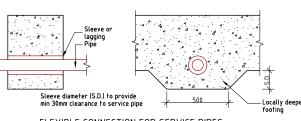


FLEXIBLE CONNECTION FOR SERVICE PIPES PASSING THROUGH FOOTINGS

-Compacted ordinary backfill

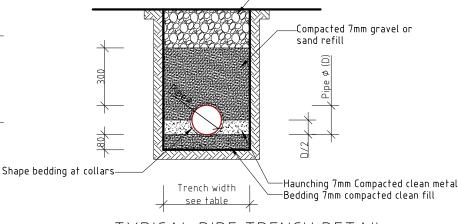

TYPICAL PIPE TRENCH DETAIL NON-TRAFFICABLE AREAS

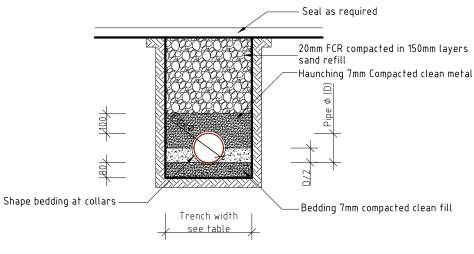

TYPICAL PIPE TRENCH DETAIL TRAFFICABLE AREAS

> IMPORTANT NOTICE FOR ATTENTION OF OWNER. The owner's attention is drawn to the fact that foundations and associated drainage in all sites requires continuing maintenance to assist footing performance. Advice for foundation maintenance is contained in the CSIRO Building Technology File 18 and it is the owner's responsibility to maintain the site in accordance with tha document.

> > DRAWN BY G Tilley

email: qltilley7@biqpond.com

phone ph 0400 671 582

copyright 2022 3922


Accreditation No.CC620H


DEVELOPMENT DRAWINGS ONLY NOT FOR CONSTRUCTION

PROPOSED SHED/TEMPORARY DWELLING FOR BRODIE LANE AT 2 FLORENCE COURT, PONTVILLE

PLUMBING NOTES DATE 02/12/22 **MENDED** SCALE 1:100 DRAWING NO. 07 OF 07



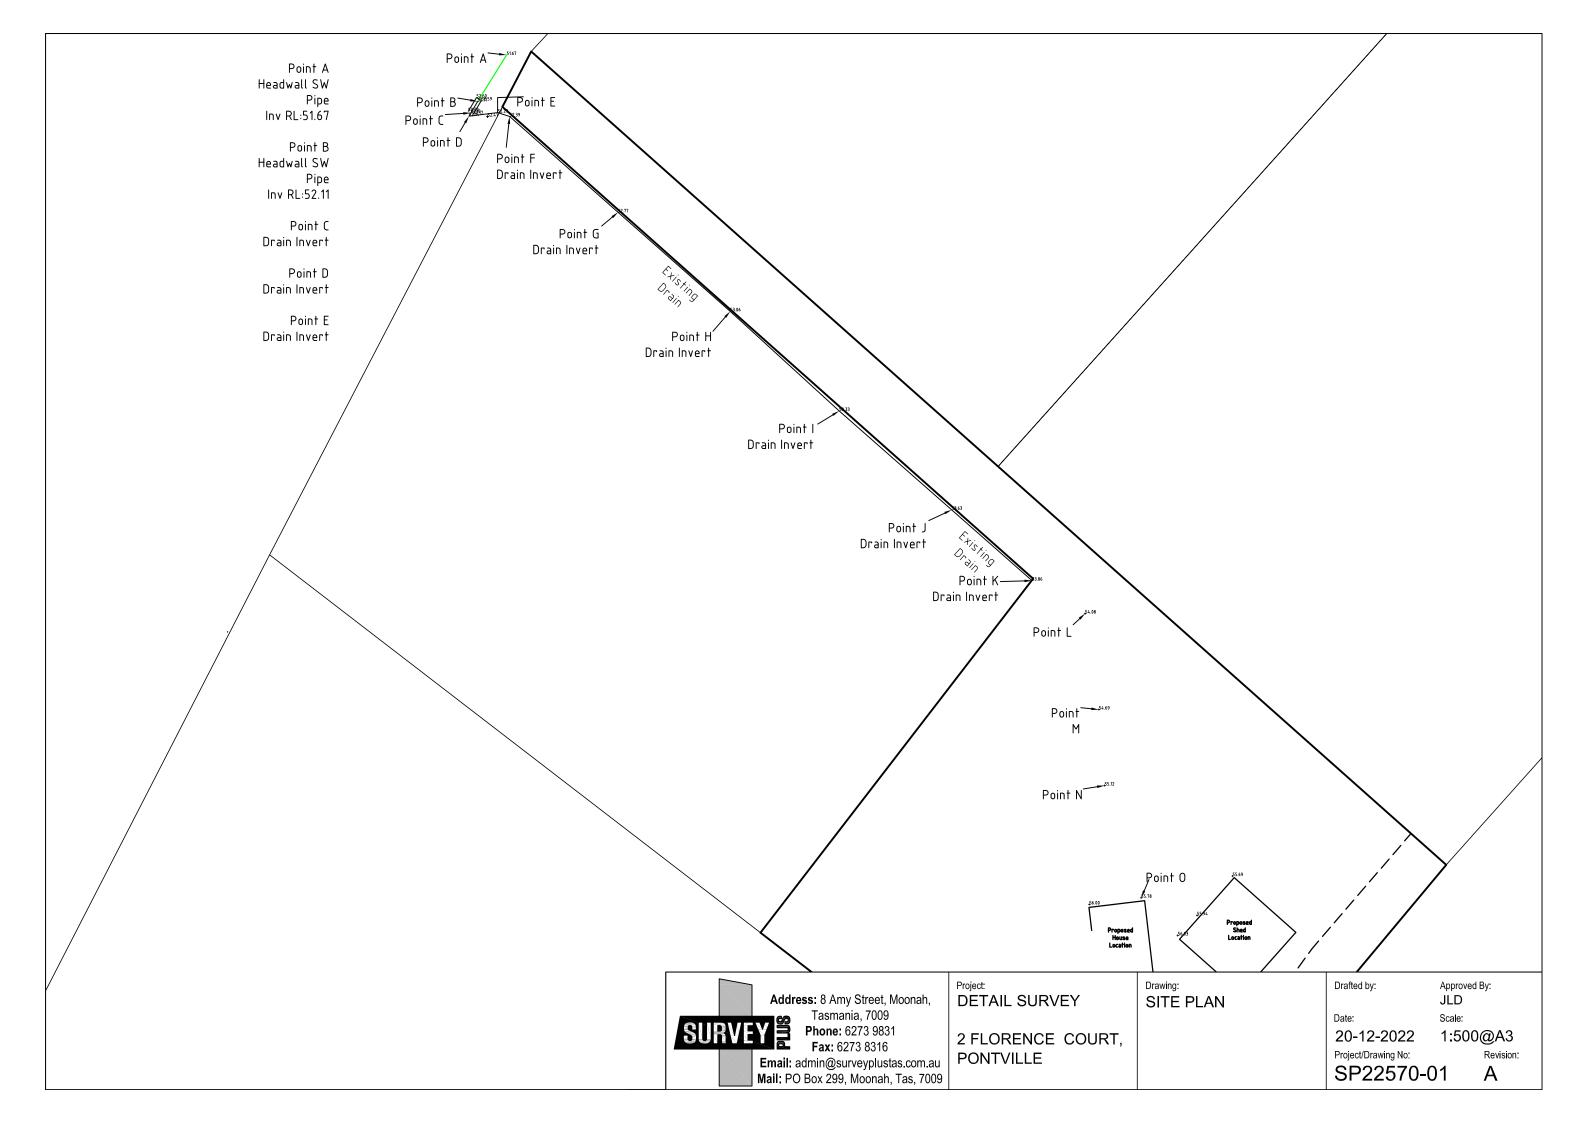

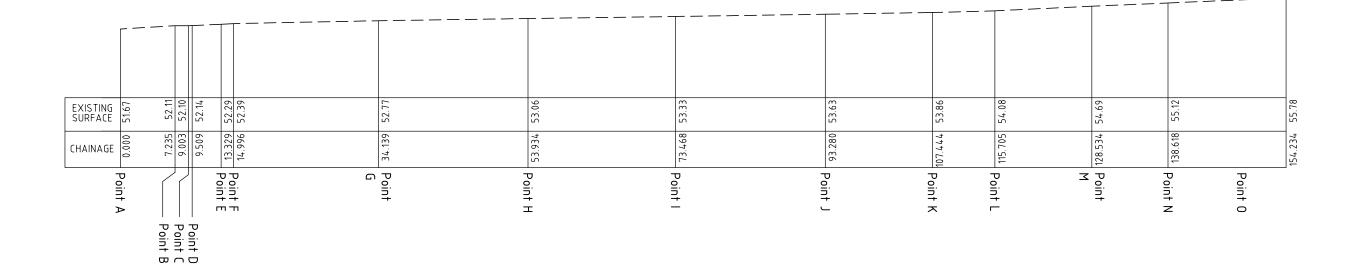

Address: 8 Amy Street, Moonah, Tasmania, 7009 **Phone:** 6273 9831 **Fax:** 6273 8316

2 FLORENCE COURT, PONTVILLE Email: admin@surveyplustas.com.au Mail: PO Box 299, Moonah, Tas, 7009

DETAIL SURVEY

Drawing: LONGITUDINAL SECTION


Drafted by: JLD Approved By: JLD

1:500@A3

Α

20-12-2022

Project/Drawing No: SP22570-02

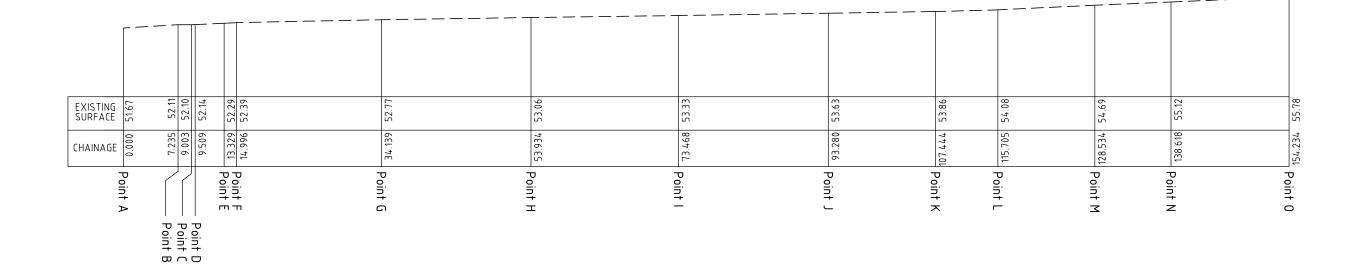

Address: 8 Amy Street, Moonah, Tasmania, 7009 **Phone:** 6273 9831 **Fax:** 6273 8316

Email: admin@surveyplustas.com.au Mail: PO Box 299, Moonah, Tas, 7009

DETAIL SURVEY

2 FLORENCE COURT, PONTVILLE

Drawing: LONGITUDINAL SECTION

Drafted by: JLD


Approved By: JLD

20-12-2022

1:500@A3 Project/Drawing No:

SP22570-02

Α

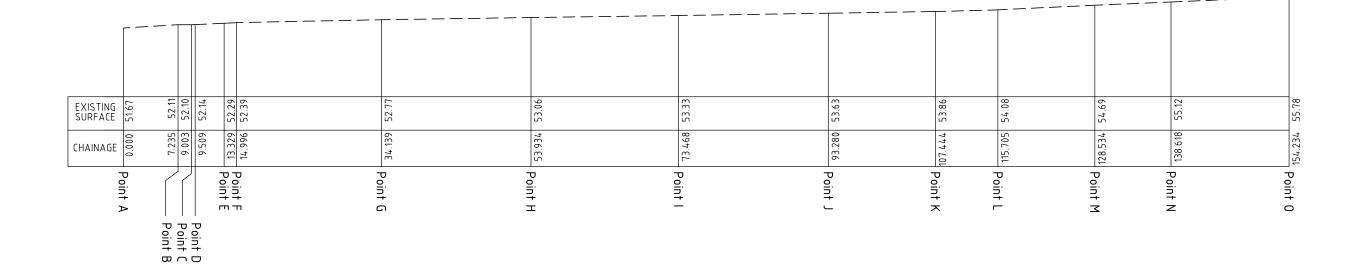

Address: 8 Amy Street, Moonah, Tasmania, 7009 **Phone:** 6273 9831 **Fax:** 6273 8316

Email: admin@surveyplustas.com.au Mail: PO Box 299, Moonah, Tas, 7009

DETAIL SURVEY

2 FLORENCE COURT, PONTVILLE

Drawing: LONGITUDINAL SECTION

Drafted by: JLD

Approved By: JLD

20-12-2022

1:500@A3 Project/Drawing No:

SP22570-02

Α